

APPROVED AS TO IMPACT ON STATE FACILITIES AND CONFORMANCE WITH APPLICABLE STATE STANDARDS AND PRACTICES AND THAT TECHNICAL OVERSIGHT WAS PERFORMED.

DATE SIGNED

LICENSE Exp DATE

REGISTRATION No.

CALTRANS DESIGN OVERSIGHT APPROVAL

CONSULTANT DESIGN ENGINEER

**INDEX OF SHEETS  
ROAD PLANS**

SHEET No.	1	TITLE SHEET
	2	TYPICAL CROSS SECTIONS
	3	LAYOUT
	4-5	PROFILE AND SUPERELEVATION
	6-8	CONSTRUCTION DETAILS
	9	CONTOUR GRADING
	10	CONSTRUCTION AREA SIGNS
	11-15	STAGE CONSTRUCTION & TRAFFIC HANDLING
	16	EROSION CONTROL
	17	SUMMARY OF QUANTITIES

**STRUCTURE PLANS**

18-32	FREESTONE FLATE BRIDGE No. XX-XXXX
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THE STANDARD PLANS LIST APPLICABLE TO THIS CONTRACT IS INCLUDED IN THE NOTICE TO BIDDERS AND SPECIAL PROVISIONS BOOK.

**COUNTY OF SONOMA  
DEPARTMENT OF TRANSPORTATION  
AND PUBLIC WORKS**

PROJECT PLANS FOR CONSTRUCTION ON

**FREESTONE FLAT ROAD  
BRIDGE REPLACEMENT**


EXISTING BRIDGE NO. 20C0440

NEW BRIDGE NO. xxxxx

FEDERAL PROJECT NUMBER BRLO-5920 (127)

LOCATED 4 MILES SOUTHWEST OF THE CITY OF SEBASTOPOL

TO BE SUPPLEMENTED BY THE STATE OF CALIFORNIA STANDARD PLANS DATED 2015

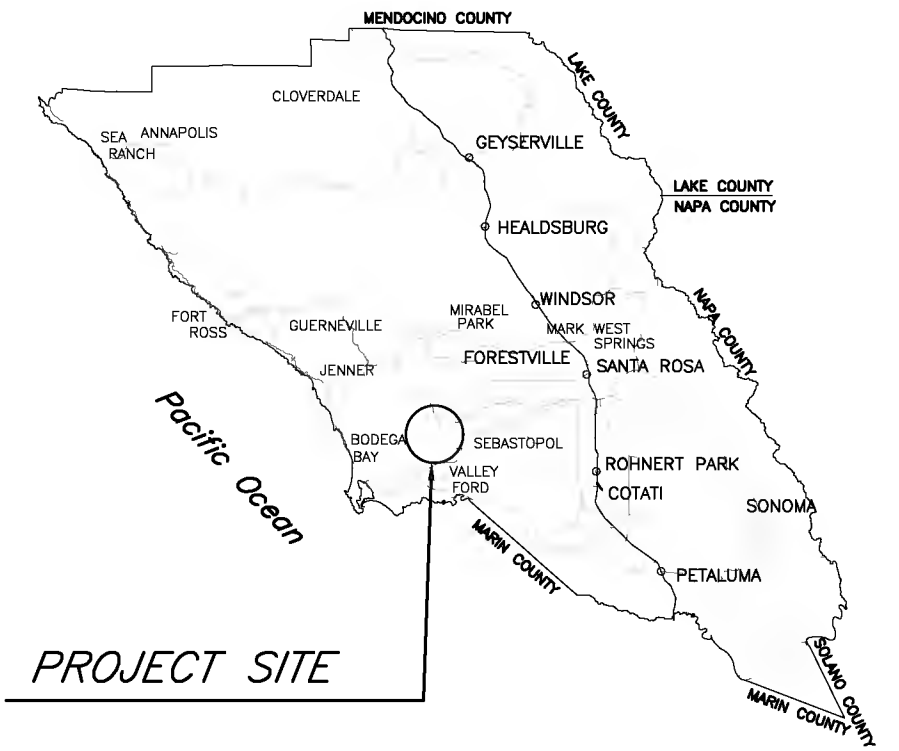

**PROJECT SITE**

VERTICAL DATUM:

BASIS OF BEARINGS:

CALIFORNIA COORDINATE SYSTEM ZONE II, 1927 NORTH AMERICA DATUM PER MAP ENTITLED 'COUNTY OF SONOMA STONY POINT ROAD CONTROL SURVEY, 1971'. BOOK 180 OF MAPS PAGES 17 AND 18, SONOMA COUNTY RECORDS.

RIGHT OF WAY DETERMINATION:

FOR ROAD RIGHT OF WAY DETERMINATION, SEE RECORD OF SURVEY RECORDED IN BOOK XX OF MAPS AT PAGE XX.

NOTE:


THE CONTRACTOR SHALL POSSESS CLASS A LICENSE AND HAZARDOUS SUBSTANCE REMOVAL CERTIFICATION AT THE TIME OF AWARD.

APPROVED FOR CONSTRUCTION

\_\_\_\_\_  
DIRECTOR DEPARTMENT OF TRANSPORTATION AND PUBLIC WORKS DATE


\_\_\_\_\_  
DEPUTY DIRECTOR DATE

\_\_\_\_\_  
SENIOR CIVIL ENGINEER DATE

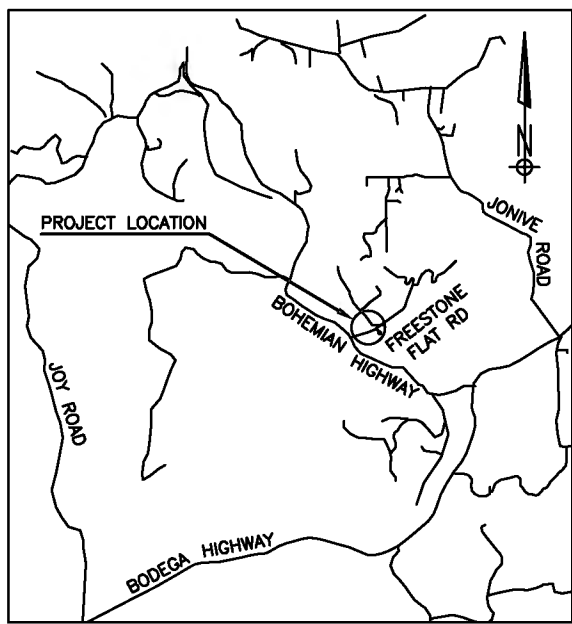


VICINITY MAP  
NOT TO SCALE

THE STANDARD PLANS LIST FOR THIS PROJECT IS INCLUDED IN THE SPECIAL PROVISIONS BOOK.

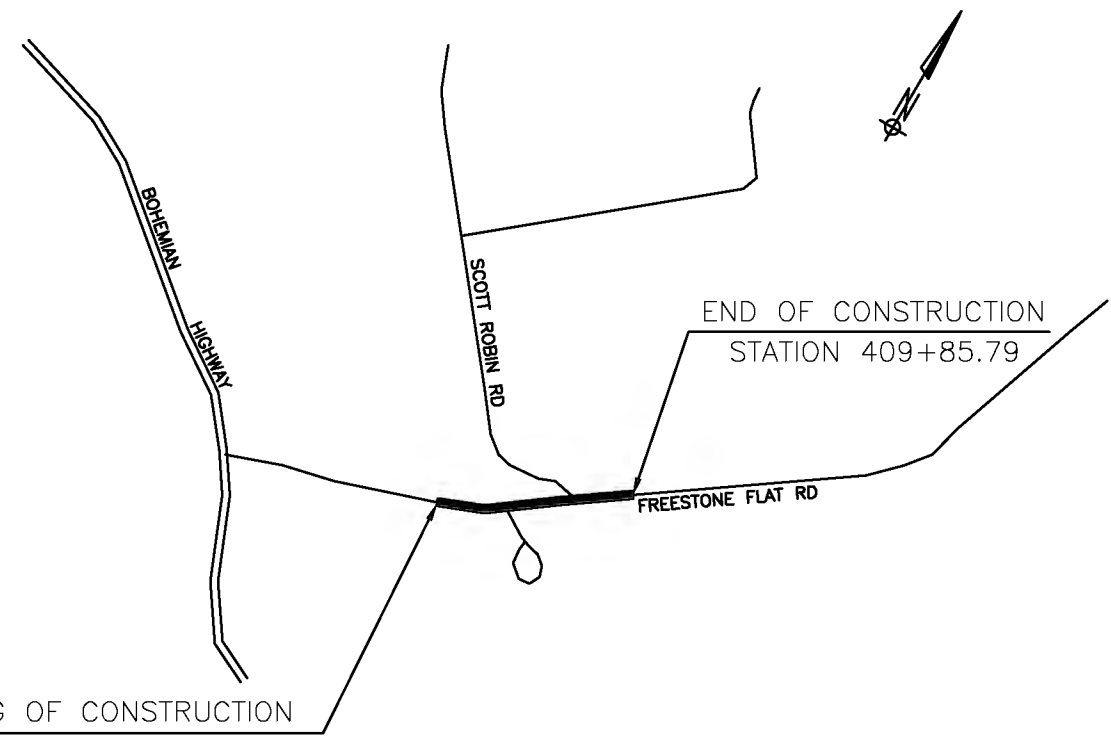

**LAYOUT PLAN**

NOT TO SCALE

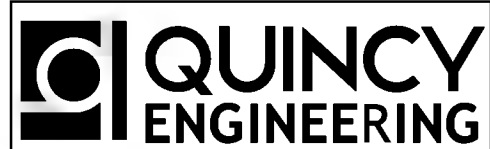

"AS BUILT" INFORMATION TO BE COMPLETED AFTER CONSTRUCTION	
DATE	BY

CONSTRUCTION COMPLETED:

RESIDENT ENGINEER AS BUILT DRAWINGS BY:

TITLE SHEET	
ROAD NUMBER	9999A
BUDGET NUMBER	09999
FISCAL YEAR	20XX-YY
SHEET NUMBER	1
TOTAL SHEETS	32

**FREESTONE FLAT ROAD  
BRIDGE REPLACEMENT**

**NOTES:**

1. DIMENSIONS OF THE PAVEMENT STRUCTURES (STRUCTURAL SECTIONS) ARE SUBJECT TO TOLERANCES SPECIFIED IN THE STANDARD SPECIFICATIONS.
2. SUPERELEVATIONS ARE SHOWN ON THE SUPERELEVATION DIAGRAM.

**ABBREVIATIONS:**


SR SUPERELEVATION RATE

**DESIGN DESIGNATION  
(FREESTONE FLAT RD)**


ADT (2009) = 96  
 AADT (2029) = 150  
 V = 40 MPH  
 TI = 10

**DESIGN DESIGNATION  
(SCOTT ROBIN RD)**


V = 20 MPH

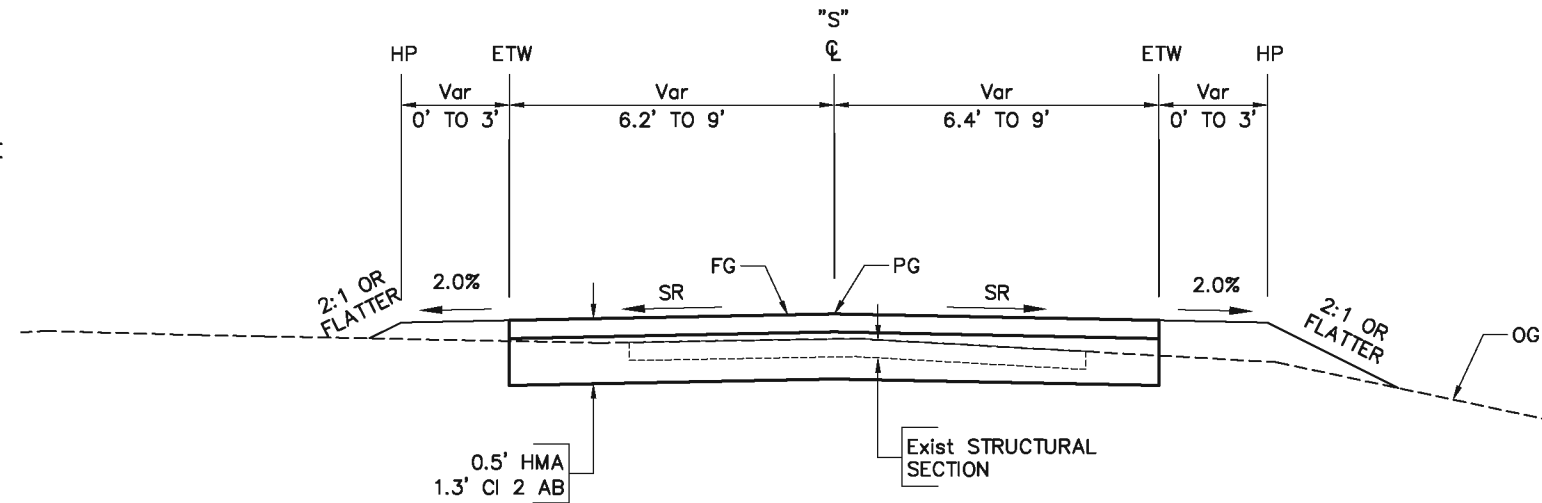


**SCOTT ROBIN ROAD**  
 STA "S" 1+00.00 TO STA "S" 3+03.37

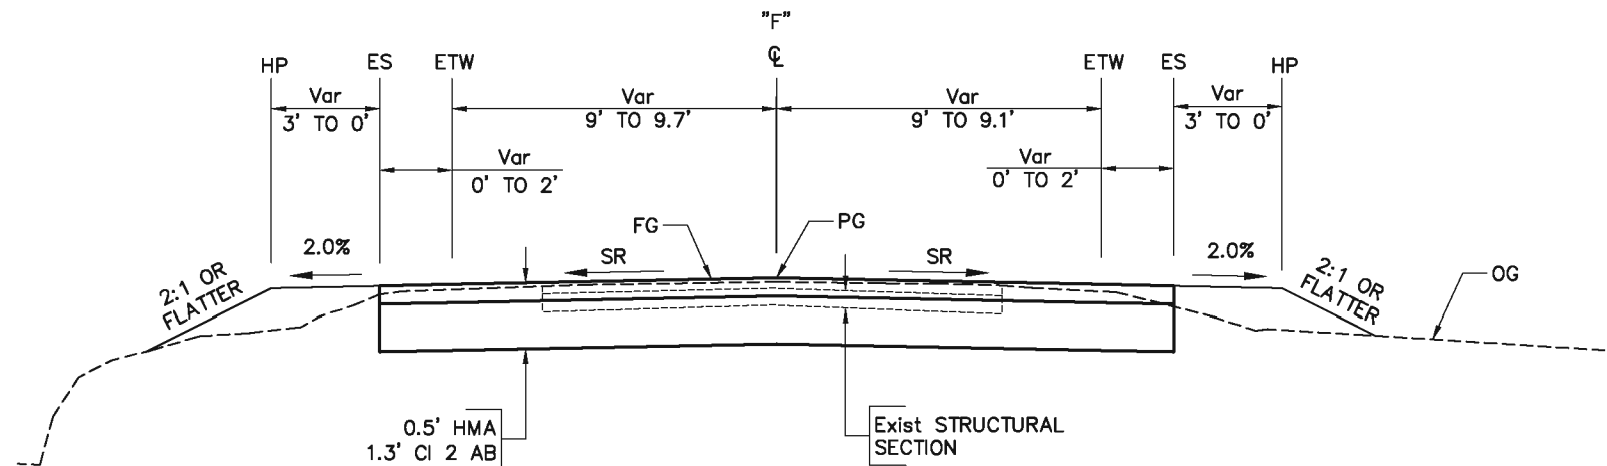


**FREESTONE FLAT ROAD**  
 STA "F" 406+89.66 (EB) TO STA "F" 409+85.79

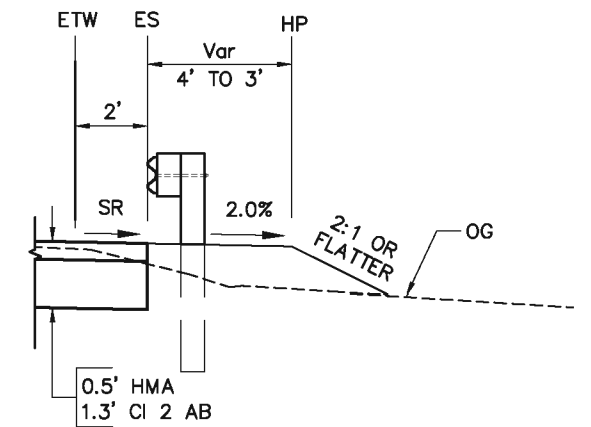

**FREESTONE FLAT ROAD**  
 STA "F" 407+10.99 TO STA "F" 408+10.00

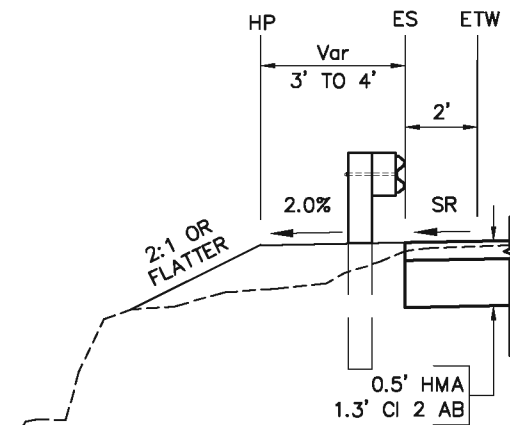

**FREESTONE FLAT ROAD**  
 STA "F" 404+60.00 TO STA "F" 405+58.33

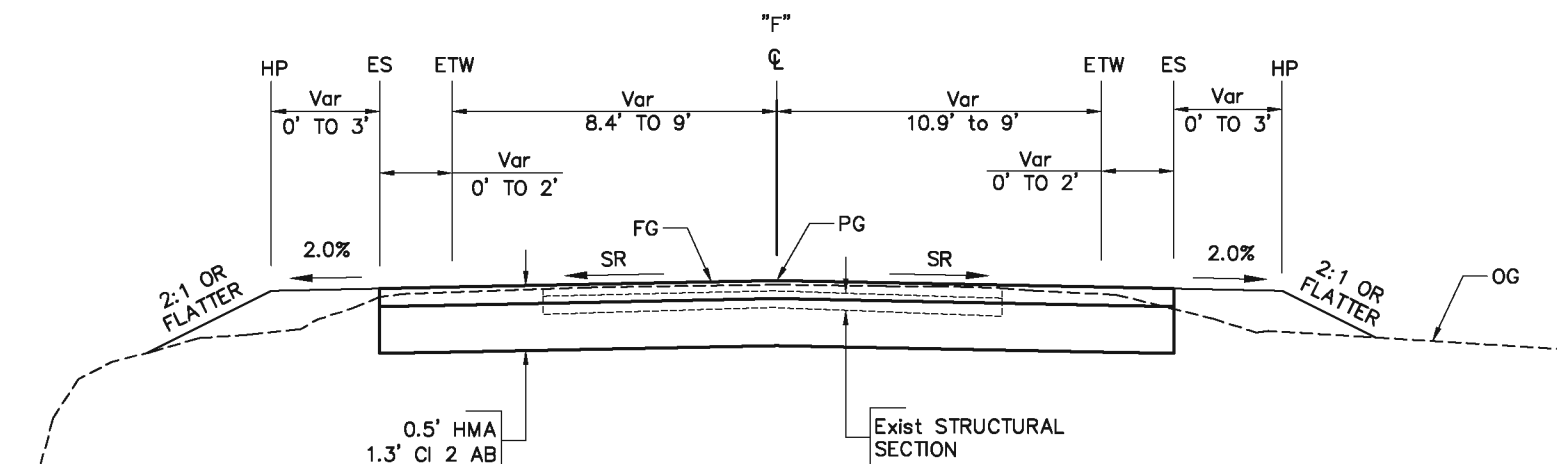

**FREESTONE FLAT ROAD**  
 STA "F" 403+66.78 TO STA "F" 405+81.33 (BB)

65% SUBMITTAL

DESIGN BY	B.GRIMM
DRAWING BY	B.GRIMM
CHECKED BY	DES CHK

REGISTERED CIVIL ENGINEER  
 1/31/2018  
 PLANS APPROVAL DATE  
 S:\CLIENT\SONOMA COUNTY - S22\FREESTONE FLAT ROAD\S22-200\CAD\ROADWAY\S22-200\_XS-1.DWG 1/31/2018 9:53 AM












CONSTRUCTION COMPLETED:	
"AS BUILT" INFORMATION TO BE COMPLETED AFTER CONSTRUCTION	
DATE	BY
	APPROVED

**QUINCY ENGINEERING, INC.**  
 11017 Cobblerock Drive, Suite 100  
 Sacramento, CA 95670

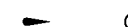**COUNTY OF SONOMA**  
 DEPARTMENT OF TRANSPORTATION & PUBLIC WORKS  
 SUSAN KLASSEN, DIRECTOR

TYPICAL CROSS SECTIONS	
FREESTONE FLAT ROAD BRIDGE REPLACEMENT	
ROAD NUMBER	XXX
BUDGET NUMBER	XXX
FISCAL YEAR	2015-16
SHEET NUMBER	2
TOTAL SHEETS	32


**LEGEND:**

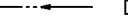-  FLOW LINE
-  PAVEMENT DELINEATION DETAIL
-  OBJECT MARKER (TYPE P(CA))
-  12" WHITE THERMOPLASTIC PAVEMENT MARKING
-  EXISTING R/W
-  PROPOSED R/W
-  PROPOSED TEMPORARY CONSTRUCTION EASEMENT (TCE)
-  "STOP" THERMOPLASTIC PAVEMENT MARKING
-  DIRECTION OF FLOW
-  REMOVE ROADSIDE SIGN
-  ROADSIDE SIGN SINGLE POST

**ABBREVIATIONS:**

AITs - ALTERNATIVE IN-LINE TERMINAL SYSTEM


CURVE DATA				
NO.	R	Δ	T	L
C1	800.00	24° 01' 18"	170.20	335.41
C2	1200.00	5° 07' 19"	53.67	107.27
C3	100.00	51° 07' 46"	47.84	89.24
C4	90.00	61° 19' 00"	53.35	96.32

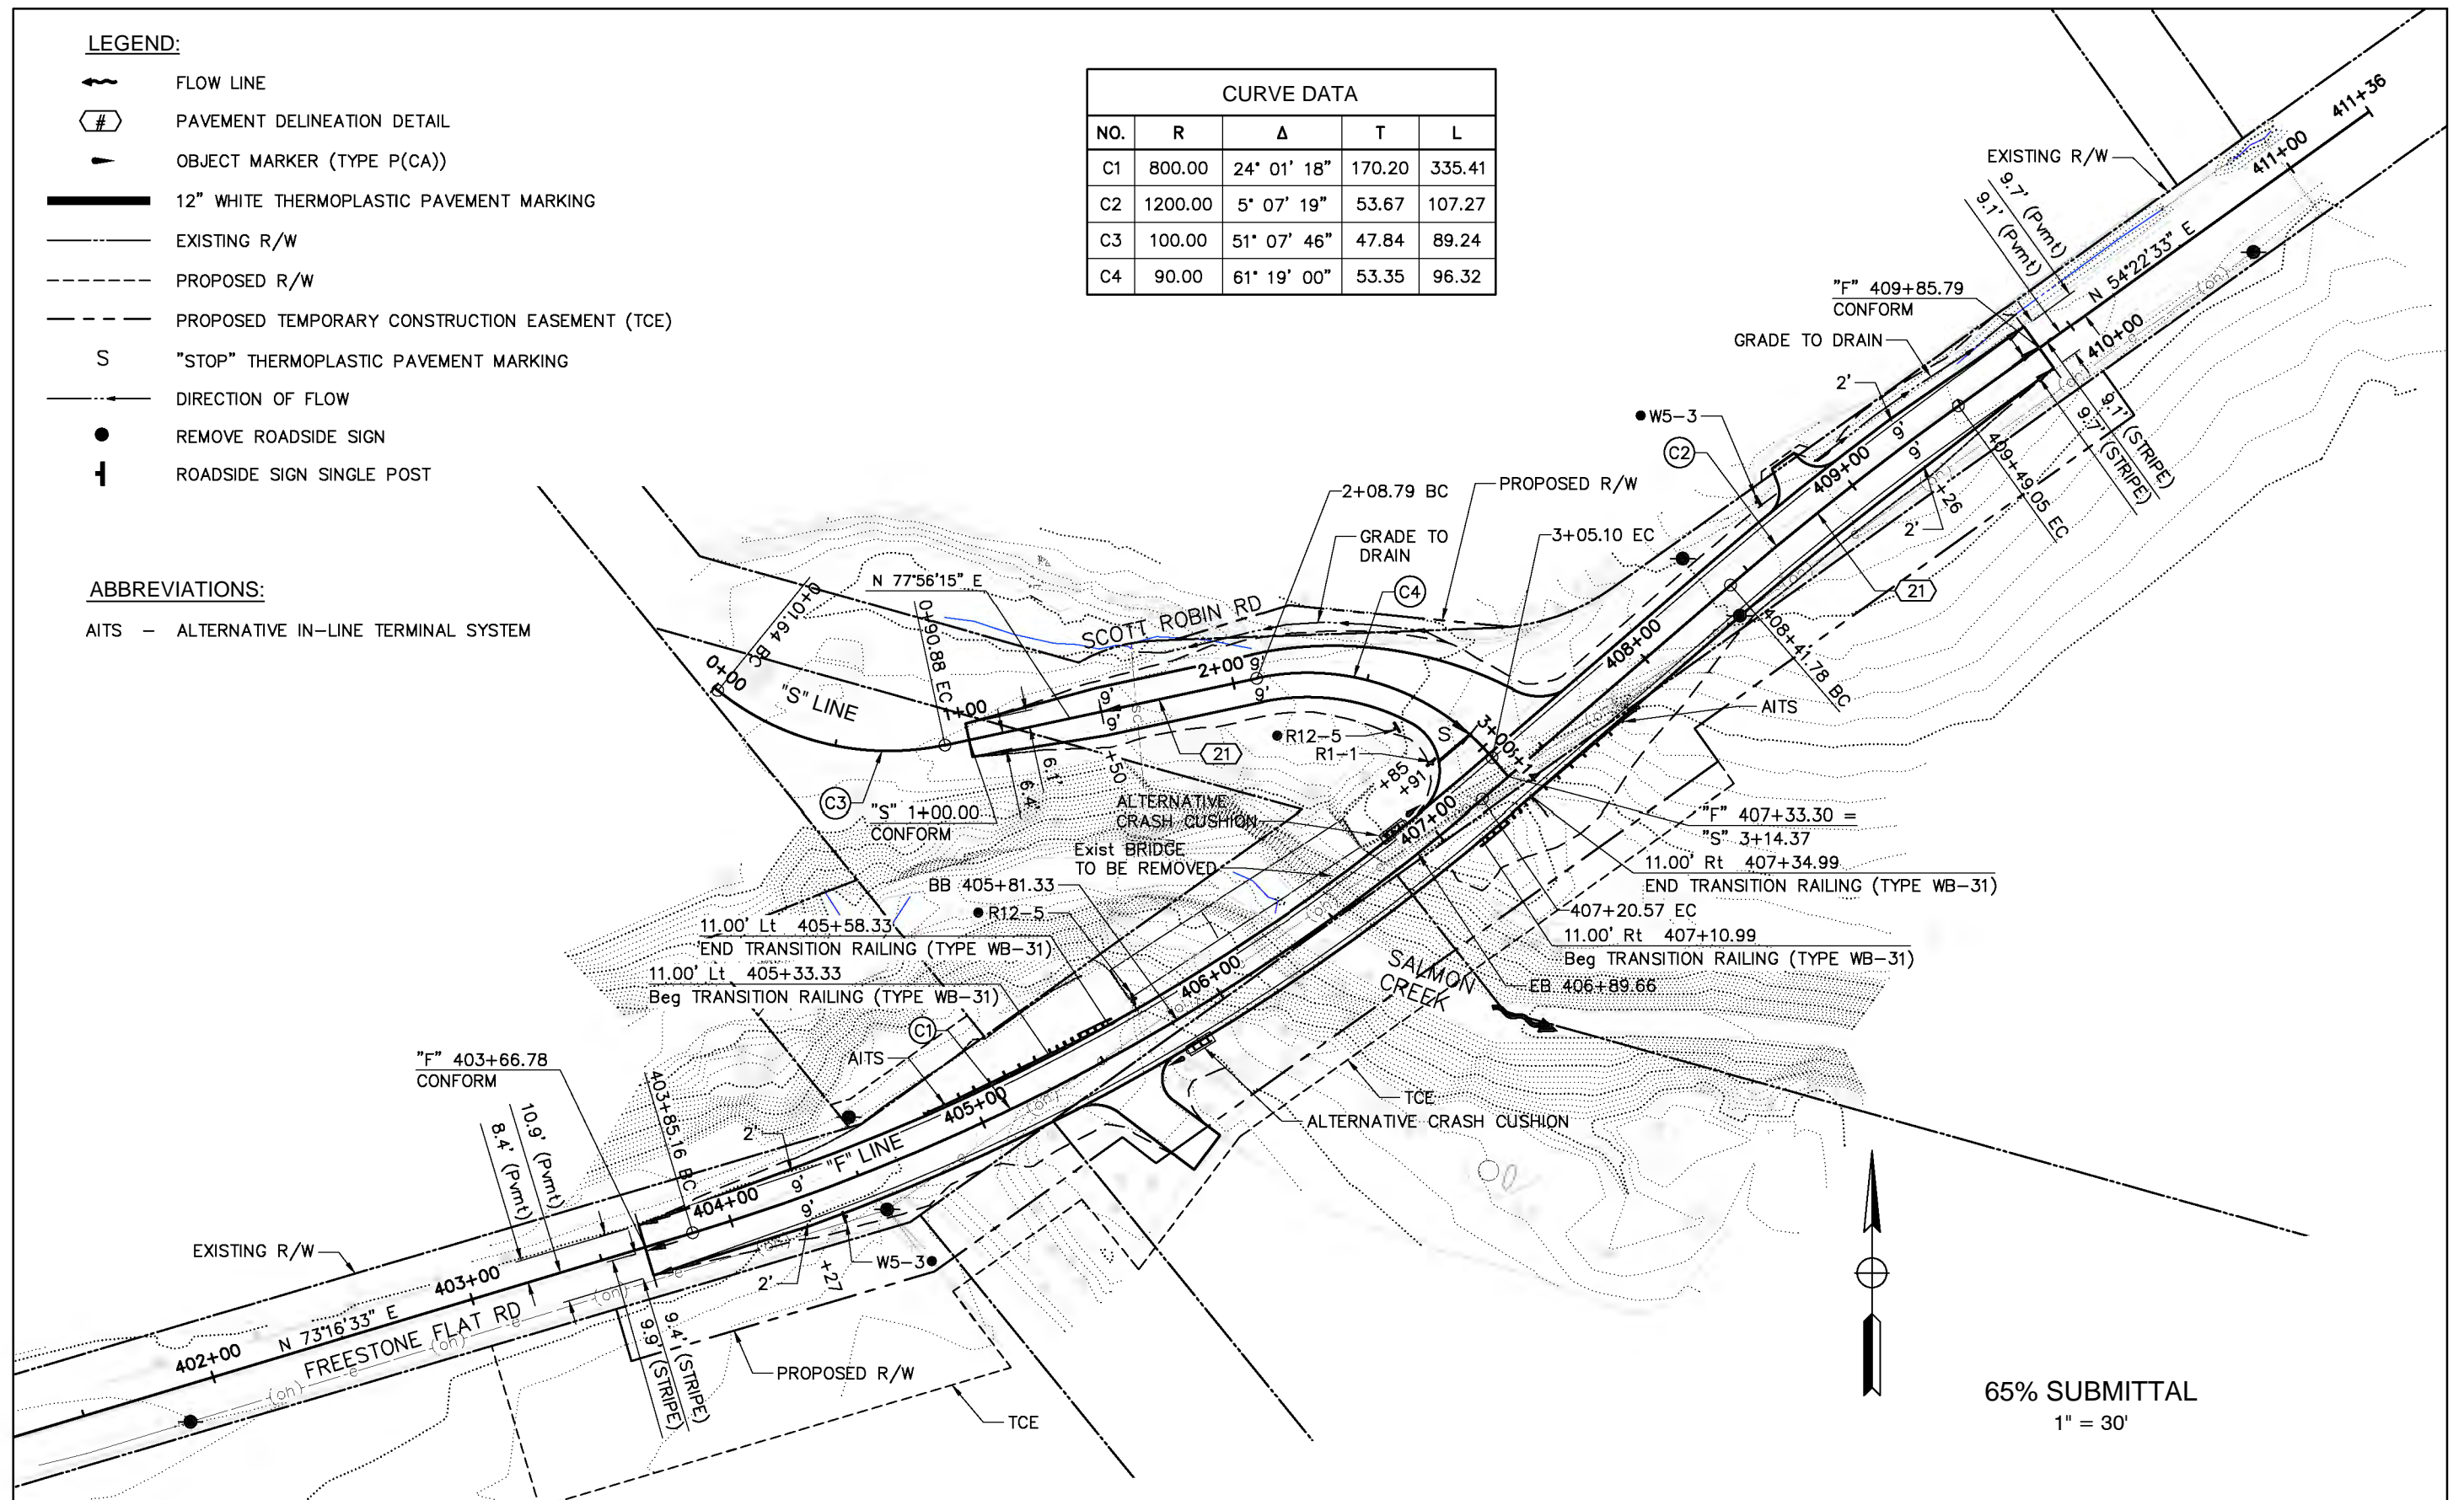

65% SUBMITTAL  
1" = 30'

DESIGN BY	B. GRIMM
DRAWING BY	B. GRIMM
CHECKED BY	M. SANCHEZ

REGISTERED CIVIL ENGINEER  
1/21/2018  
PLANS APPROVAL DATE  
S:\CLIENT\SONOMA COUNTY - S22\FREESTONE FLAT ROAD  
S22-200\CAD\ROADWAY\S22-200\_L-1.DWG 1/31/2018  
9:53 AM

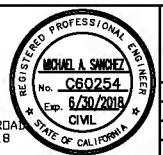


CONSTRUCTION COMPLETED	
DATE	BY

\*AS BUILT\* INFORMATION TO BE COMPLETED AFTER CONSTRUCTION

RESIDENT ENGINEER AS BUILT DRAWINGS BY:


**QUINCY ENGINEERING, INC.**  
11017 Cobblerock Drive, Suite 100  
Sacramento, CA 95670

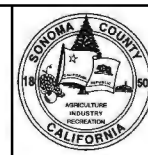

**COUNTY OF SONOMA**  
DEPARTMENT OF TRANSPORTATION & PUBLIC WORKS  
SUSAN KLASSEN, DIRECTOR

LAYOUT  
**FREESTONE FLAT ROAD  
BRIDGE REPLACEMENT**

ROAD NUMBER	XXX
BUDGET NUMBER	XXX
FISCAL YEAR	2015-16
SHEET NUMBER	3
TOTAL SHEETS	32

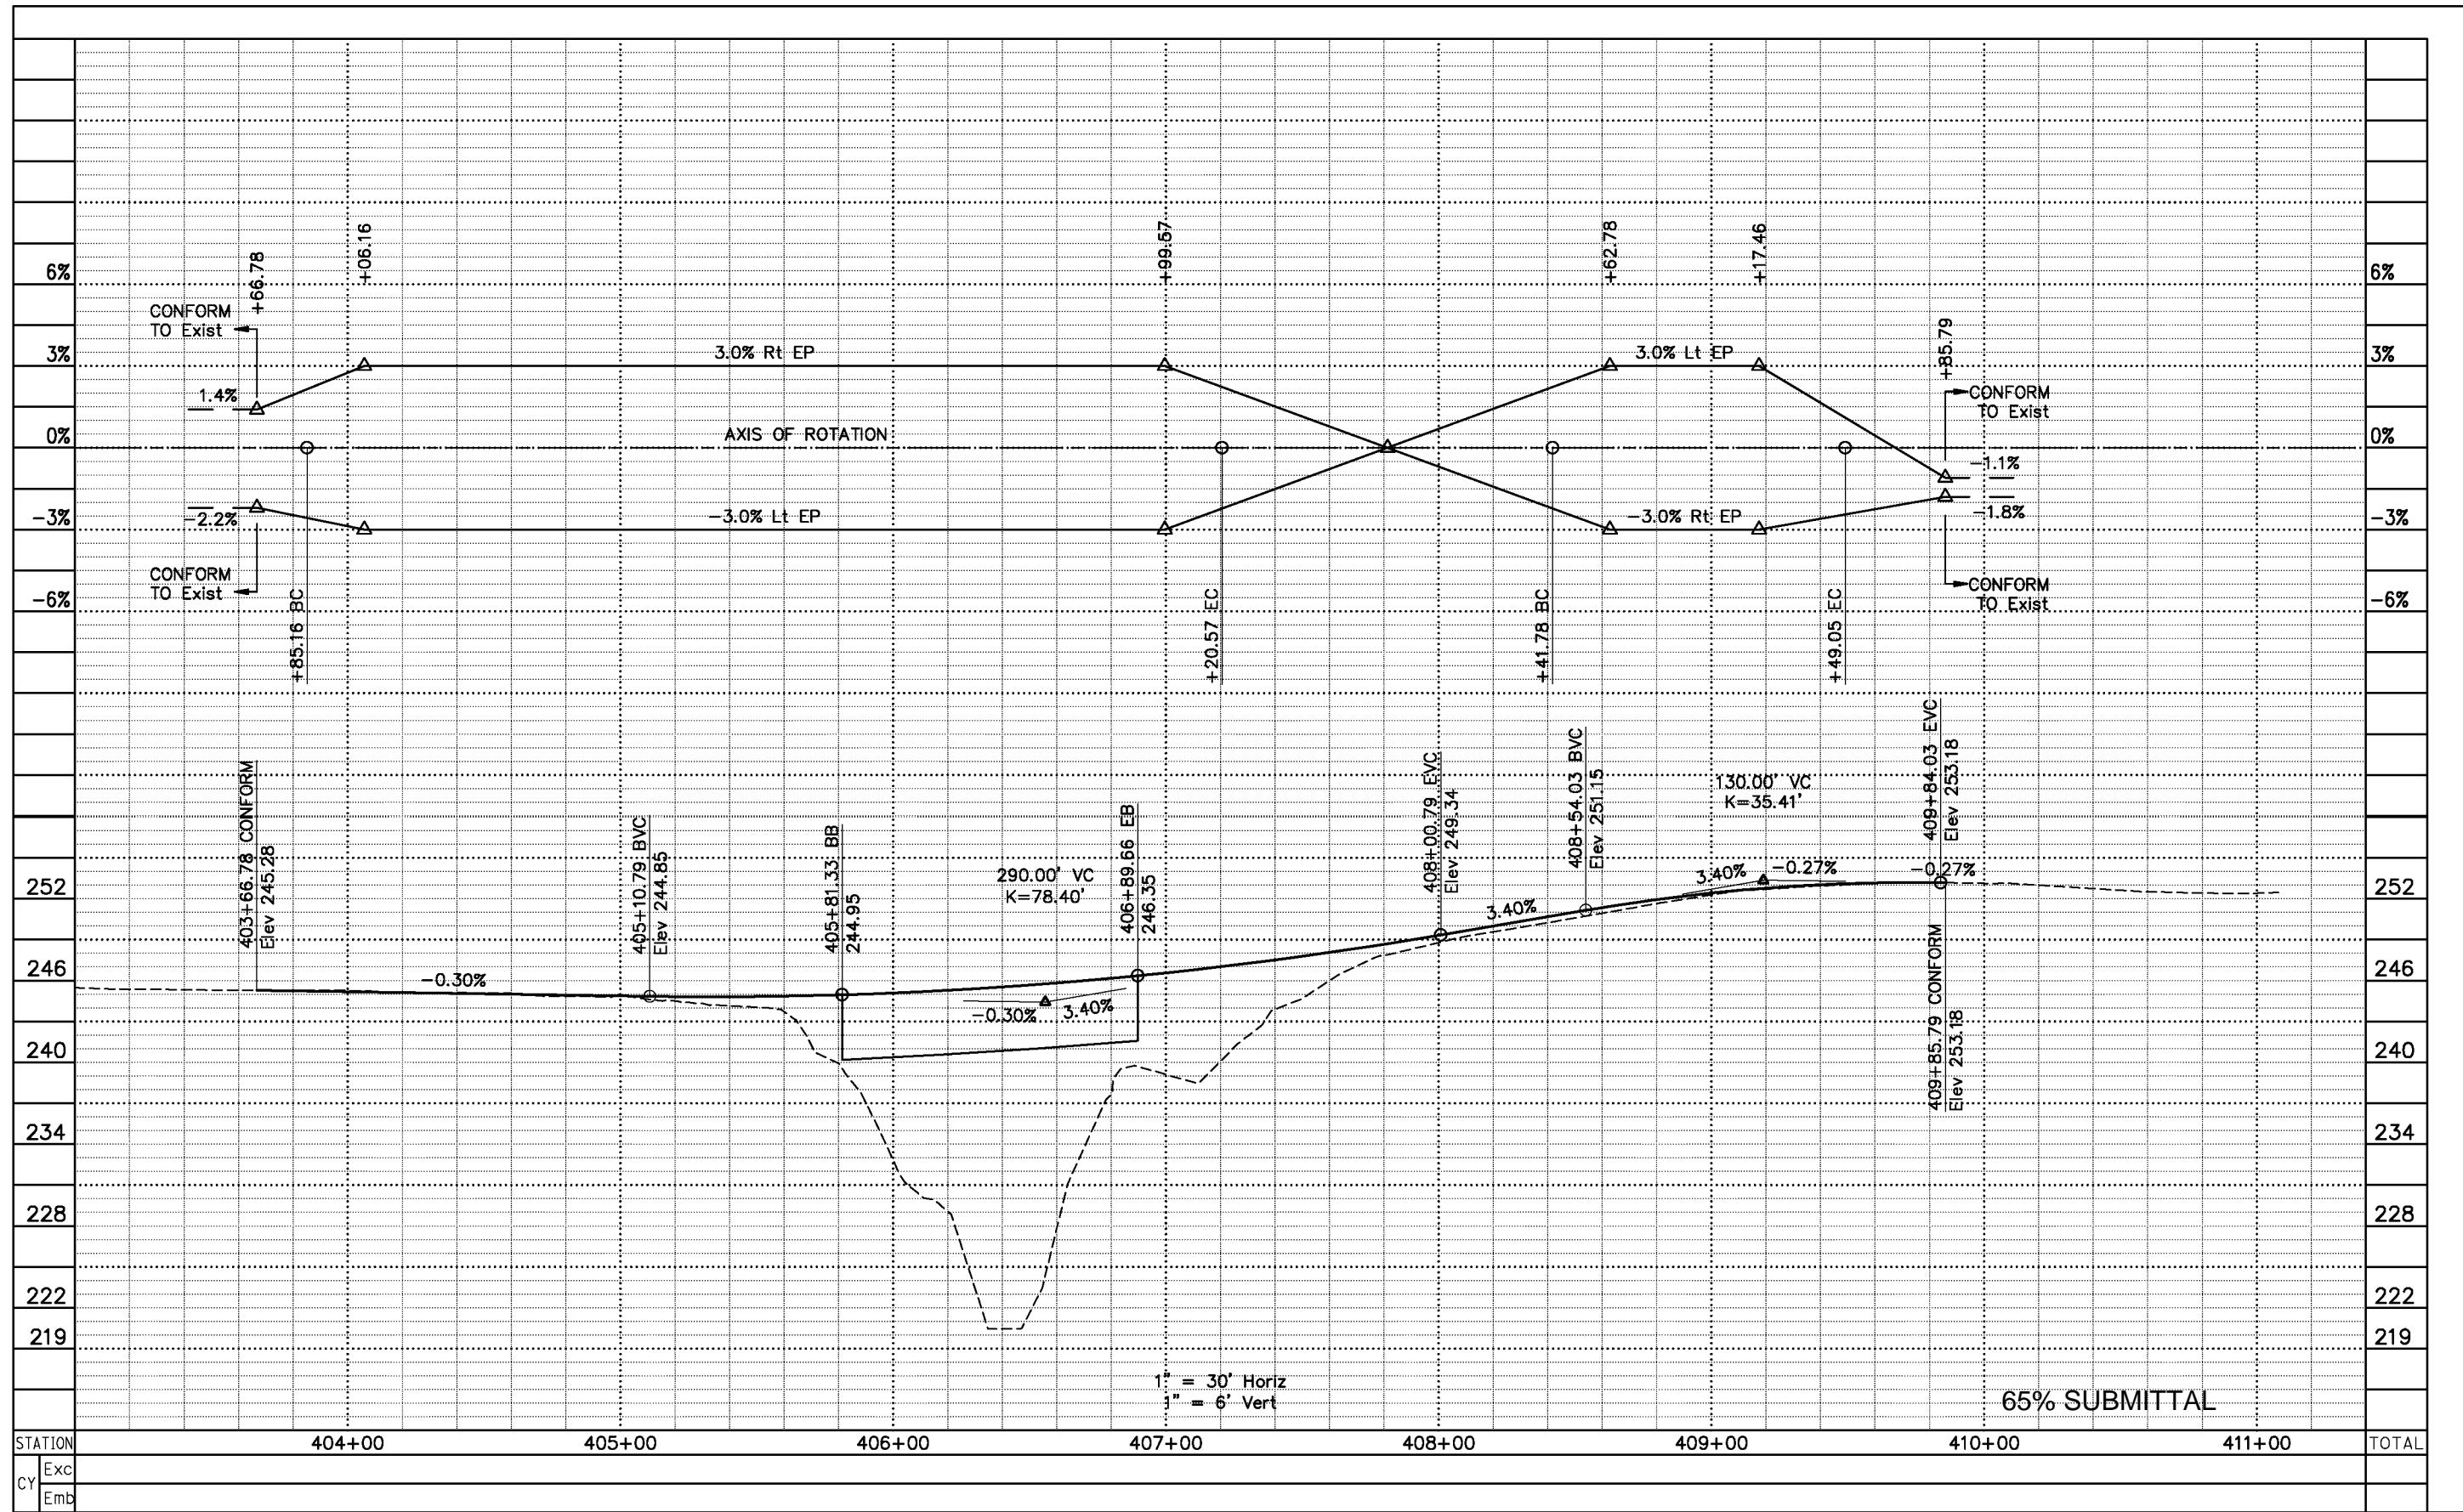

STATION	404+00	405+00	406+00	407+00	408+00	409+00	410+00	411+00	TOTAL
Exc									
Emb									

DESIGN BY **B.GRIMM**  
DRAWING BY **B.GRIMM**  
CHECKED BY **M. SANCHEZ**

**REGISTERED CIVIL ENGINEER**  
**1/21/2018**  
PLANS APPROVAL DATE  
S:\CLIENT\SONOMA COUNTY - S22\FREESTONE FLAT ROAD  
S22-200\CAD\ROADWAY\S22-200\_PS-1.DWG 1/31/2018  
9:54 AM



CONSTRUCTION COMPLETED  
"AS BUILT" INFORMATION TO BE COMPLETED AFTER CONSTRUCTION  
RESIDENT ENGINEER AS BUILT DRAWINGS BY:  
DATE BY APPROVED


**QUINCY ENGINEERING, INC.**  
11017 Cobblecreek Drive, Suite 100  
Sacramento, CA 95670



**COUNTY OF SONOMA**  
DEPARTMENT OF TRANSPORTATION & PUBLIC WORKS  
SUSAN KLASSEN, DIRECTOR

PROFILE & SUPERELEVATION  
**FREESTONE FLAT ROAD  
BRIDGE REPLACEMENT**

ROAD NUMBER	XXX
BUDGET NUMBER	XXX
FISCAL YEAR	2015-16
SHEET NUMBER	4
TOTAL SHEETS	32

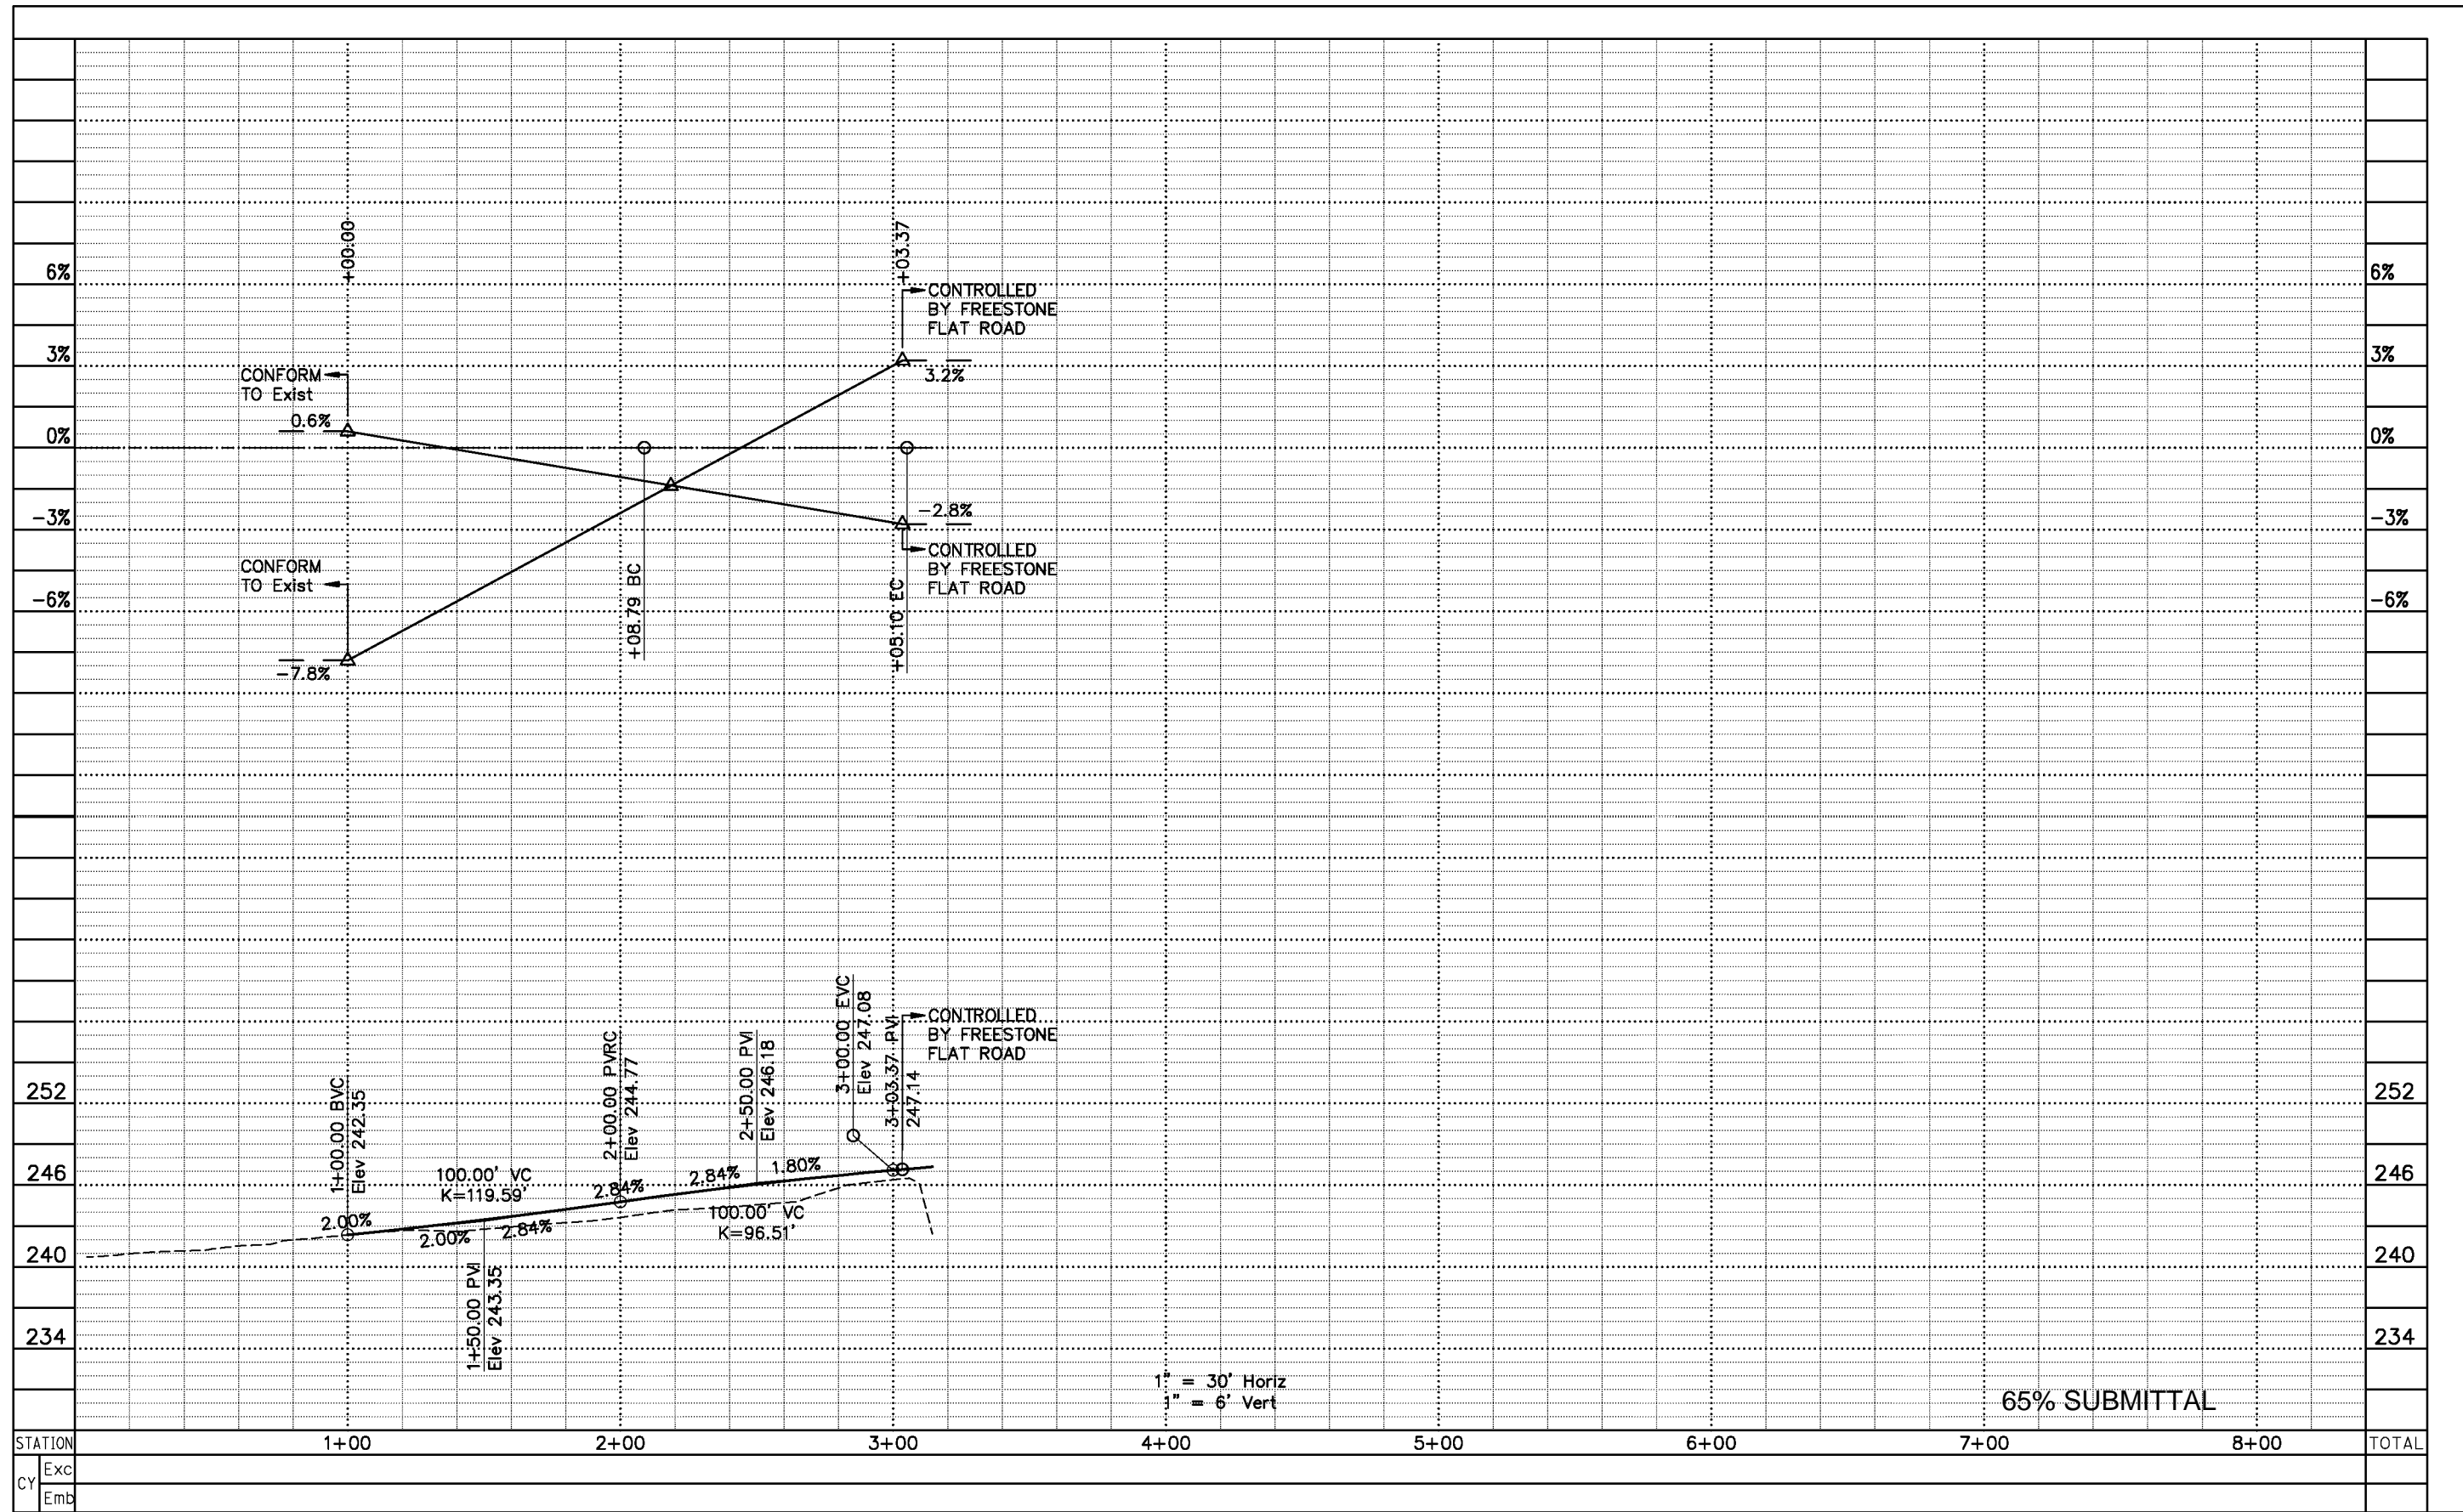

STATION	1+00	2+00	3+00	4+00	5+00	6+00	7+00	8+00	TOTAL
Exc									
Emb									

DESIGN BY **B.GRIMM**  
DRAWING BY **B.GRIMM**  
CHECKED BY **DES CHK**

REGISTERED CIVIL ENGINEER  
**1/21/2018**  
PLANS APPROVAL DATE  
S:\CLIENT\SONOMA COUNTY - S22\FREESTONE FLAT ROAD  
S22-200\CAD\ROADWAY\S22-200\_PS-2.DWG 1/31/2018  
8:54 AM



CONSTRUCTION COMPLETED  
"AS BUILT" INFORMATION TO BE COMPLETED AFTER CONSTRUCTION  
RESIDENT ENGINEER AS BUILT DRAWINGS BY:  
DATE \_\_\_\_\_ BY \_\_\_\_\_ APPROVED \_\_\_\_\_

**QUINCY ENGINEERING, INC.**  
11017 Cobblecreek Drive, Suite 100  
Sacramento, CA 95670







**COUNTY OF SONOMA**  
DEPARTMENT OF TRANSPORTATION & PUBLIC WORKS  
SUSAN KLASSEN, DIRECTOR

PROFILE & SUPERELEVATION  
**FREESTONE FLAT ROAD  
BRIDGE REPLACEMENT**

ROAD NUMBER	XXX
BUDGET NUMBER	XXX
FISCAL YEAR	2015-16
SHEET NUMBER	5
TOTAL SHEETS	32



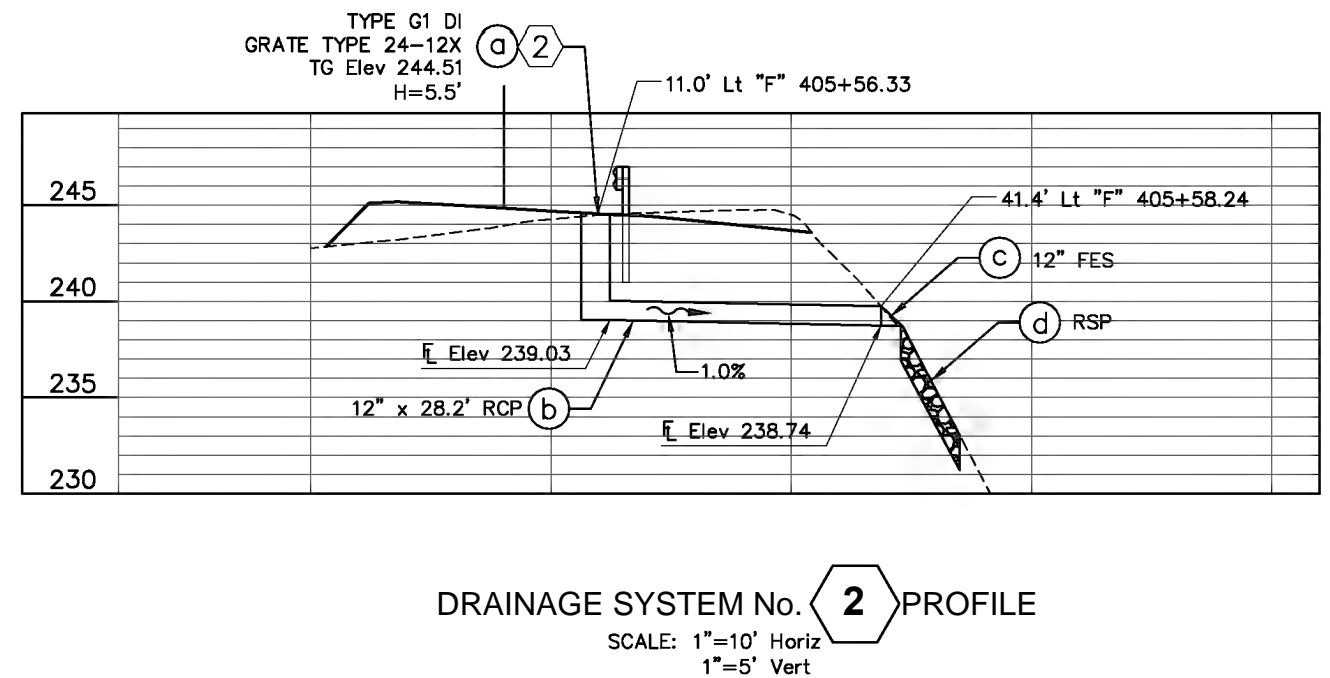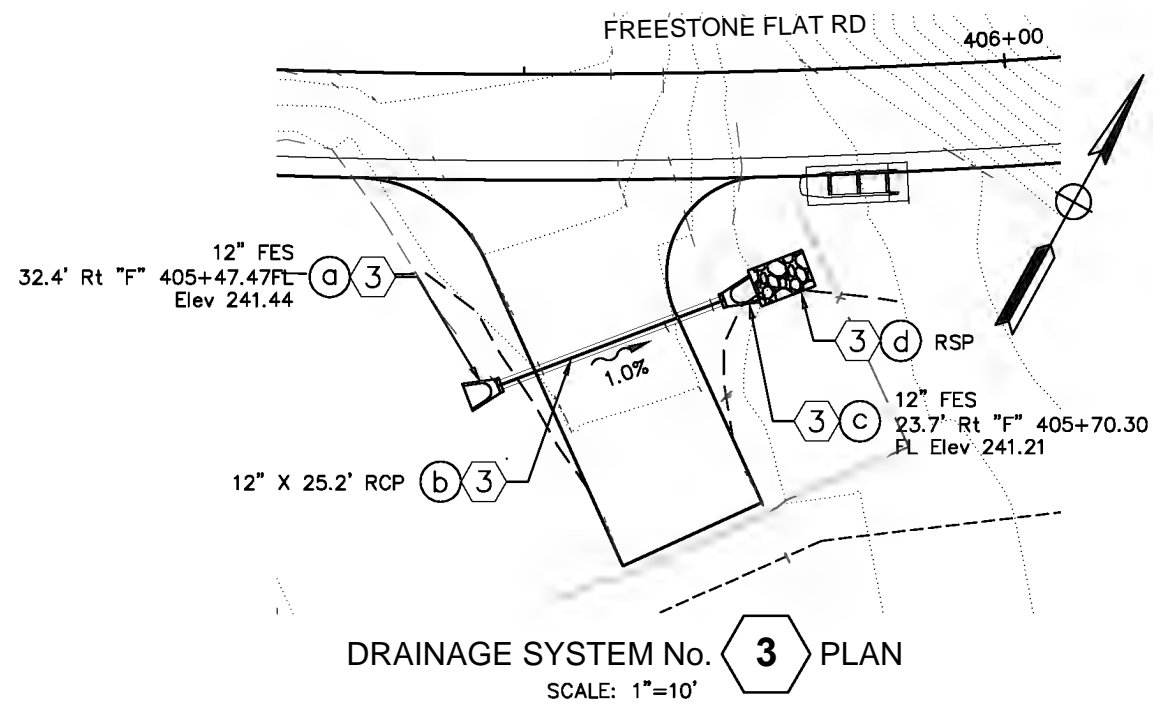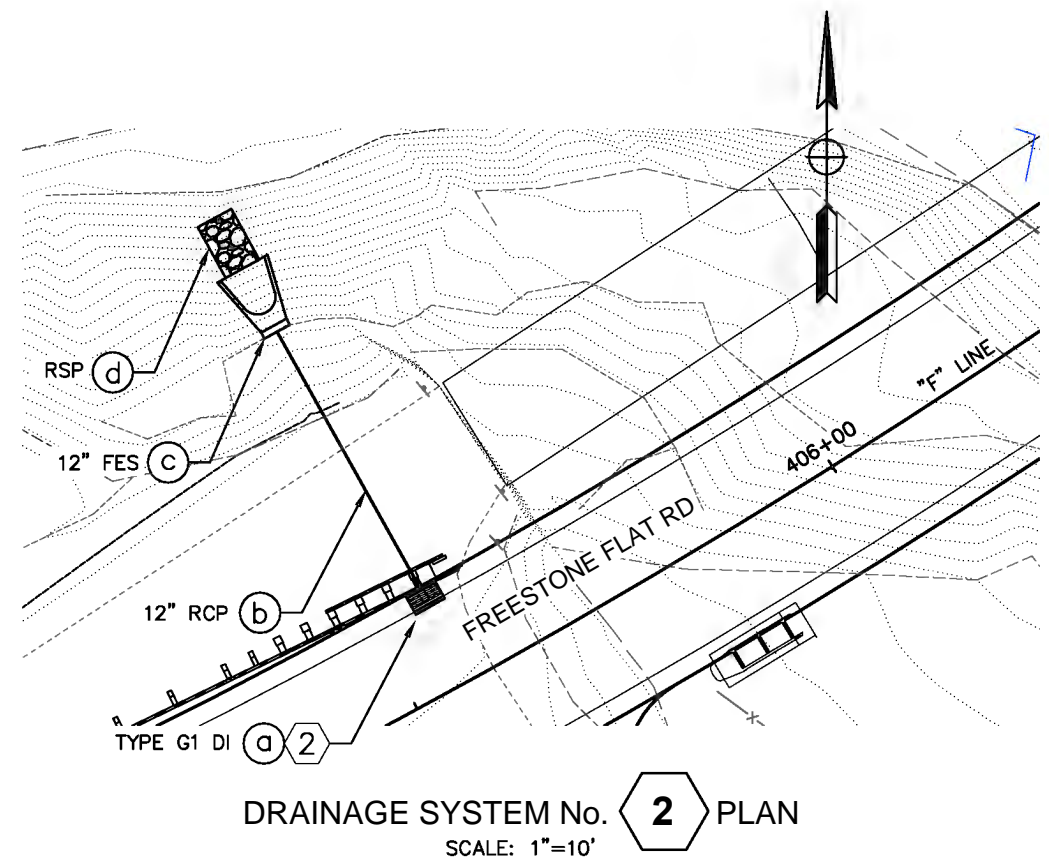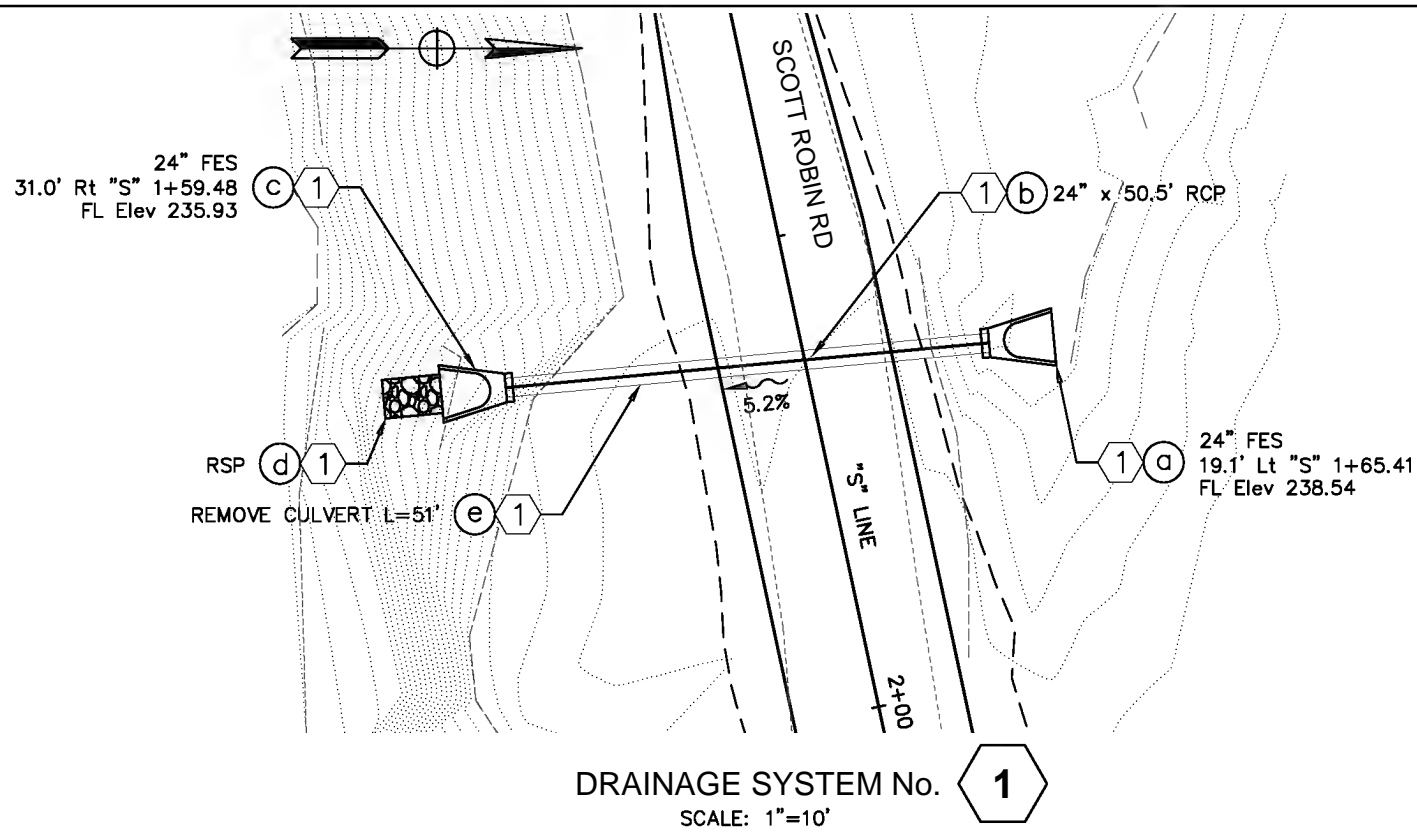

65% SUBMITTAL

DESIGN BY **B.GRIMM**  
DRAWING BY **B.GRIMM**  
CHECKED BY **DES CHK**

REGISTERED CIVIL ENGINEER  
**1/21/2018**  
PLANS APPROVAL DATE  
S:\CLIENT\SONOMA COUNTY - S22\FREESTONE FLAT ROAD  
S22-200\CAD\ROADWAY\S22-200\_C-1.DWG 1/31/2018  
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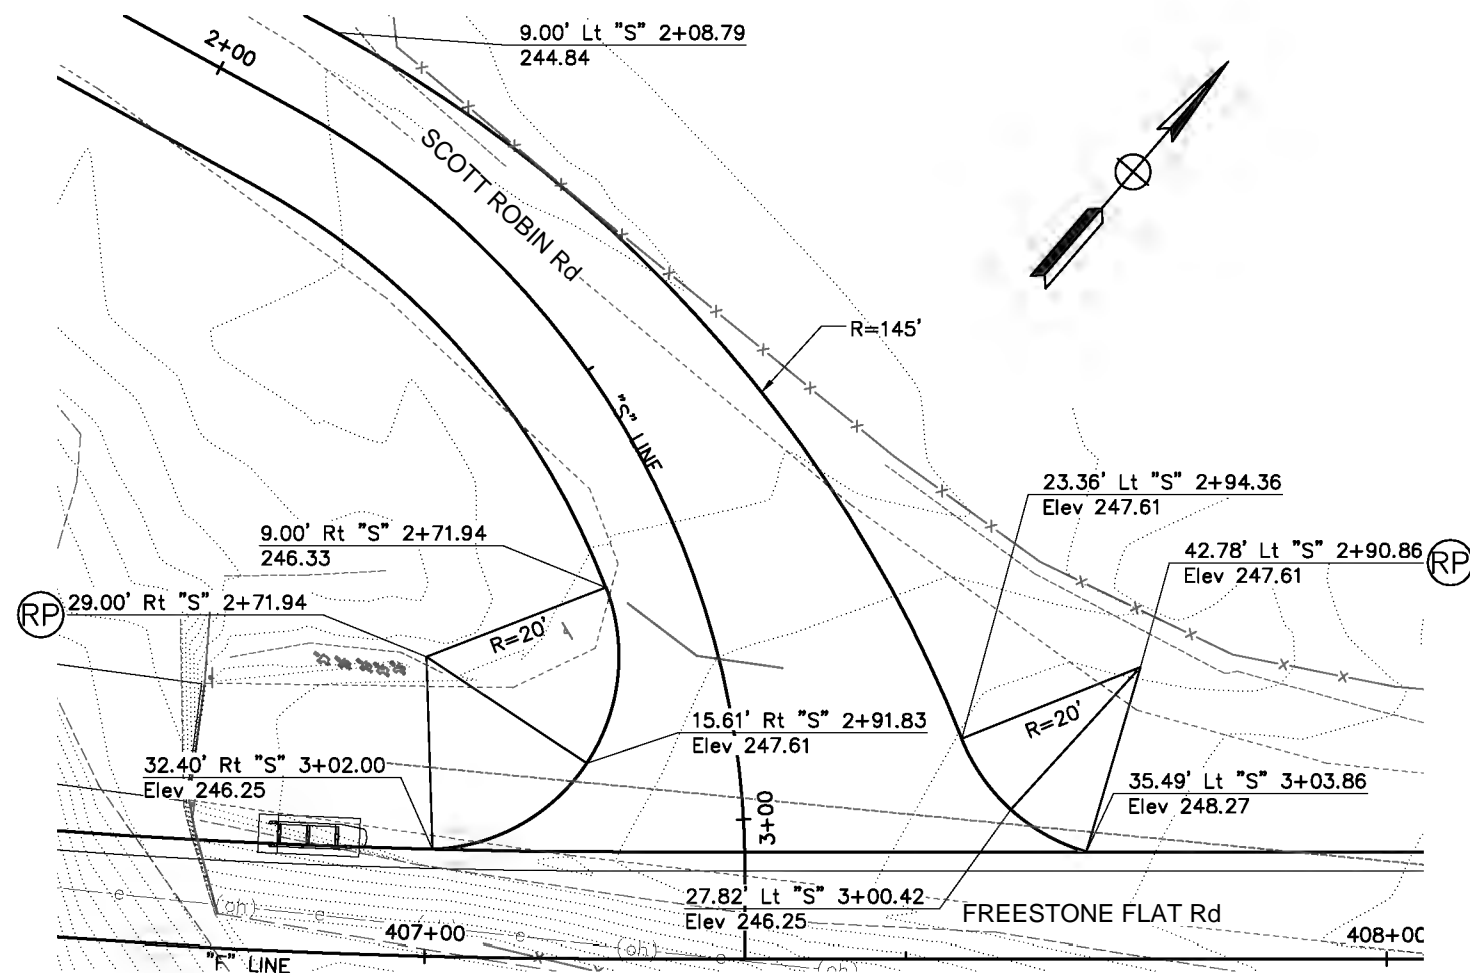
CONSTRUCTION COMPLETED:  
"AS BUILT" INFORMATION TO BE  
COMPLETED AFTER CONSTRUCTION  
RESIDENT ENGINEER  
AS BUILT DRAWINGS BY:  
DATE BY APPROVED

**QUINCY ENGINEERING, INC.**  
11017 Cobblecreek Drive, Suite 100  
Sacramento, CA 95670


**COUNTY OF SONOMA**  
DEPARTMENT OF TRANSPORTATION & PUBLIC WORKS  
SUSAN KLASSEN, DIRECTOR

CONSTRUCTION DETAILS  
**FREESTONE FLAT ROAD  
BRIDGE REPLACEMENT**


ROAD NUMBER	XXX
BUDGET NUMBER	XXX
FISCAL YEAR	2015-16
SHEET NUMBER	6
TOTAL SHEETS	32



SCOTT ROBIN Rd & FREESTONE FLAT Rd INTERSECTION  
SCALE: 1"=10'

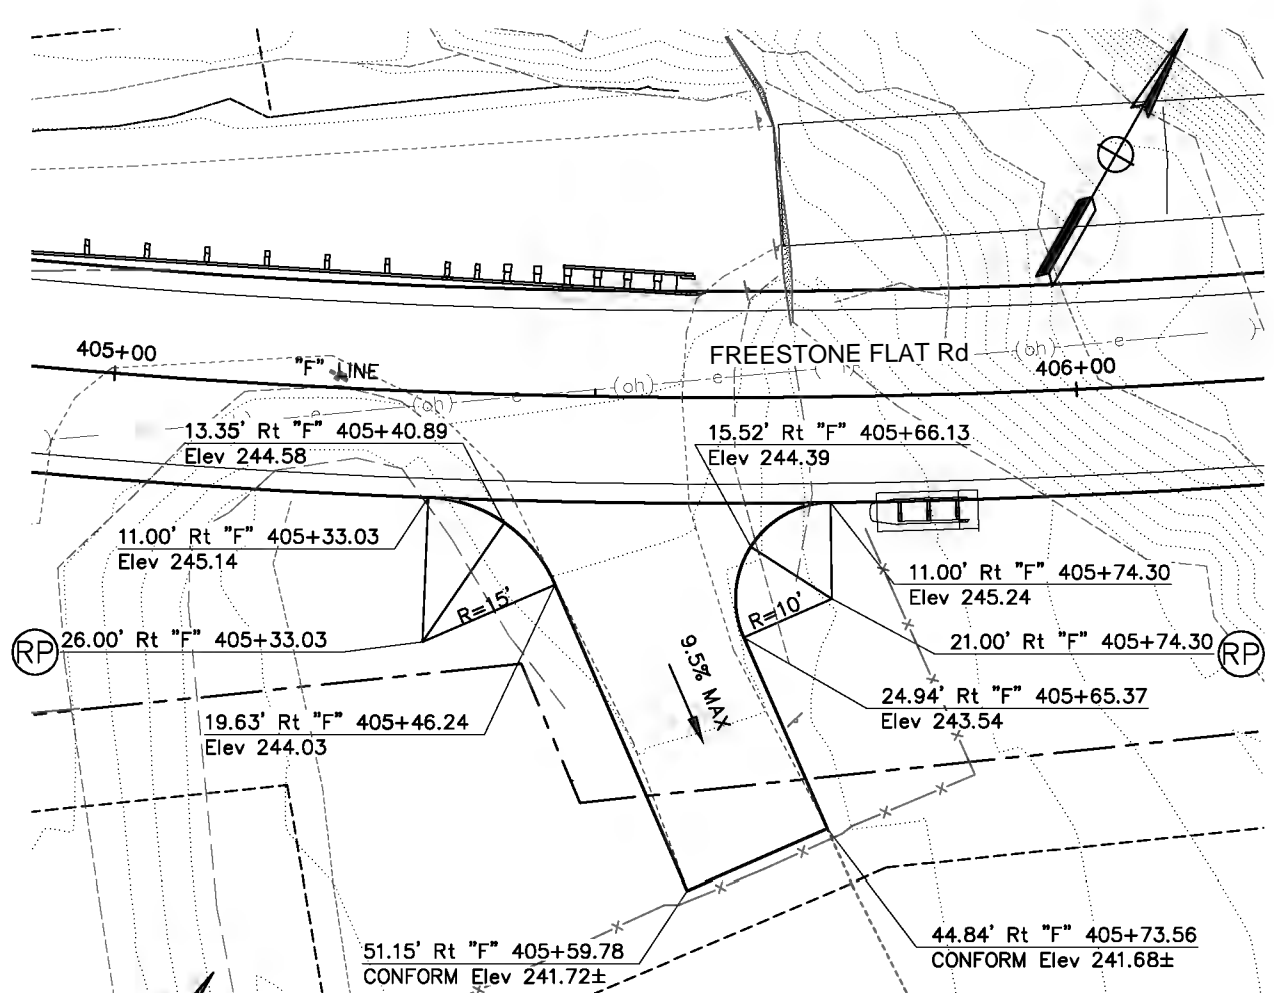


SOUTHEAST DRIVEWAY DETAIL  
SCALE: 1"=10'

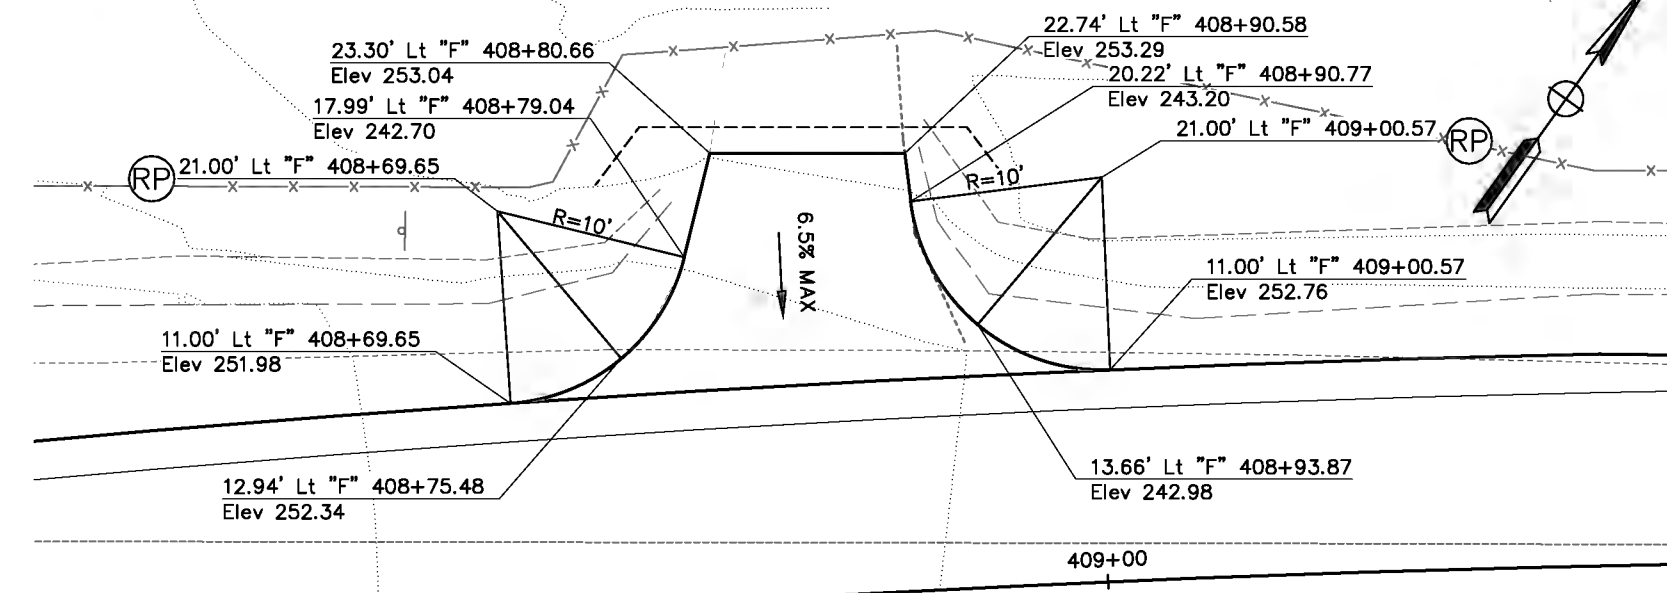


NORTHWEST DRIVEWAY DETAIL  
SCALE: 1"=5'

65% SUBMITTAL

DESIGN BY	B.GRIMM		CONSTRUCTION COMPLETED:		<b>QUINCY ENGINEERING, INC.</b> 11017 Cobblerock Drive, Suite 100 Sacramento, CA 95670		<b>COUNTY OF SONOMA</b> DEPARTMENT OF TRANSPORTATION & PUBLIC WORKS SUSAN KLASSEN, DIRECTOR	CONSTRUCTION DETAILS	ROAD NUMBER	XXX
DRAWING BY	B.GRIMM		REGISTERED CIVIL ENGINEER					RESIDENT ENGINEER	BUDGET NUMBER	XXX
CHECKED BY	DES CHK		1/31/2018					AS BUILT DRAWINGS BY:	FISCAL YEAR	2015-16
PLANS APPROVAL DATE: 1/31/2018 CLIENT: SONOMA COUNTY - S22\FREESTONE FLAT ROAD S22-200\CAD\ROADWAY\S22-200_C-2.DWG 1/31/2018 9:54 AM								SHEET NUMBER	7	
								TOTAL SHEETS	32	

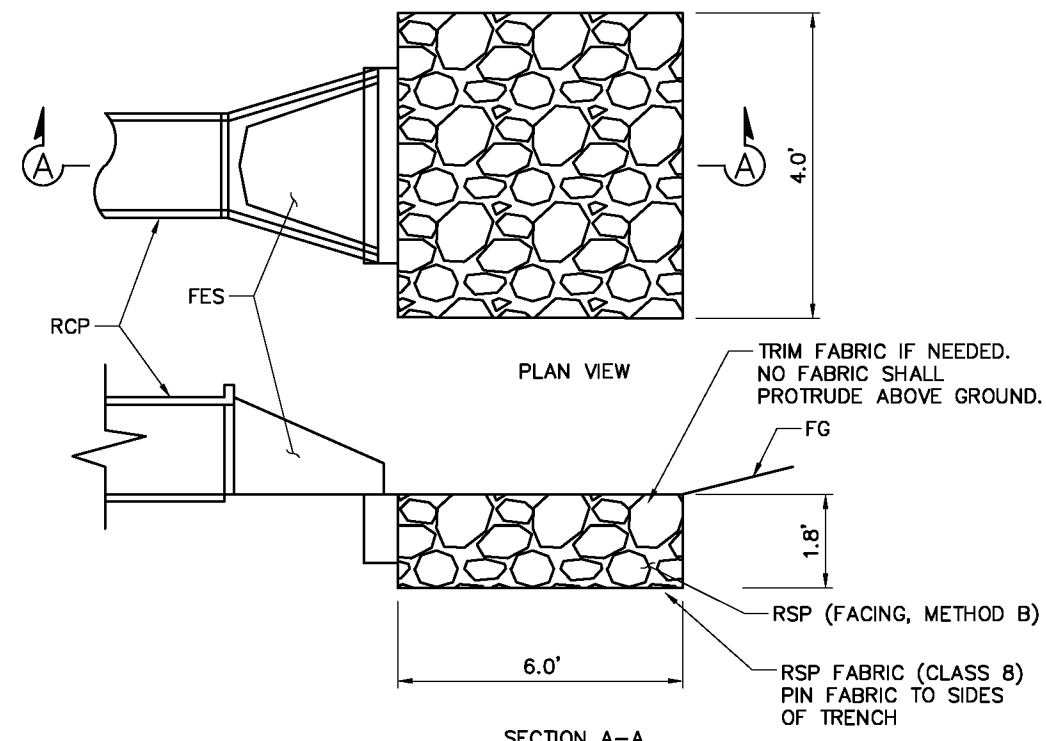


**SECTION A-A  
ROCK SLOPE PROTECTION (RSP)**

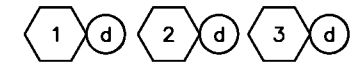


65% SUBMITTAL

DESIGN BY	B.GRIMM		CONSTRUCTION COMPLETED:	<b>QUINCY ENGINEERING, INC.</b> 11017 Cobblersrock Drive, Suite 100 Sacramento, CA 95670	<b>COUNTY OF SONOMA</b> DEPARTMENT OF TRANSPORTATION & PUBLIC WORKS SUSAN KLASSEN, DIRECTOR	CONSTRUCTION DETAILS	ROAD NUMBER	XXX	
DRAWING BY	B.GRIMM		REGISTERED CIVIL ENGINEER 1/21/2018 PLANS APPROVAL DATE S:\CLIENT\SONOMA COUNTY - S22\FREESTONE FLAT ROAD S22-200\CAD\ROADWAY\S22-200_C-3.DWG 1/31/2018 9:55 AM			"AS BUILT" INFORMATION TO BE COMPLETED AFTER CONSTRUCTION RESIDENT ENGINEER AS BUILT DRAWINGS BY:	FREESTONE FLAT ROAD BRIDGE REPLACEMENT	BUDGET NUMBER	XXX
CHECKED BY	DES CHK		DATE: _____ BY: _____ APPROVED: _____			SHEET NUMBER <b>8</b>	FISCAL YEAR	2015-16	TOTAL SHEETS



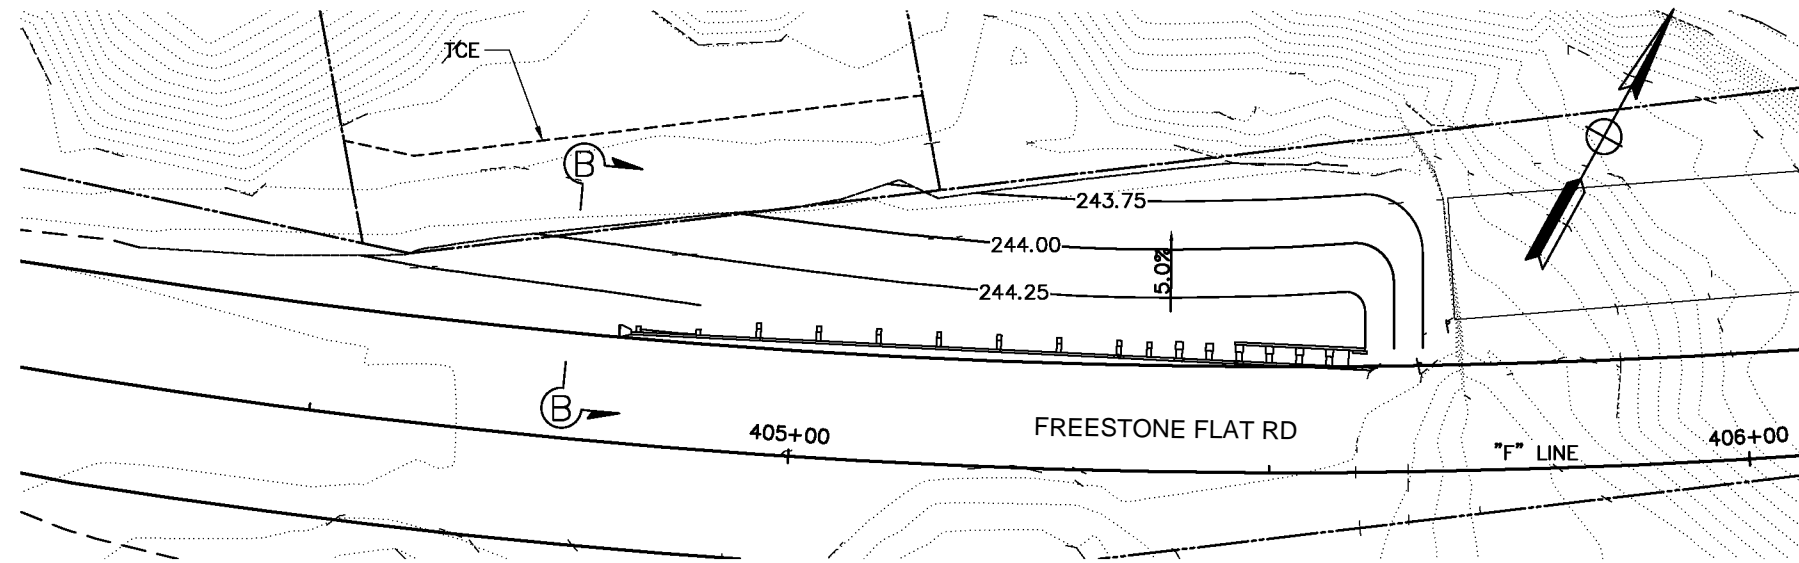

NORTHWEST GRADING  
SCALE: 1"=10'

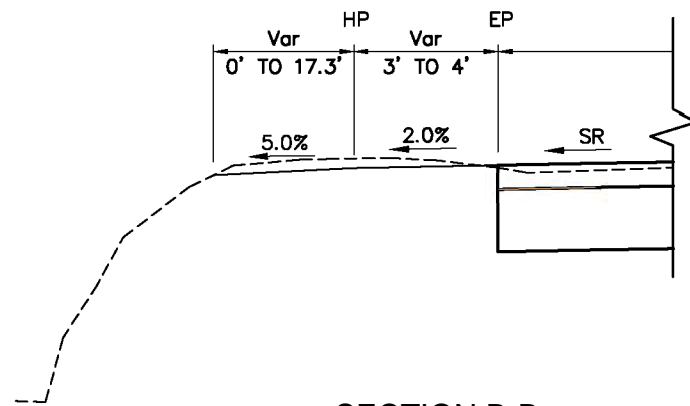

SECTION B-B  
NO SCALE




65% SUBMITTAL

DESIGN BY	B.GRIMM		CONSTRUCTION COMPLETED:	<b>QUINCY ENGINEERING, INC.</b> 11017 Cobblerock Drive, Suite 100 Sacramento, CA 95670	<b>COUNTY OF SONOMA</b> DEPARTMENT OF TRANSPORTATION & PUBLIC WORKS SUSAN KLASSEN, DIRECTOR	ROAD NUMBER	XXX	
DRAWING BY	B.GRIMM		REGISTERED CIVIL ENGINEER			RESIDENT ENGINEER	BUDGET NUMBER	XXX
CHECKED BY	DES CHK		1/21/2018			AS BUILT DRAWINGS BY:	FISCAL YEAR	2015-16
PLANS APPROVAL DATE S:\CLIENT\SONOMA COUNTY - S22\FREESTONE FLAT ROAD\22-200\CAD\ROADWAY\S22-200_G-1.DWG 1/31/2018 9:55 AM		*AS BUILT* INFORMATION TO BE COMPLETED AFTER CONSTRUCTION DATE _____ BY _____ APPROVED _____		CONTOUR GRADING  <b>FREESTONE FLAT ROAD BRIDGE REPLACEMENT</b>		SHEET NUMBER	9	
						TOTAL SHEETS	32	


**NOTES:**

1. THIS PLAN ACCURATE FOR CONSTRUCTION AREA SIGN WORK ONLY.
2. LOCATION OF CONSTRUCTION AREA SIGNS ARE APPROXIMATE. EXACT LOCATIONS WILL BE DETERMINED BY THE ENGINEER.
3. ACCESS TO DRIVEWAYS SHALL BE MAINTAINED AT ALL TIMES.

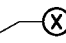


**LEGEND:**

-  CONSTRUCTION AREA SIGN
-  WORK AREA
-  CONSTRUCTION AREA SIGN (CAS) NUMBER

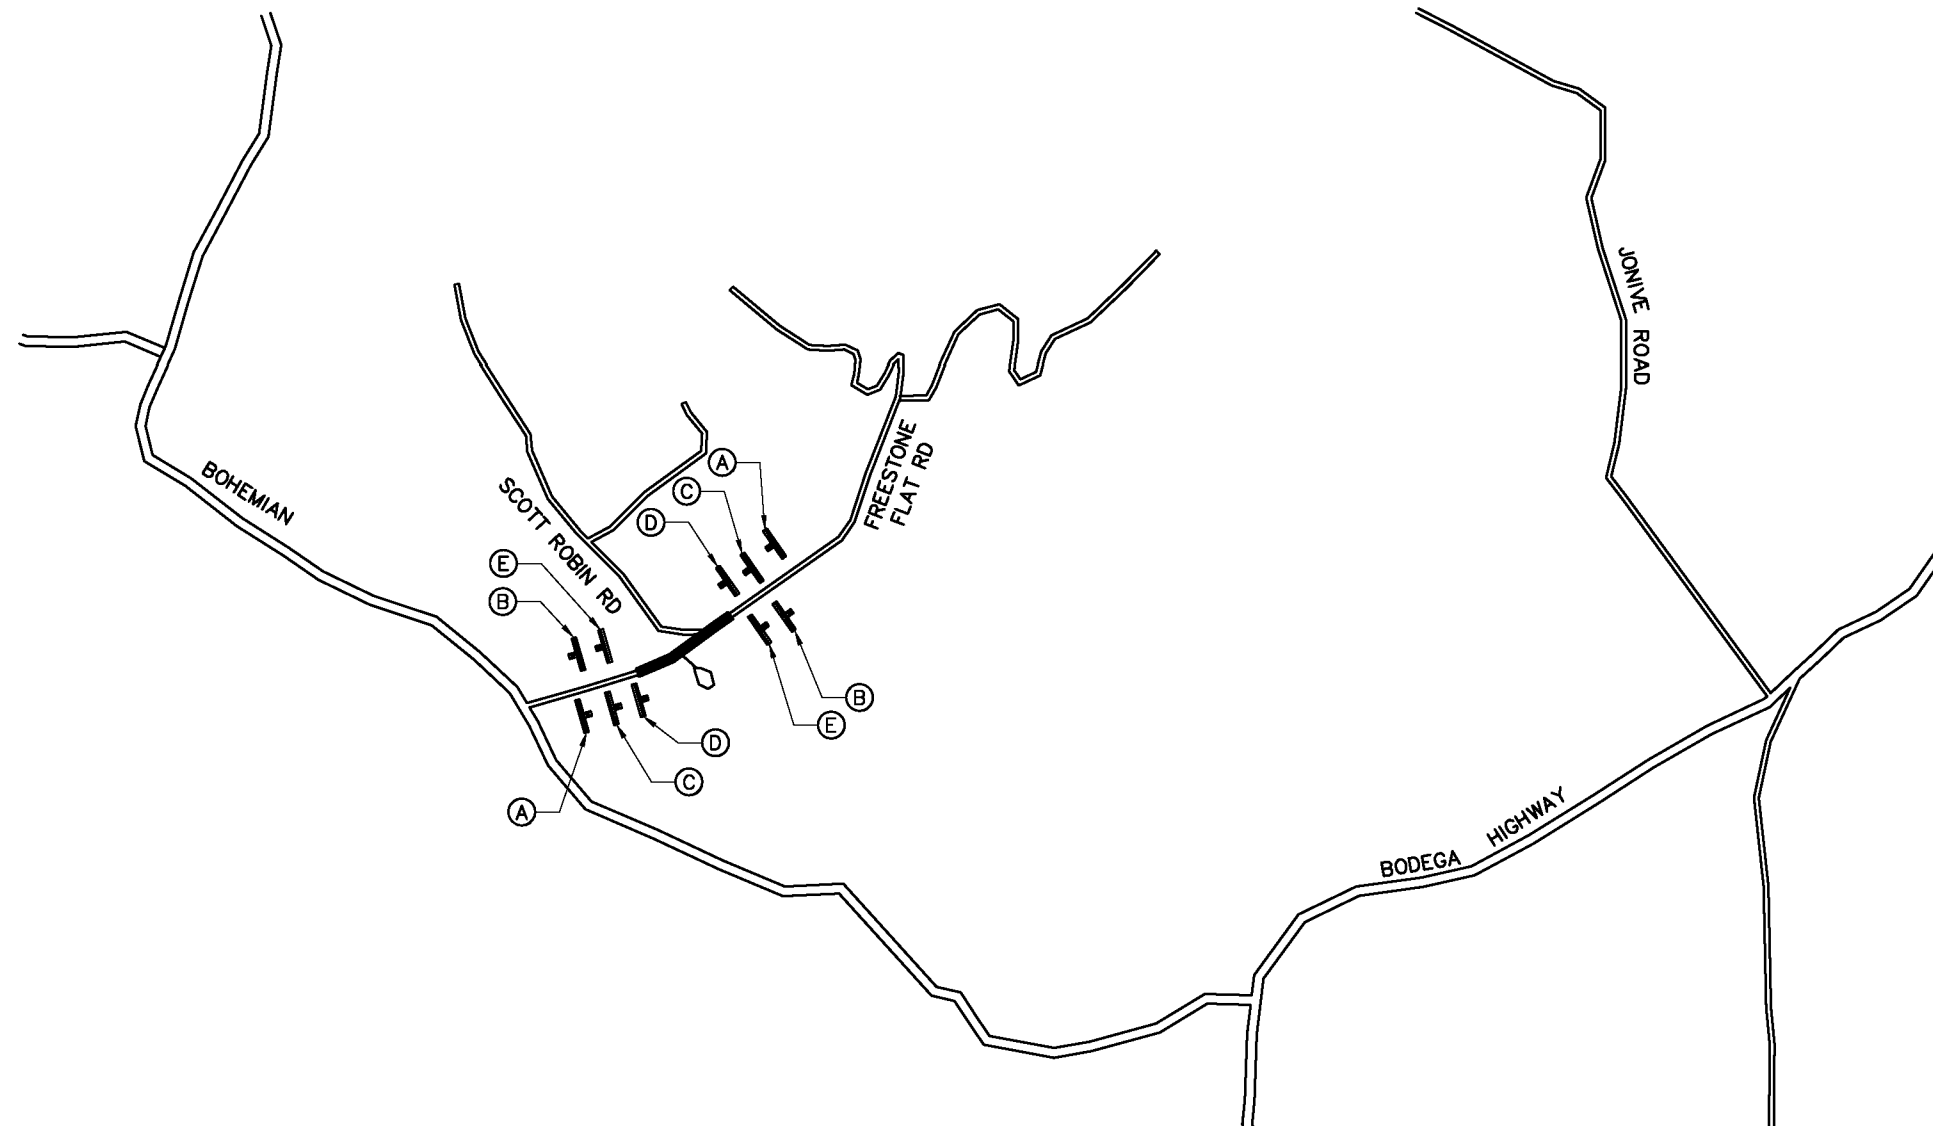STATIONARY MOUNTED CONSTRUCTION AREA SIGNS						
SIGN No.	SIGN CODE		PANEL SIZE	SIGN MESSAGE	NUMBER OF POSTS AND SIZE	NUMBER OF SIGNS
	FEDERAL	CALIFORNIA				
A	-	C23 (CA)	30" x 30"	ROAD WORK AHEAD	1 - 4" x 4"	2
B	G20-2	-	36" x 18"	END ROAD WORK	1 - 4" x 4"	2
C	W5-3	-	36" x 36"	ONE LANE BRIDGE	1 - 4" x 6"	2
D	R2-1 (10)	-	24" x 36"	SPEED LIMIT 10 MPH	1 - 4" x 4"	2
E	M4-8a	-	24" x 18"	END DETOUR	1 - 4" x 4"	2

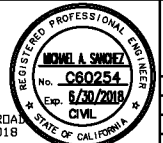

65% SUBMITTAL

DESIGN BY	B.GRIMM		CONSTRUCTION COMPLETED:	 <b>QUINCY ENGINEERING, INC.</b> 11017 Cobblerock Drive, Suite 100 Sacramento, CA 95670	 <b>COUNTY OF SONOMA</b> DEPARTMENT OF TRANSPORTATION & PUBLIC WORKS SUSAN KLASSEN, DIRECTOR	CONSTRUCTION AREA SIGNS	ROAD NUMBER	XXX	
DRAWING BY	B.GRIMM		REGISTERED CIVIL ENGINEER			RESIDENT ENGINEER	FREESTONE FLAT ROAD BRIDGE REPLACEMENT	BUDGET NUMBER	XXX
CHECKED BY	DES CHK		PLANS APPROVAL DATE			AS BUILT DRAWINGS BY:	1/21/2018	FISCAL YEAR	2015-16
		S:\CLIENT\SONOMA COUNTY - S22\FREESTONE FLAT ROAD BRIDGE REPLACEMENT\ROADWAY\S22-200_CS-1.DWG 1/31/2018 9:55 AM	DATE	BY	APPROVED	SHEET NUMBER	10		
						TOTAL SHEETS	32		

**NOTES:**

1. THIS PLAN ACCURATE FOR STAGE CONSTRUCTION WORK ONLY.
2. ACCESS TO DRIVEWAY SHALL BE MAINTAINED AT ALL TIMES.




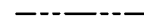





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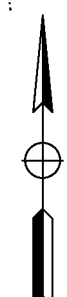
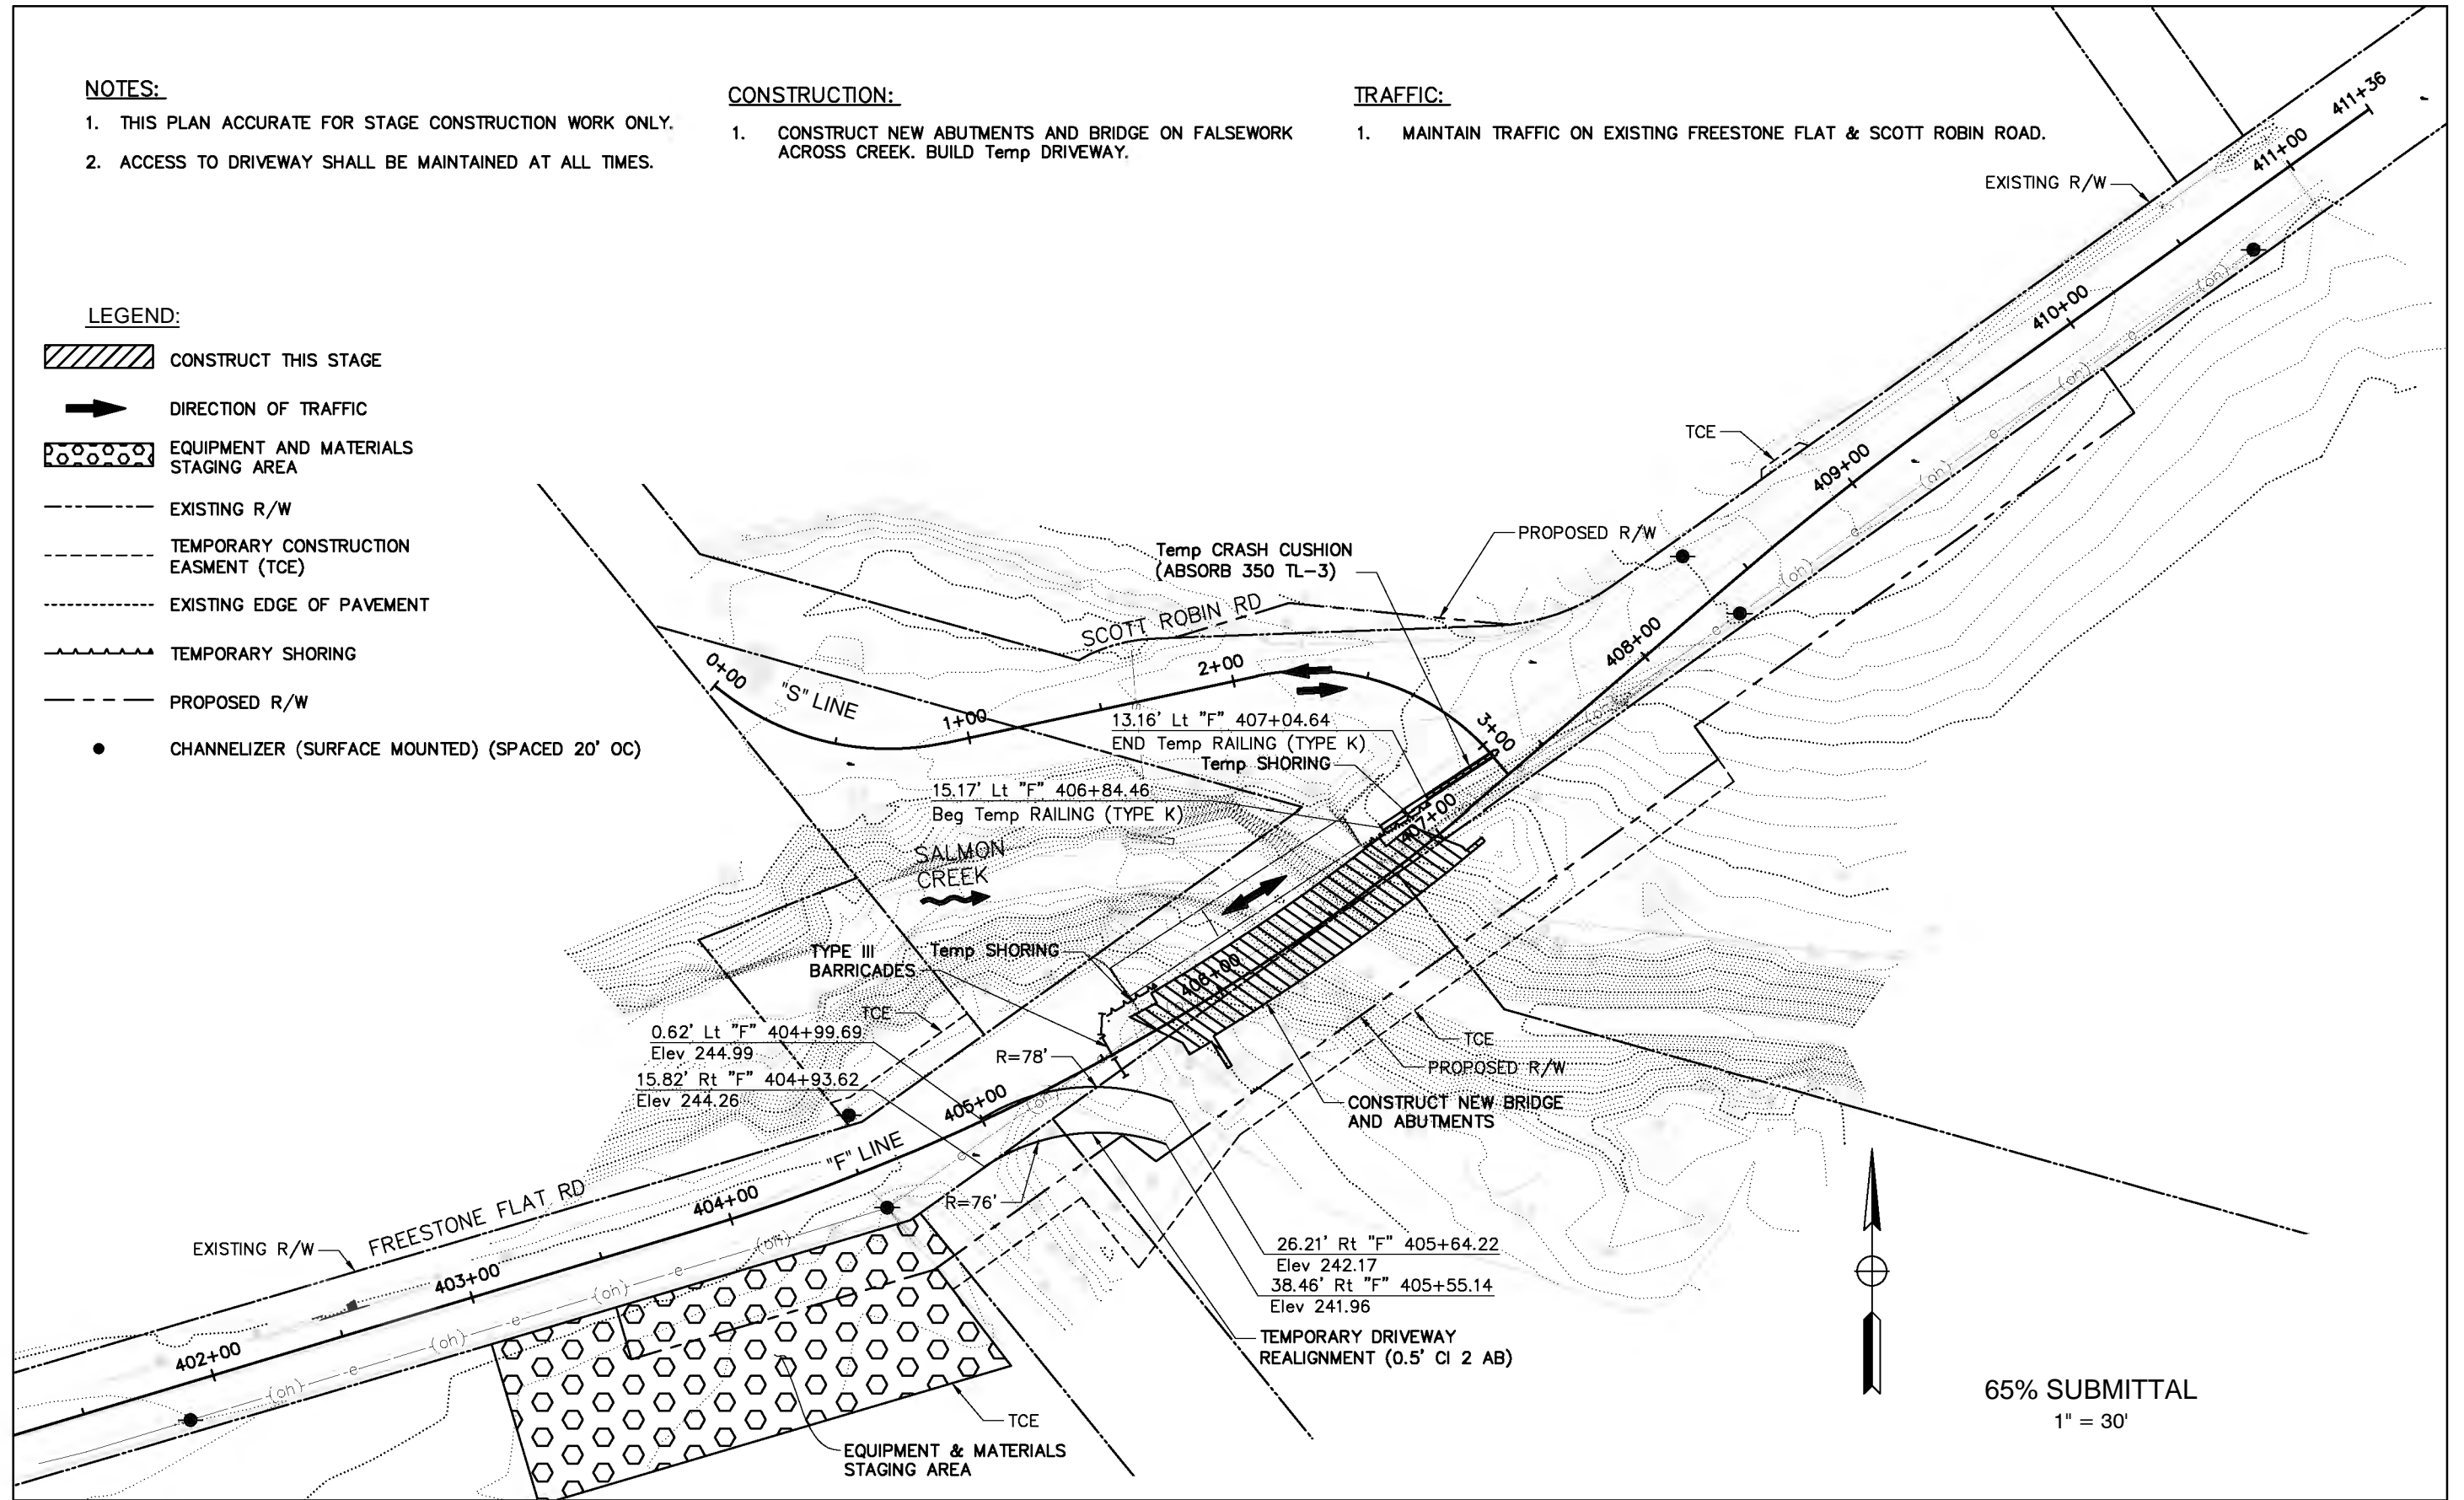
1. CONSTRUCT NEW ABUTMENTS AND BRIDGE ON FALSEWORK ACROSS CREEK. BUILD Temp DRIVEWAY.

**TRAFFIC:**

1. MAINTAIN TRAFFIC ON EXISTING FREESTONE FLAT & SCOTT ROBIN ROAD.

**LEGEND:**


-  CONSTRUCT THIS STAGE
-  DIRECTION OF TRAFFIC
-  EQUIPMENT AND MATERIALS STAGING AREA
-  EXISTING R/W
-  TEMPORARY CONSTRUCTION EASMENT (TCE)
-  EXISTING EDGE OF PAVEMENT
-  TEMPORARY SHORING
-  PROPOSED R/W
-  CHANNELIZER (SURFACE MOUNTED) (SPACED 20' OC)



65% SUBMITTAL  
1" = 30'


DESIGN BY	B.GRIMM
DRAWING BY	B.GRIMM
CHECKED BY	DES CHK

REGISTERED CIVIL ENGINEER  
1/31/2018  
PLANS APPROVAL DATE  
S:\CLIENT\SONOMA COUNTY - S22\FREESTONE FLAT ROAD  
S22-200\CAD\ROADWAY\S22-200\_SC-1.DWG 1/31/2018  
9:55 AM

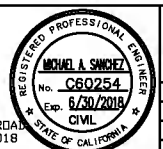

CONSTRUCTION COMPLETED:	
"AS BUILT" INFORMATION TO BE COMPLETED AFTER CONSTRUCTION	
DATE	BY
	APPROVED



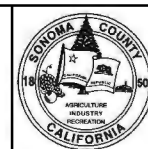






QUINCY ENGINEERING, INC.  
11017 Cobblerock Drive, Suite 100  
Sacramento, CA 95670



COUNTY OF SONOMA  
DEPARTMENT OF TRANSPORTATION & PUBLIC WORKS  
SUSAN KLASSEN, DIRECTOR

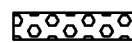STAGE CONSTRUCTION & TRAFFIC HANDLING	ROAD NUMBER	XXX
FREESTONE FLAT ROAD BRIDGE REPLACEMENT	BUDGET NUMBER	XXX
	FISCAL YEAR	2015-16
	SHEET NUMBER	11
	TOTAL SHEETS	32

**LEGEND:**

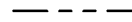
-  CONSTRUCT THIS STAGE
-  DIRECTION OF TRAFFIC
-  EQUIPMENT AND MATERIALS STAGING AREA
-  EXISTING R/W
-  TEMPORARY CONSTRUCTION EASEMENT (TCE)
-  EXISTING EDGE OF PAVEMENT
-  TEMPORARY SHORING
-  PROPOSED R/W
-  CHANNELIZER (SURFACE MOUNTED) (SPACED 20' OC)

**CONSTRUCTION:**

1. CONSTRUCT DRIVEWAY AND PORTION OF NEW ROADWAY (FREESTONE FLAT ROAD).

**TRAFFIC:**


1. MAINTAIN TRAFFIC ON EXISTING FREESTONE FLAT & SCOTT ROBIN ROAD.

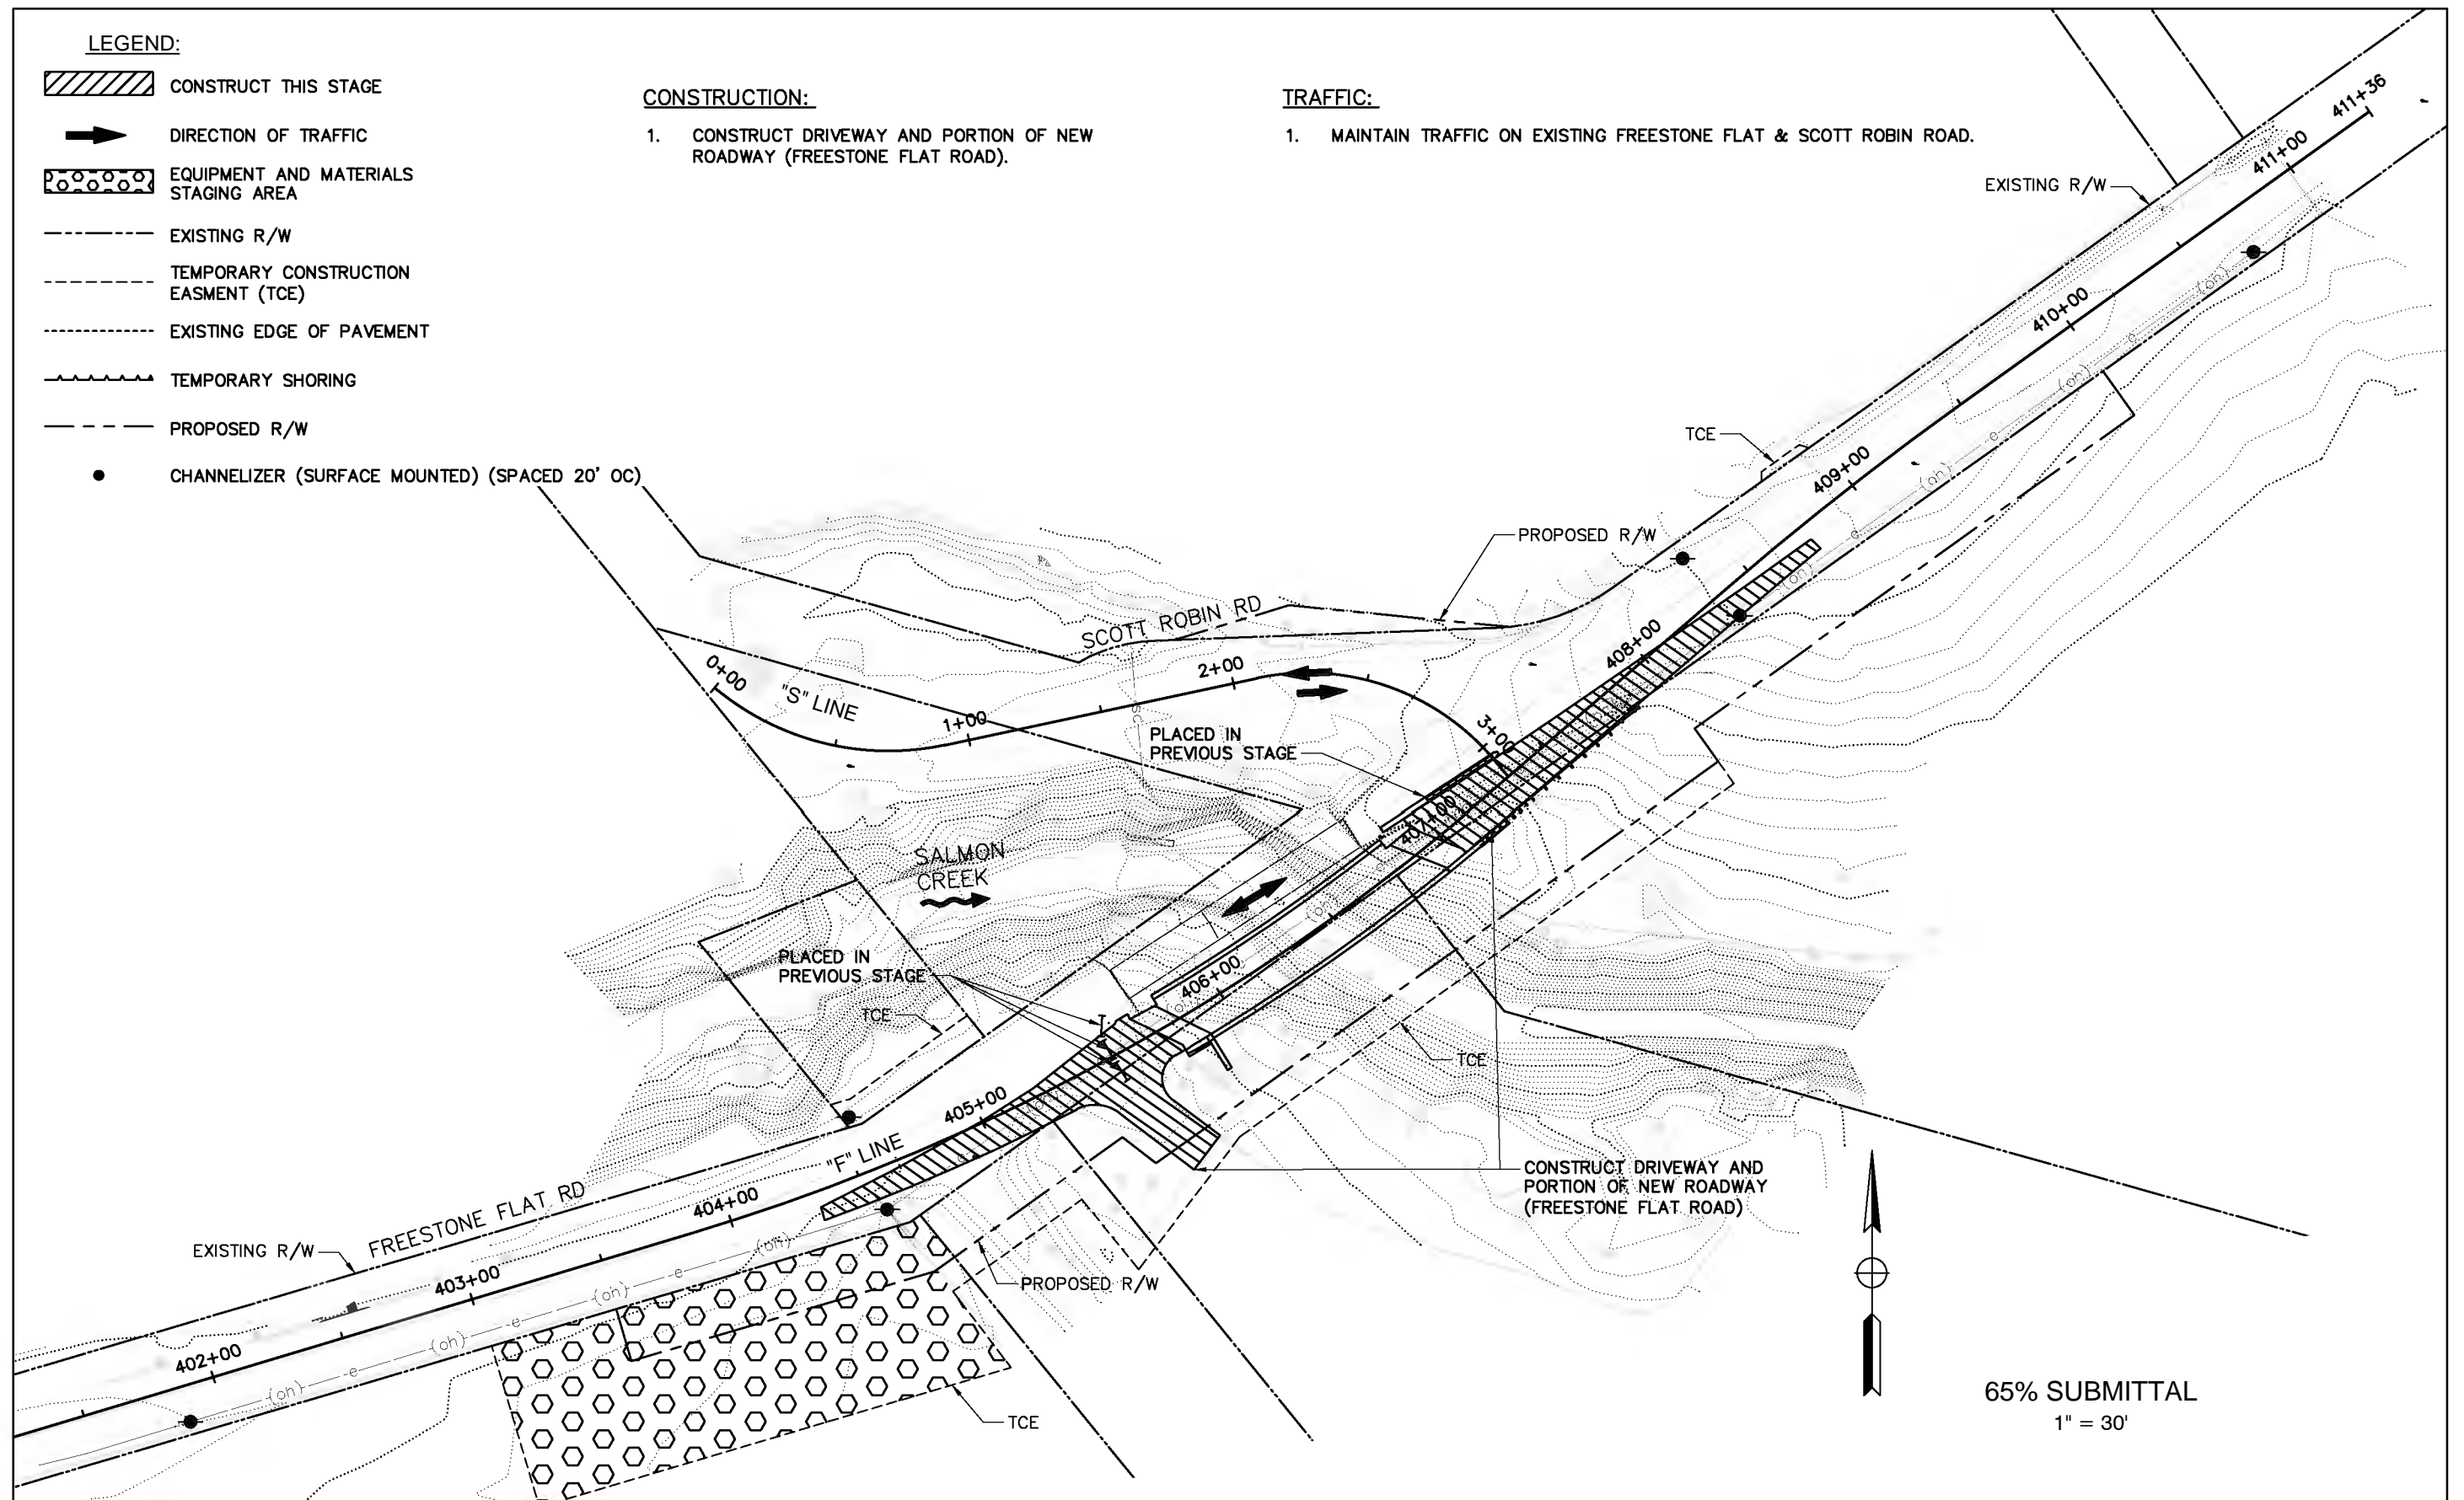

65% SUBMITTAL  
1" = 30'

DESIGN BY	B.GRIMM
DRAWING BY	B.GRIMM
CHECKED BY	DES CHK

REGISTERED CIVIL ENGINEER  
1/31/2018  
PLANS APPROVAL DATE  
S:\CLIENT\SONOMA COUNTY - S22\FREESTONE FLAT ROAD\S22-200\CAD\ROADWAY\S22-200\_SC-2.DWG 1/31/2018 9:56 AM

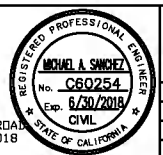

CONSTRUCTION COMPLETED:	
"AS BUILT" INFORMATION TO BE COMPLETED AFTER CONSTRUCTION	
DATE	BY

RESIDENT ENGINEER AS BUILT DRAWINGS BY:  
**QUINCY ENGINEERING, INC.**  
11017 Cobblerock Drive, Suite 100  
Sacramento, CA 95670



**COUNTY OF SONOMA**  
DEPARTMENT OF TRANSPORTATION & PUBLIC WORKS  
SUSAN KLASSEN, DIRECTOR

STAGE CONSTRUCTION & TRAFFIC HANDLING  
**FREESTONE FLAT ROAD  
BRIDGE REPLACEMENT**


ROAD NUMBER	XXX
BUDGET NUMBER	XXX
FISCAL YEAR	2015-16
SHEET NUMBER	12
TOTAL SHEETS	32

**CONSTRUCTION:**

- 3A CONSTRUCT ROADWAY CONFORMS (FREESTONE FLAT & SCOTT ROBIN ROAD)
- 3B CONSTRUCT NEW INTERSECTION (FREESTONE FLAT & SCOTT ROBIN ROAD)

**TRAFFIC:**


1. TEMPORARY TRAFFIC CONTROL AND FLAGGING REQUIRED FOR STAGES 3A & 3B. BOTH EXISTING AND NEW ROADWAY USED AS REQUIRED, ONE AT A TIME, SINGLE LANE ONLY.

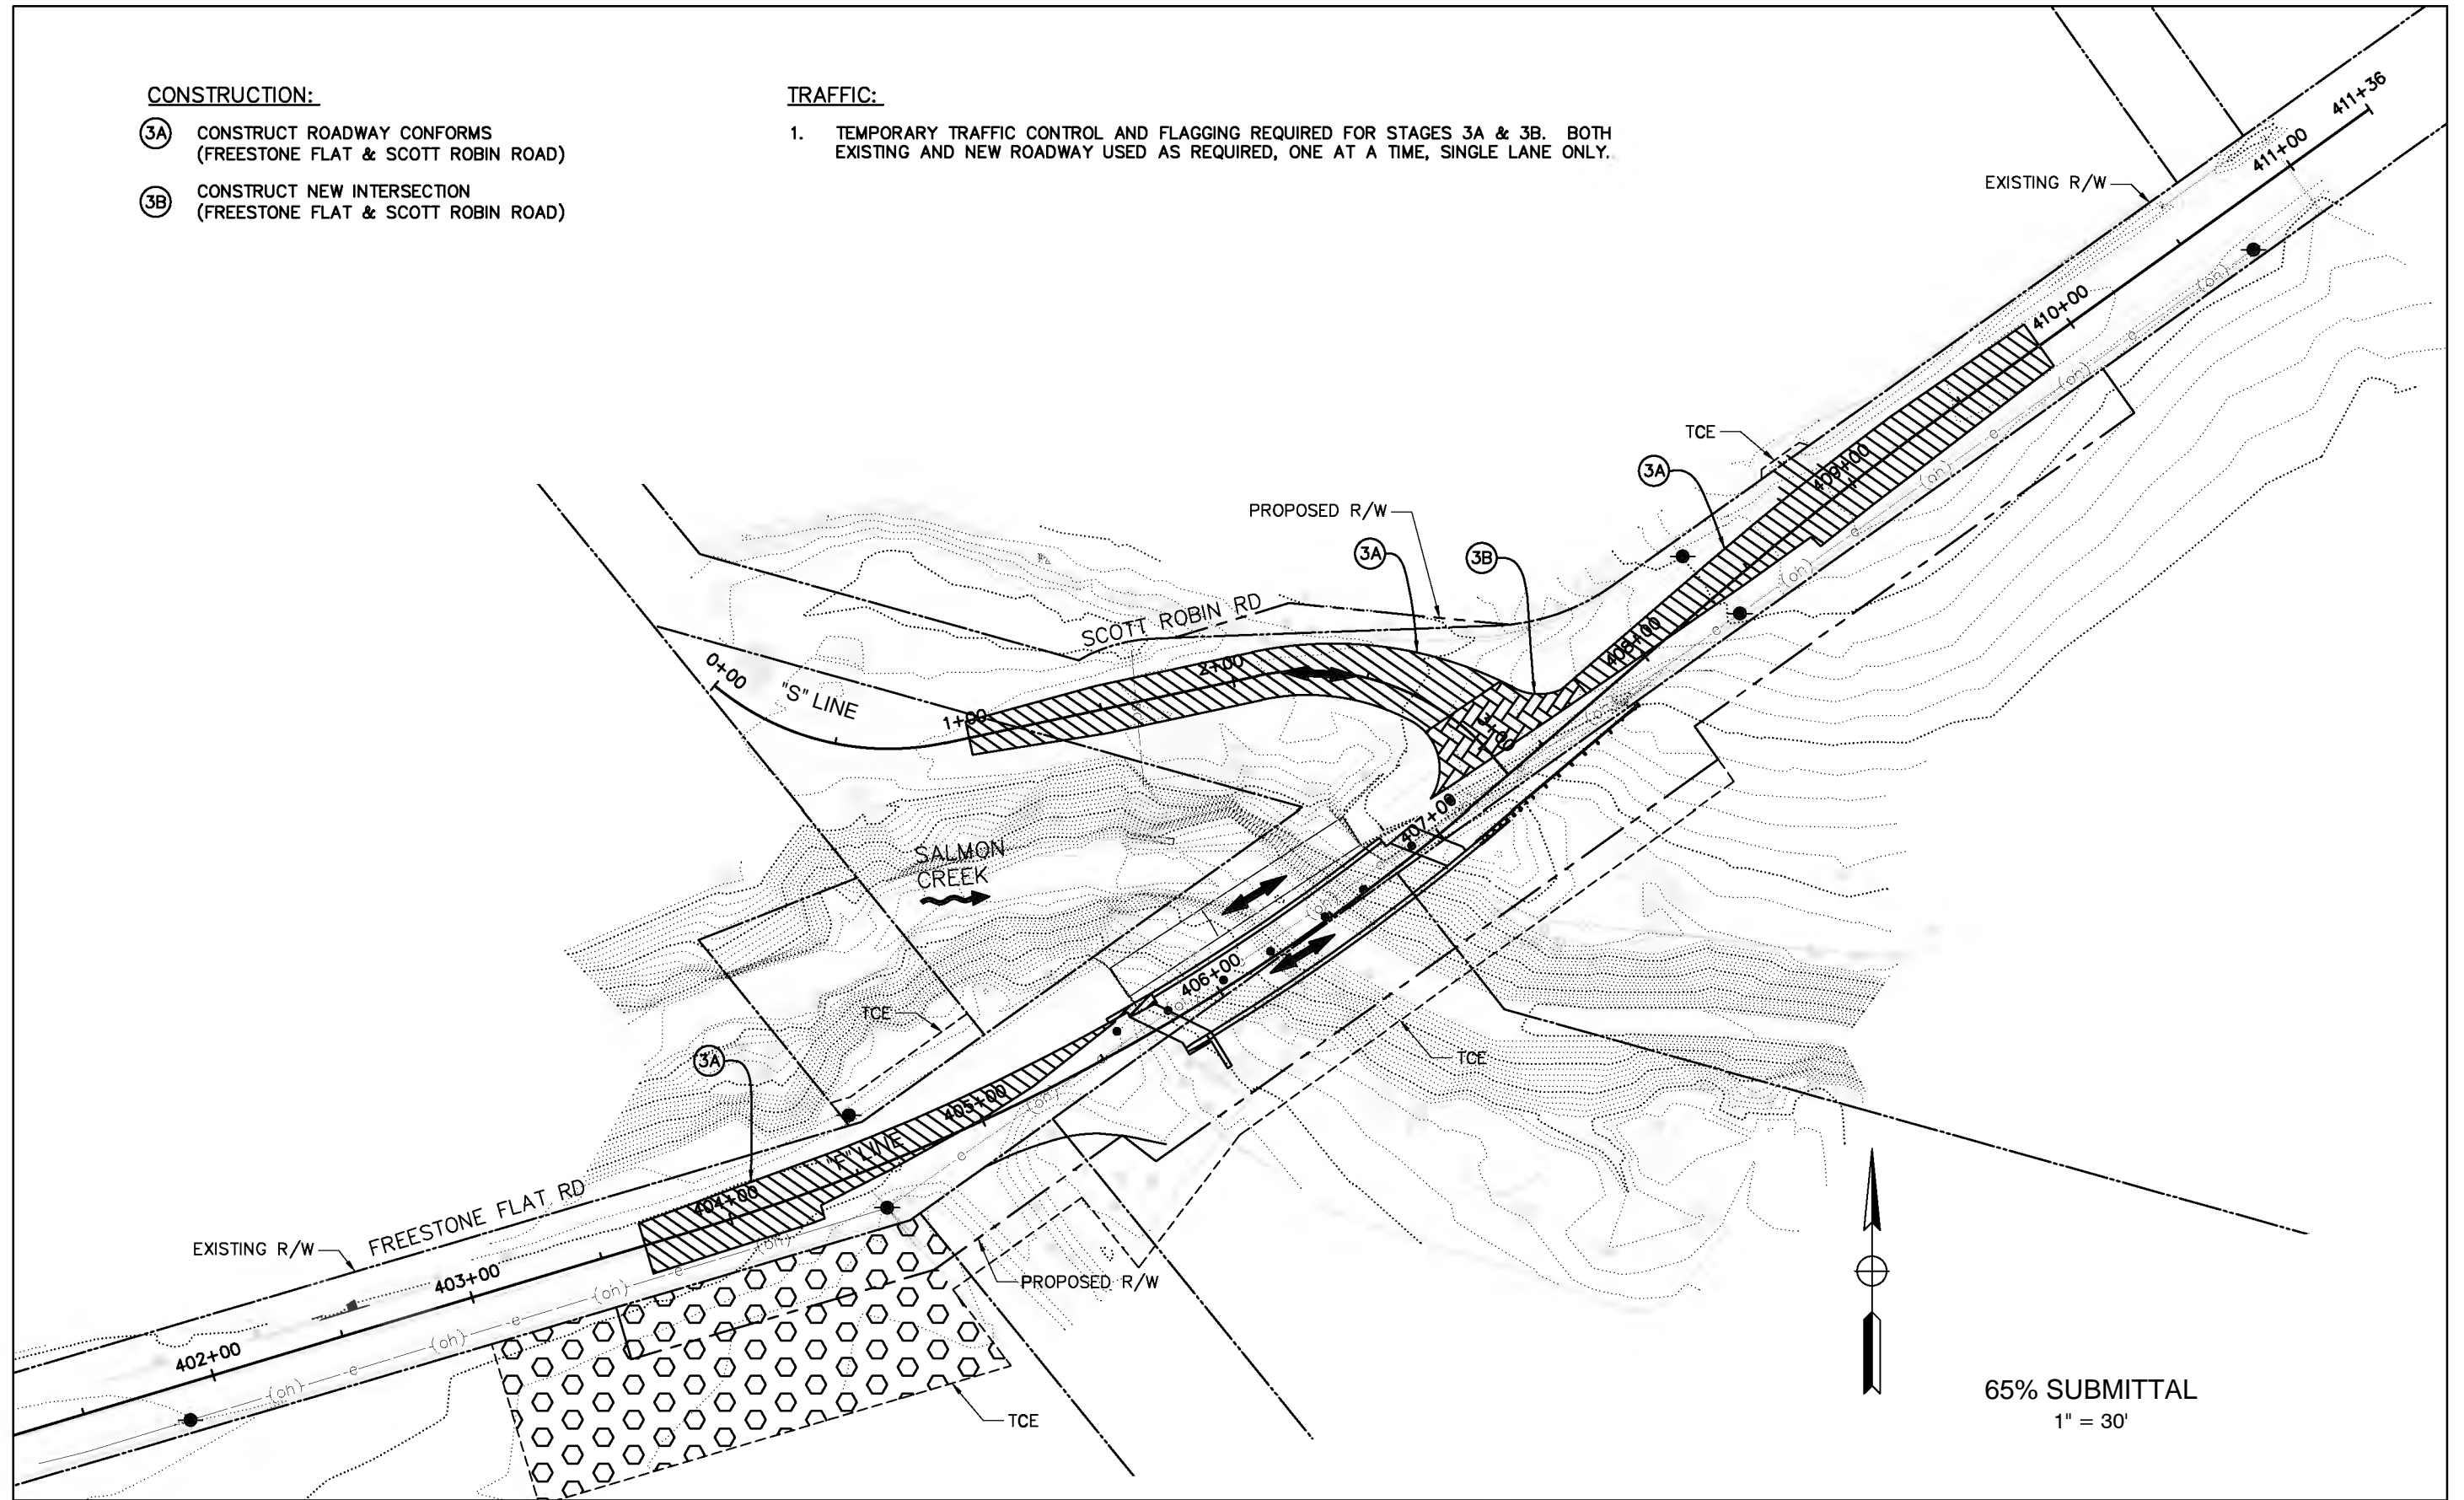

65% SUBMITTAL  
1" = 30'

DESIGN BY	B.GRIMM
DRAWING BY	B.GRIMM
CHECKED BY	DES CHK

REGISTERED CIVIL ENGINEER  
1/31/2018  
PLANS APPROVAL DATE  
S:\CLIENT\SONOMA COUNTY - S22\FREESTONE FLAT ROAD  
S22-200\CAD\ROADWAY\S22-200\_SC-3.DWG 1/31/2018  
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CONSTRUCTION COMPLETED:	
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DATE	BY
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11017 Cobblecreek Drive, Suite 100  
Sacramento, CA 95670

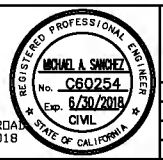

COUNTY OF SONOMA  
DEPARTMENT OF TRANSPORTATION & PUBLIC WORKS  
SUSAN KLASSEN, DIRECTOR

STAGE CONSTRUCTION & TRAFFIC HANDLING	ROAD NUMBER	XXX
FREESTONE FLAT ROAD BRIDGE REPLACEMENT	BUDGET NUMBER	XXX
	FISCAL YEAR	2015-16
	SHEET NUMBER	13
	TOTAL SHEETS	32




**CONSTRUCTION:**

- 4A CONSTRUCT NORTH SIDE BRIDGE END TREATMENT & NE WINGWALL. REMOVE EXIST BRIDGE.

**TRAFFIC:**


- 1. SHIFT TRAFFIC TO NEW BRIDGE WITH SINGLE LANE TRAFFIC OPERATIONS USING TEMPORARY STOP BARS.

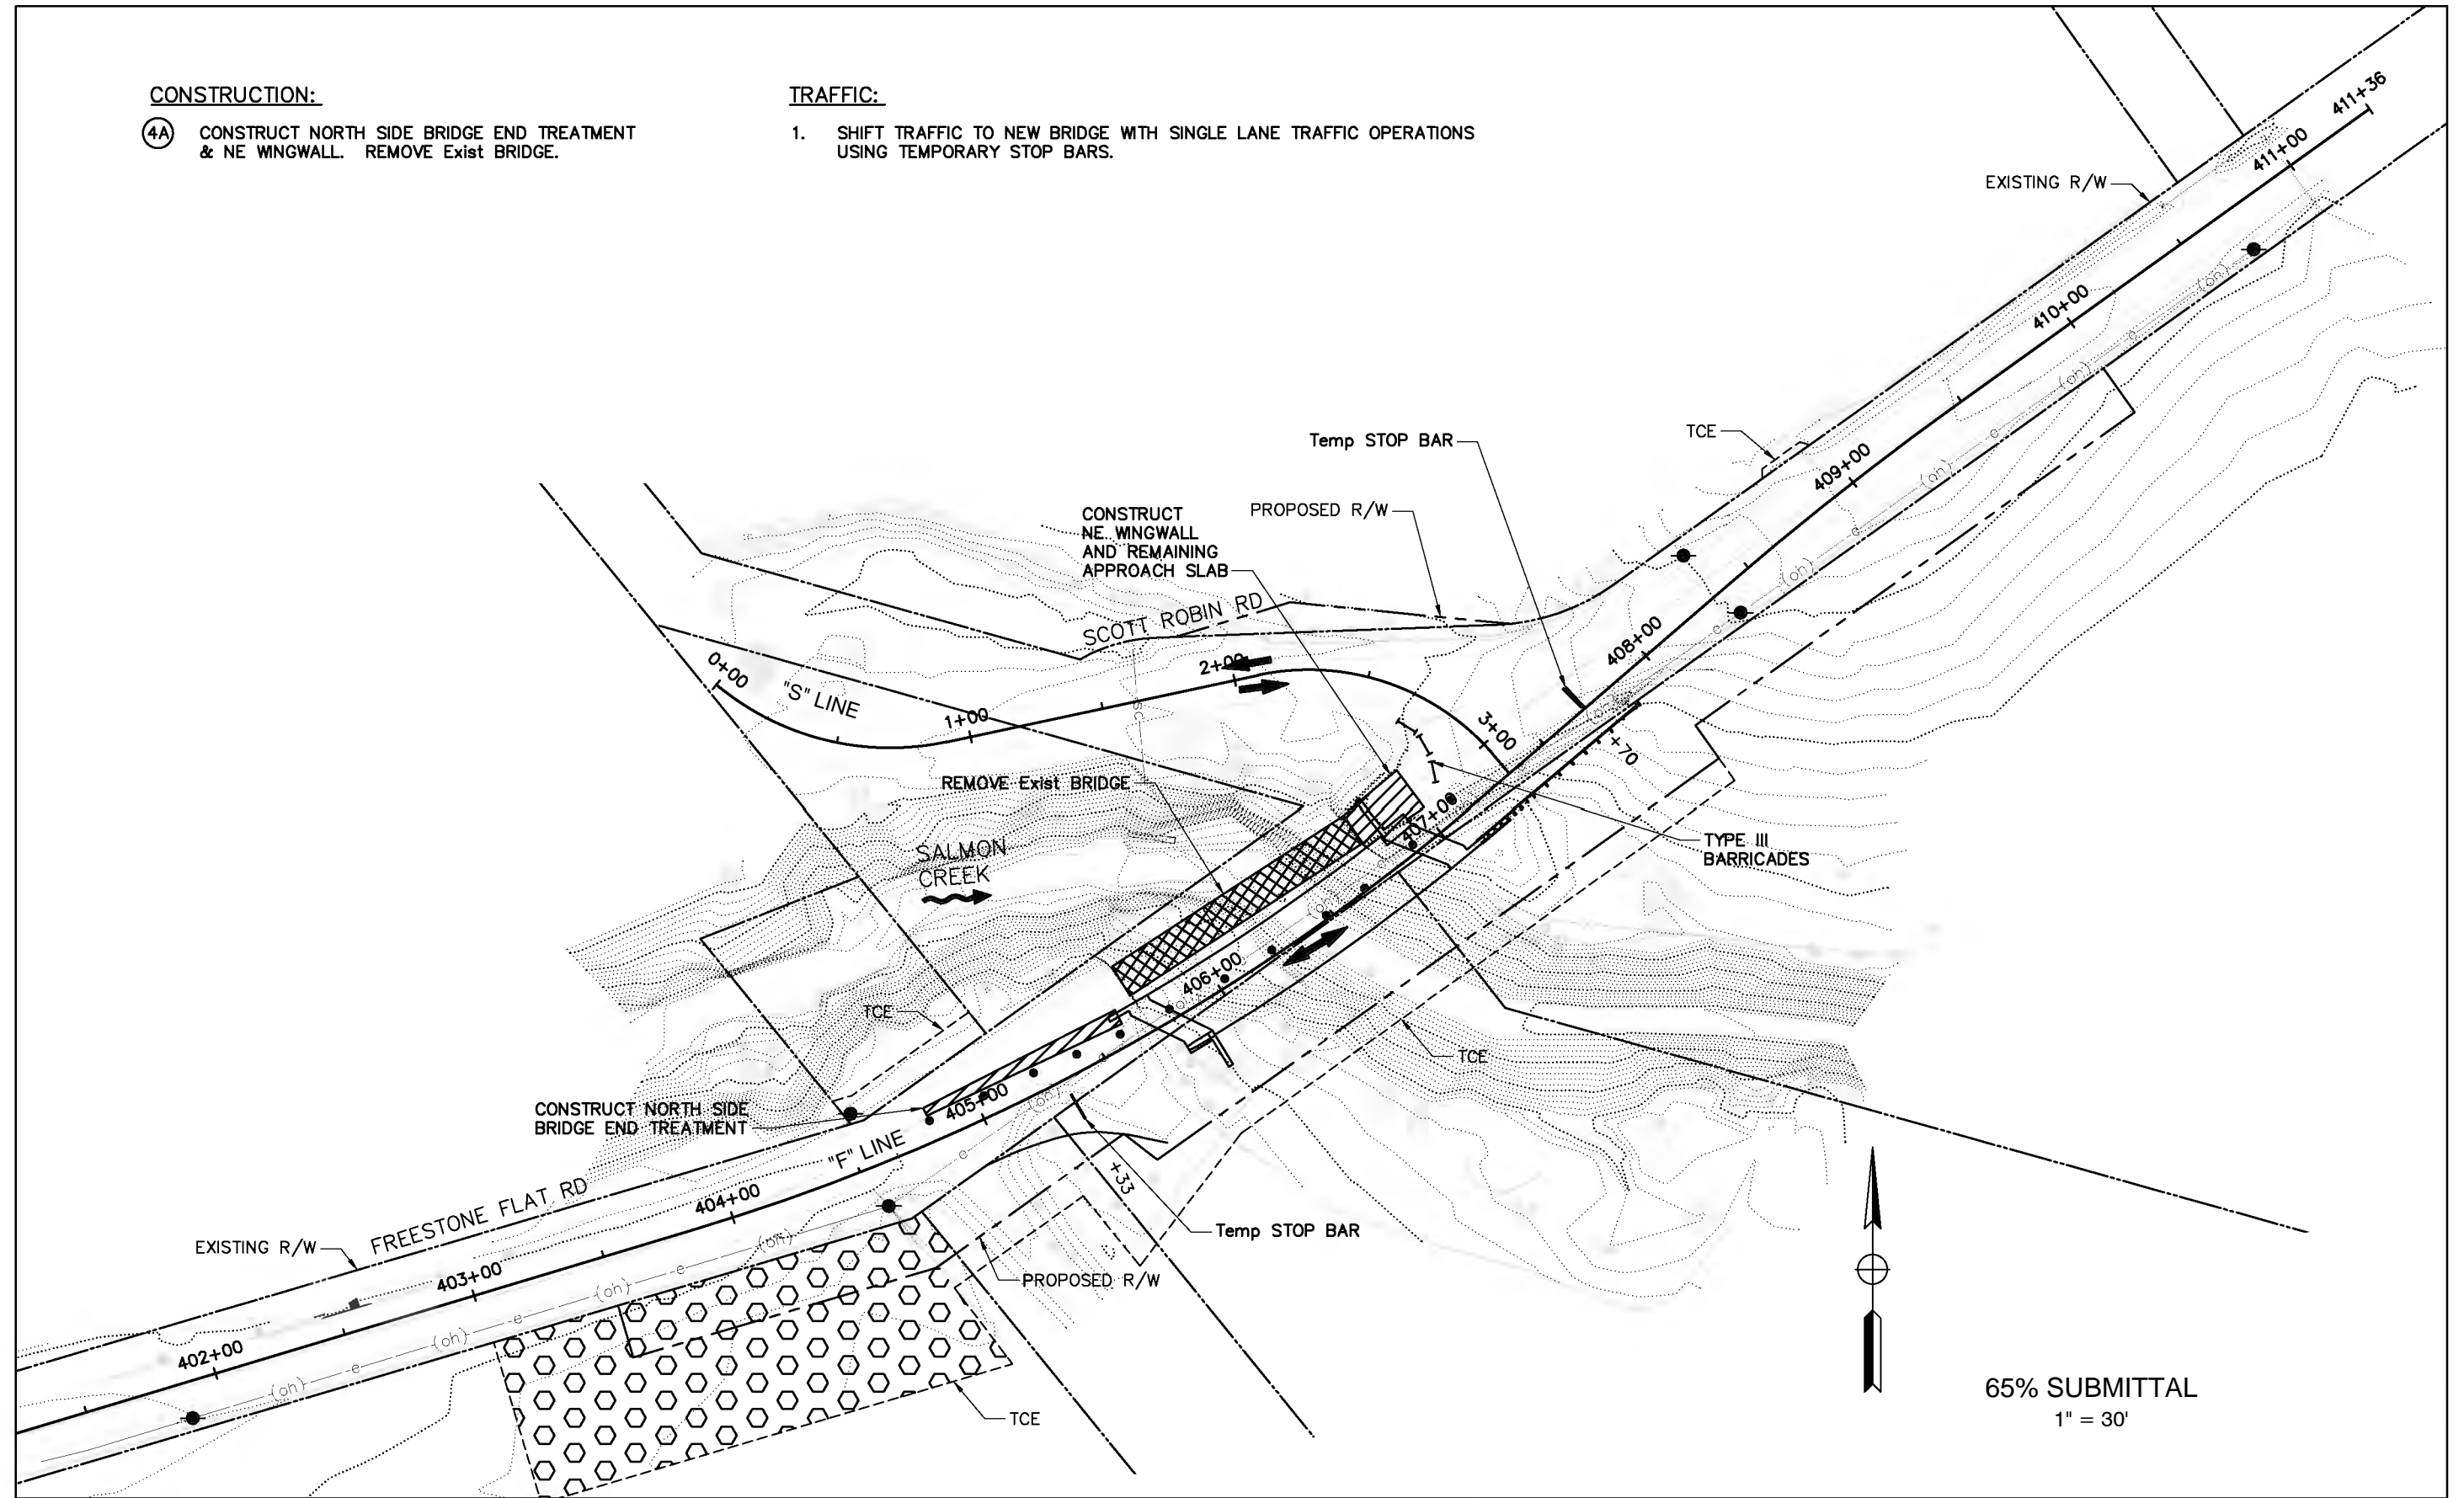

65% SUBMITTAL  
1" = 30'

DESIGN BY	B.GRIMM
DRAWING BY	B.GRIMM
CHECKED BY	DES CHK

REGISTERED CIVIL ENGINEER  
1/31/2018  
PLANS APPROVAL DATE  
S:\CLIENT\SONOMA COUNTY - S22\FREESTONE FLAT ROAD  
S22-200\CAD\ROADWAY\S22-200\_SC-4.DWG 1/31/2018  
9:56 AM

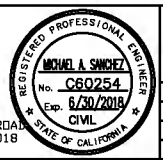

CONSTRUCTION COMPLETED:	
"AS BUILT" INFORMATION TO BE COMPLETED AFTER CONSTRUCTION	
DATE	BY

RESIDENT ENGINEER AS BUILT DRAWINGS BY:  
**QUINCY ENGINEERING, INC.**  
11017 Cobblestone Drive, Suite 100  
Sacramento, CA 95670



**COUNTY OF SONOMA**  
DEPARTMENT OF TRANSPORTATION & PUBLIC WORKS  
SUSAN KLASSEN, DIRECTOR


STAGE CONSTRUCTION & TRAFFIC HANDLING	ROAD NUMBER	XXX
<b>FREESTONE FLAT ROAD BRIDGE REPLACEMENT</b>	BUDGET NUMBER	XXX
	FISCAL YEAR	2015-16
	SHEET NUMBER	14
	TOTAL SHEETS	32

**CONSTRUCTION:**

5A NO CONSTRUCTION THIS STAGE.

**TRAFFIC:**


1. SHIFT TRAFFIC TO FINAL CONFIGURATION.

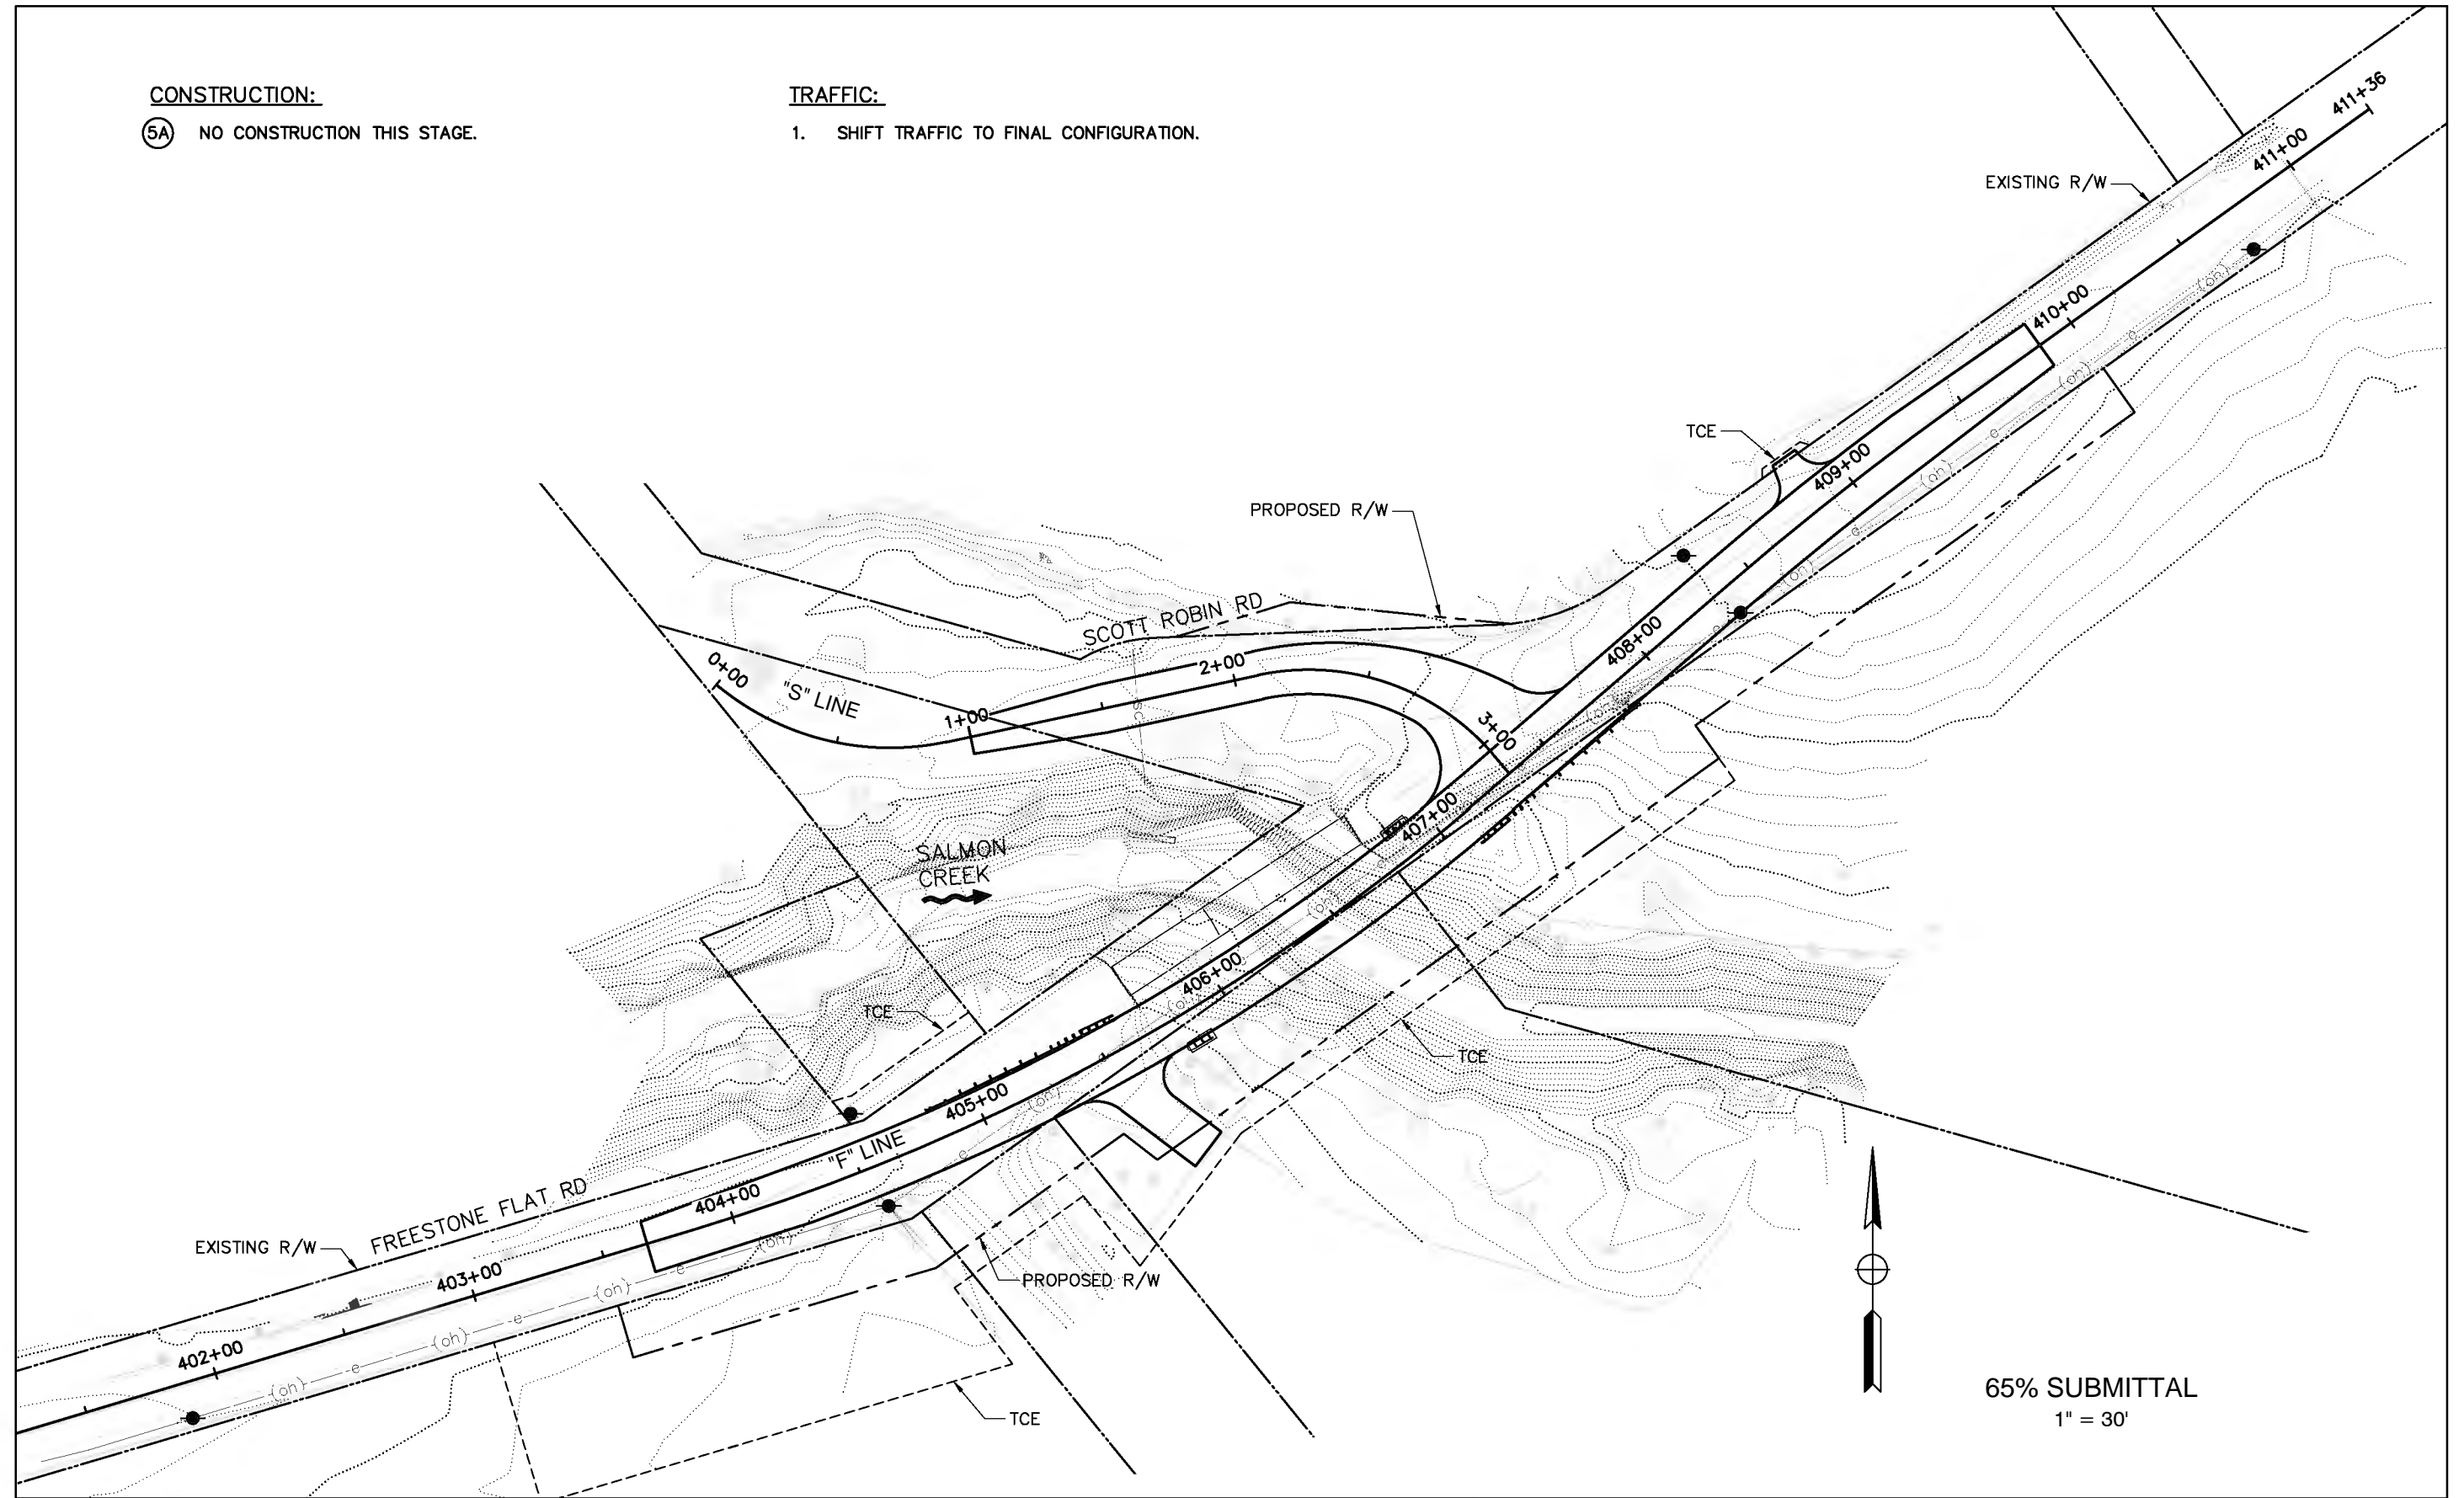

65% SUBMITTAL  
1" = 30'

DESIGN BY	B.GRIMM
DRAWING BY	B.GRIMM
CHECKED BY	DES CHK

REGISTERED CIVIL ENGINEER  
1/31/2018  
PLANS APPROVAL DATE  
S:\CLIENT\SONOMA COUNTY - S22\FREESTONE FLAT ROAD  
S22-200\CAD\ROADWAY\S22-200\_SC-S.DWG 1/31/2018  
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CONSTRUCTION COMPLETED:	
"AS BUILT" INFORMATION TO BE COMPLETED AFTER CONSTRUCTION	
DATE	BY
	APPROVED

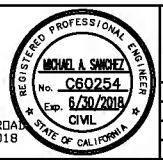QUINCY ENGINEERING, INC.  
11017 Cobblecreek Drive, Suite 100  
Sacramento, CA 95670







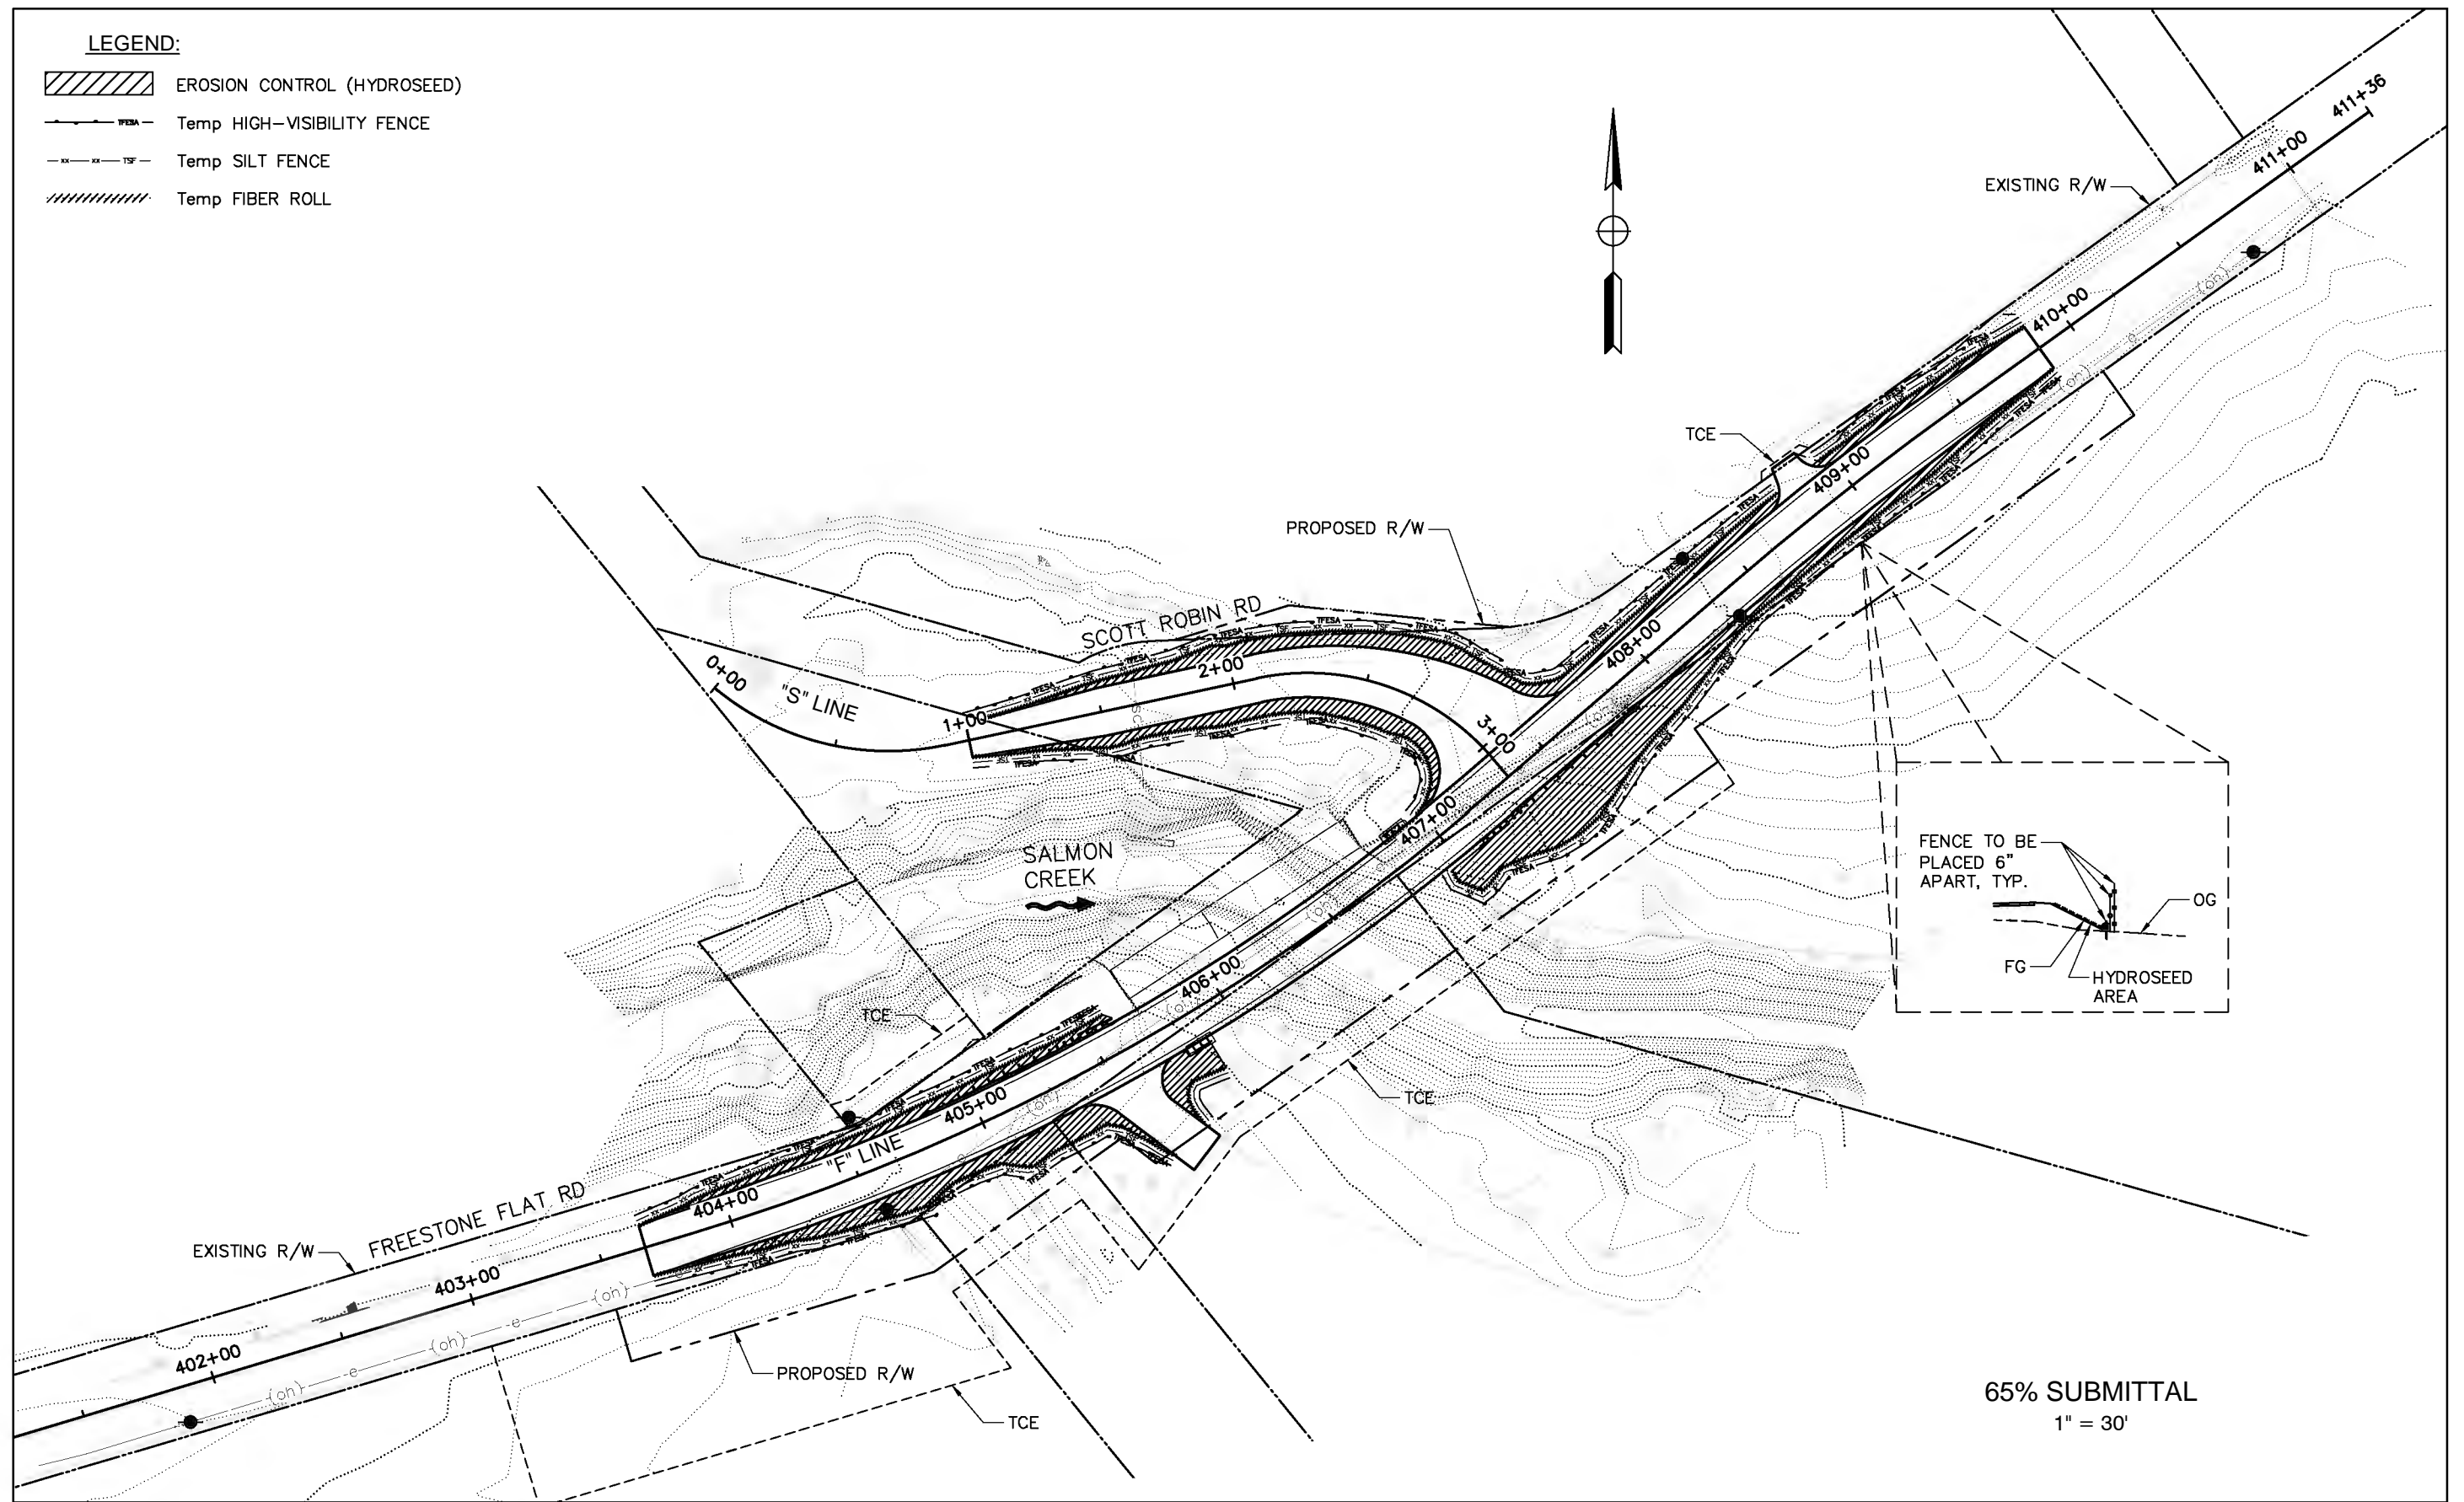
COUNTY OF SONOMA  
DEPARTMENT OF TRANSPORTATION & PUBLIC WORKS  
SUSAN KLASSEN, DIRECTOR

STAGE CONSTRUCTION & TRAFFIC HANDLING  
FREESTONE FLAT ROAD  
BRIDGE REPLACEMENT

ROAD NUMBER	XXX
BUDGET NUMBER	XXX
FISCAL YEAR	2015-16
SHEET NUMBER	15
TOTAL SHEETS	32

**LEGEND:**

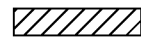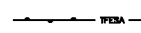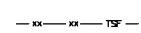-  EROSION CONTROL (HYDROSEED)
-  Temp HIGH-VISIBILITY FENCE
-  Temp SILT FENCE
-  Temp FIBER ROLL




65% SUBMITTAL  
1" = 30'

DESIGN BY	B.GRIMM
DRAWING BY	B.GRIMM
CHECKED BY	DES CHK


REGISTERED CIVIL ENGINEER  
**1/21/2018**

PLANS APPROVAL DATE  
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S22-200\CAD\ROADWAY\S22-200\_EC-1.DWG 1/31/2018  
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

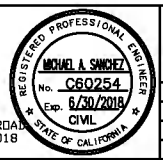
CONSTRUCTION COMPLETED:	
"AS BUILT" INFORMATION TO BE COMPLETED AFTER CONSTRUCTION	
DATE	BY

RESIDENT ENGINEER AS BUILT DRAWINGS BY:



**QUINCY ENGINEERING, INC.**  
11017 Cobblestone Drive, Suite 100  
Sacramento, CA 95670








**COUNTY OF SONOMA**  
DEPARTMENT OF TRANSPORTATION & PUBLIC WORKS  
SUSAN KLASSEN, DIRECTOR

<b>EROSION CONTROL</b>  <b>FREESTONE FLAT ROAD BRIDGE REPLACEMENT</b>	ROAD NUMBER	XXX
	BUDGET NUMBER	XXX
	FISCAL YEAR	2015-16
	SHEET NUMBER	16
	TOTAL SHEETS	32

TO BE COMPLETED AT xx% SUBMITTAL

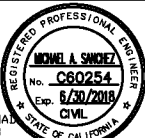65% SUBMITTAL

DESIGN BY	B.GRIMM		CONSTRUCTION COMPLETED:		 <b>QUINCY ENGINEERING, INC.</b> 11017 Cobblerock Drive, Suite 100 Sacramento, CA 95670	 <b>COUNTY OF SONOMA</b> DEPARTMENT OF TRANSPORTATION & PUBLIC WORKS SUSAN KLASSEN, DIRECTOR	SUMMARY OF QUANTITIES		ROAD NUMBER	xxx
DRAWING BY	B.GRIMM		*AS BUILT* INFORMATION TO BE COMPLETED AFTER CONSTRUCTION RESIDENT ENGINEER AS BUILT DRAWINGS BY:				BUDGET NUMBER	xxx		
CHECKED BY	DES CHK		PLANS APPROVAL DATE S:\CLIENT\SONOMA COUNTY - S22\FREESTONE FLAT ROAD\S22-200\CAD\ROADWAY\S22-200_Q-1.DWG 1/31/2018 9:57 AM	DATE			BY	APPROVED	FISCAL YEAR	2015-16
							<b>FREESTONE FLAT ROAD          BRIDGE REPLACEMENT</b>		SHEET NUMBER	17
									TOTAL SHEETS	32

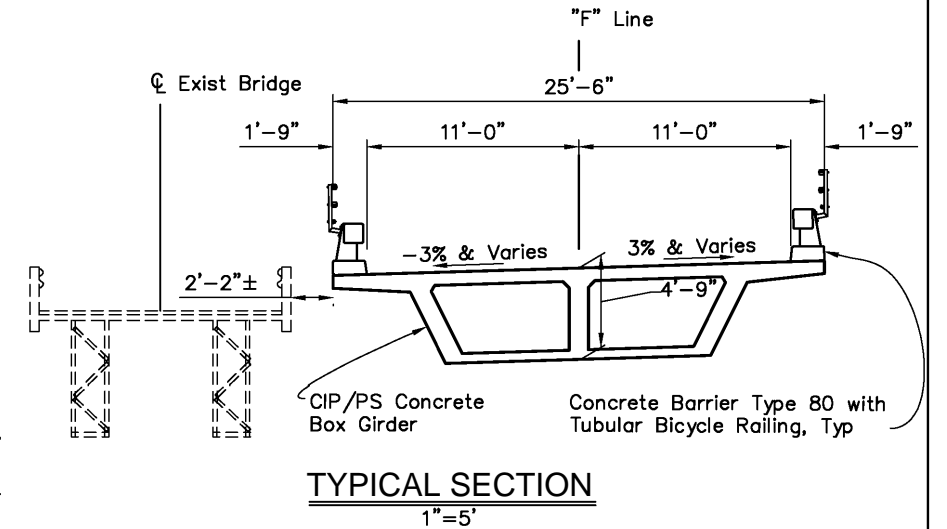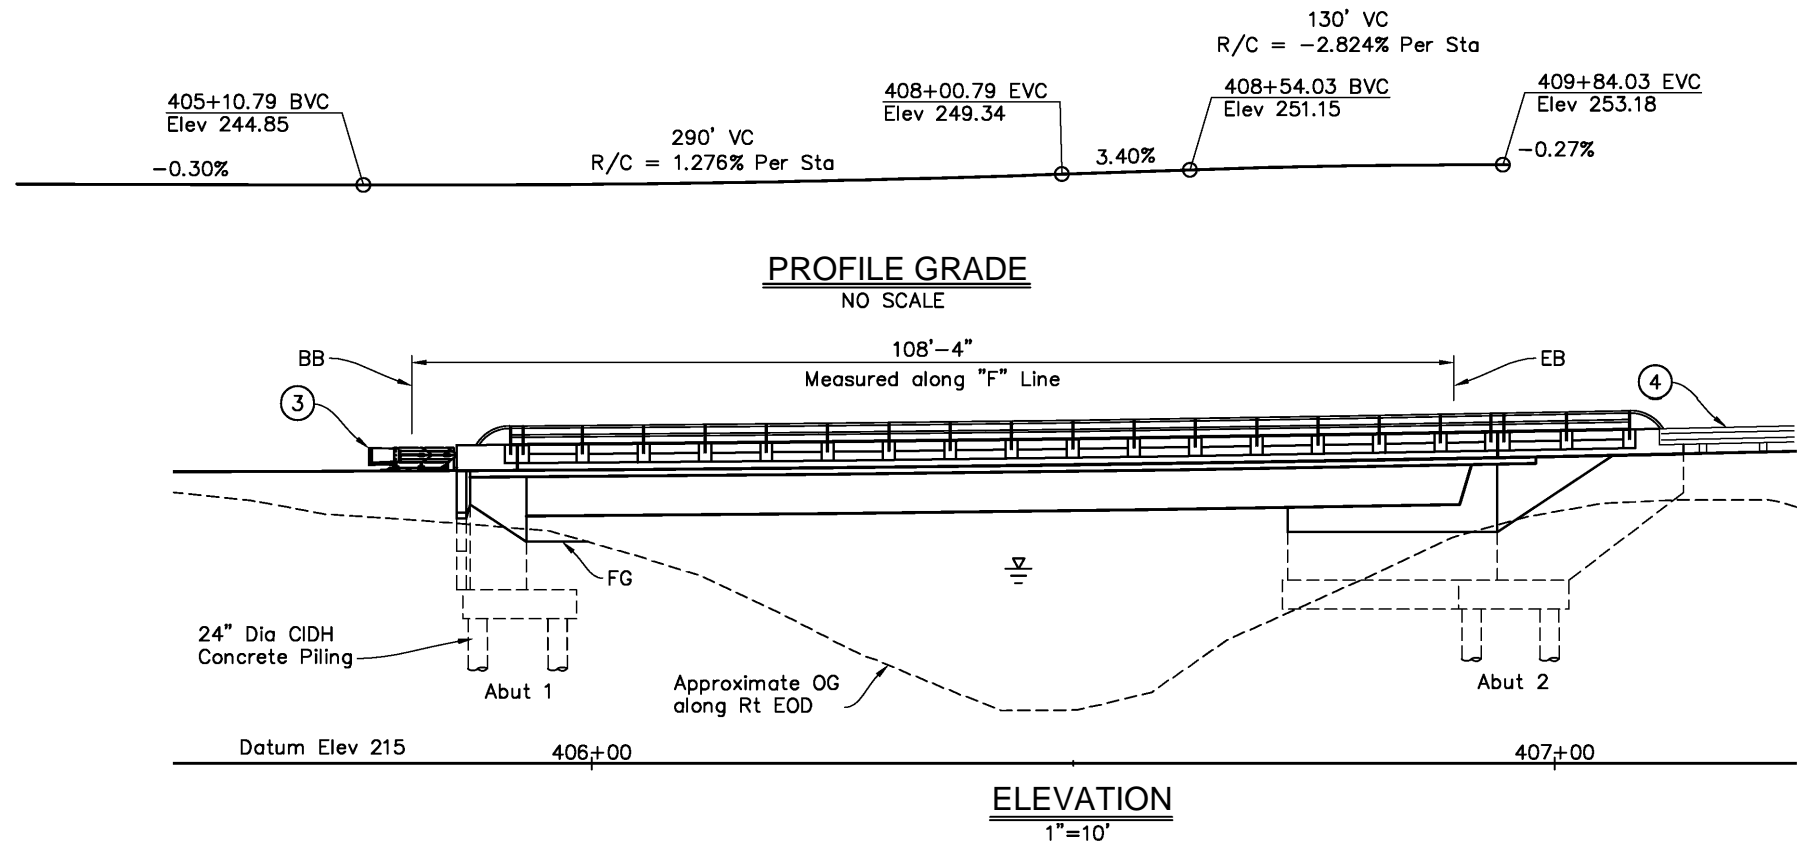


**INDEX TO PLANS**

Sheet No.	Title
18	General Plan
19	General Notes
20	Deck Contours
21	Foundation Plan
22	Abutment 1 Layout
23	Abutment 2 Layout
24	Abutment Details No. 1
25	Abutment Details No. 2
26	Abutment Details No. 3
27	Typical Section
28	Girder Layout
29	Girder Reinforcement No. 1
30	Girder Reinforcement No. 2
31	Tubular Bicycle Railing Details
32	Log of Text Borings

- Legend:
- ① Paint "XXX Bridge"
  - ② Paint "No. XXX-XXXX"
  - ③ Quad Guard
  - ④ MGS, see Road Plans
  - ≍ Highwater elevation
  - Existing structure

Note:  
1. For General Notes, Quantities and Hydrologic Summary, see "General Notes" sheet.

65% SUBMITTAL

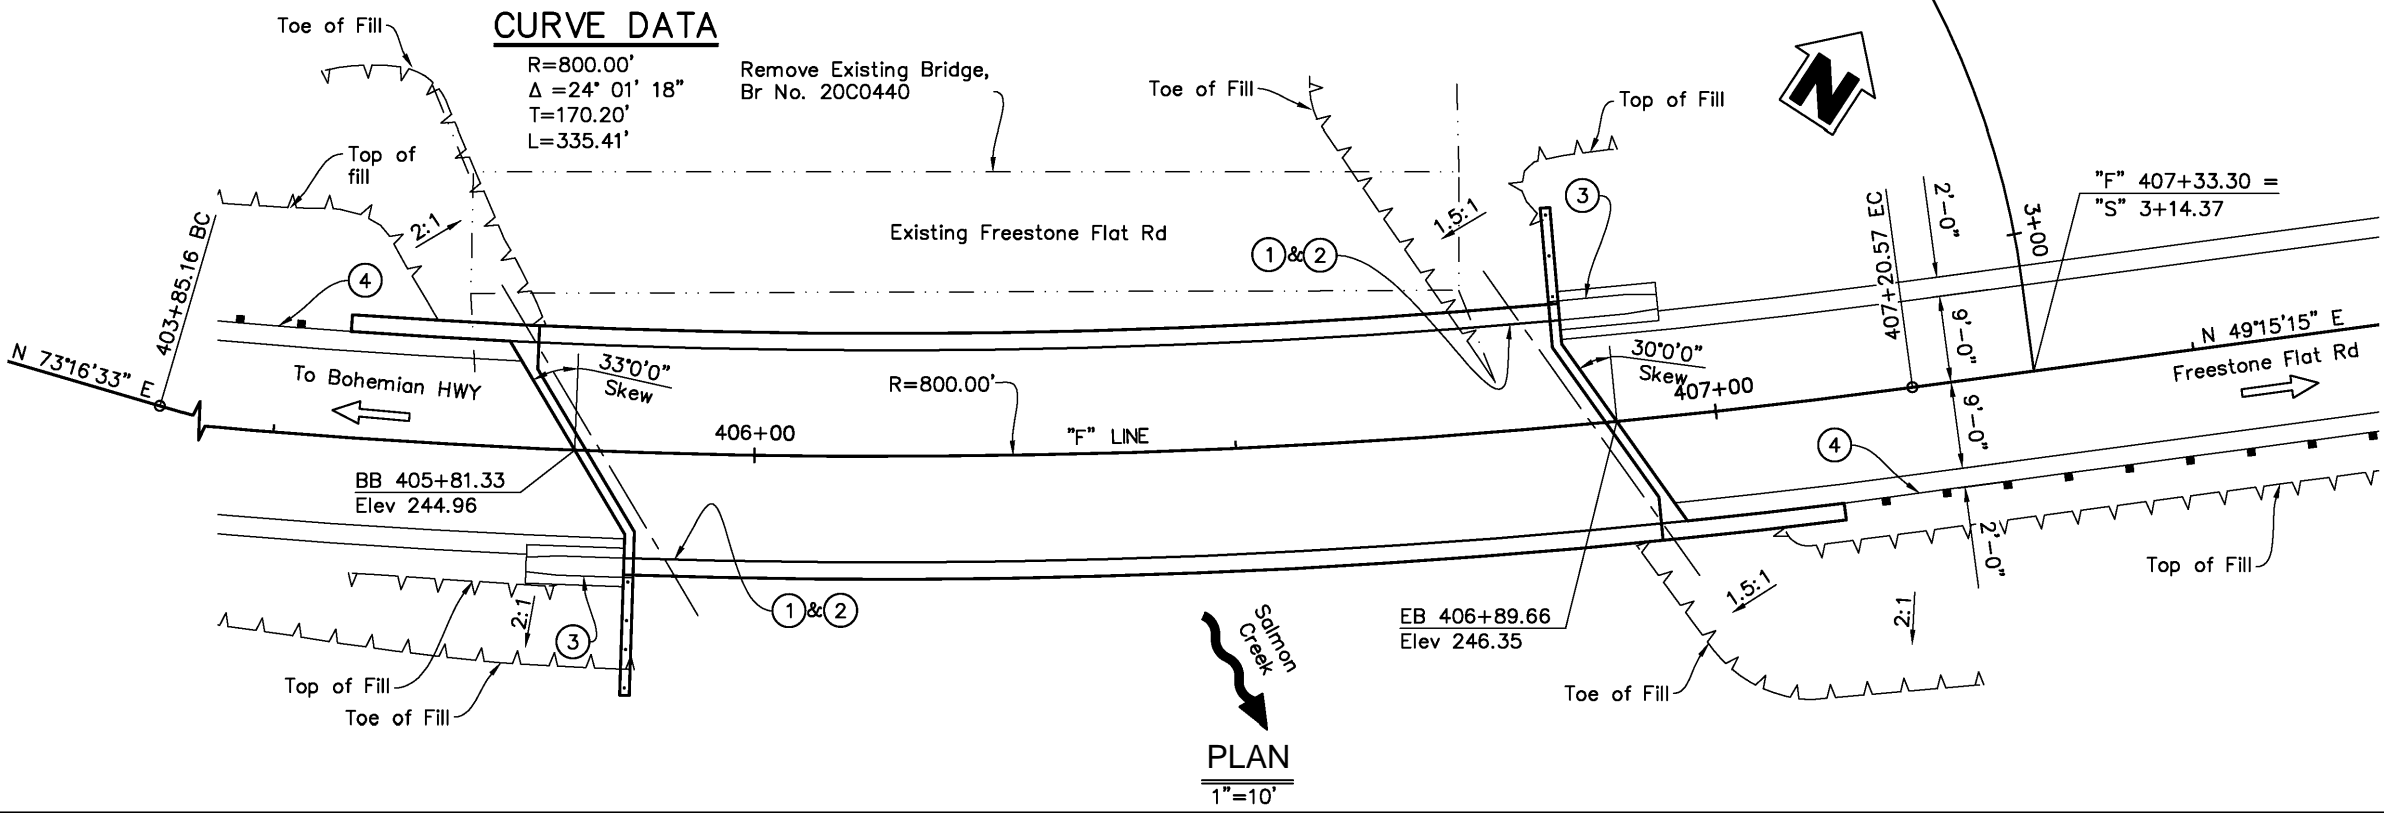

DESIGN BY S. SALVADOR  
DRAWING BY P. KENNEY  
CHECKED BY DES CHK

REGISTERED CIVIL ENGINEER  
1/31/2018  
PLANS APPROVAL DATE  
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S22-200\CAD\BRIDGE\S22200A-A-GP01.DWG 1/30/2018  
2:36 PM

CONSTRUCTION COMPLETED:  
RESIDENT ENGINEER AS BUILT DRAWINGS BY:  
DATE BY APPROVED

QUINCY ENGINEERING, INC.  
11017 Coblerock Drive, Suite 100  
Sacramento, CA 95670

COUNTY OF SONOMA  
DEPARTMENT OF TRANSPORTATION & PUBLIC WORKS  
SUSAN KLASSEN, DIRECTOR

GENERAL PLAN		ROAD NUMBER	XXX
FREESTONE FLAT ROAD BRIDGE REPLACEMENT		BUDGET NUMBER	XXX
		FISCAL YEAR	2015-16
		SHEET NUMBER	18
		TOTAL SHEETS	32



**QUANTITIES**

Bridge Removal	LUMP	SUM
Structure Excavation (Bridge)	XX	CY
Structure Excavation	XX	CY
Structure Backfill (Bridge)	XX	CY
24" Cast-In-Drilled Hole Piling	XX	LF
Prestressing Cast-In-Place Concrete	LUMP	SUM
Structural Concrete, Bridge Footing	XX	CY
Structural Concrete, Bridge	XX	CY
Structural Concrete, Bridge (Polymer Fiber)	XX	CY
Joint Seal (Type B)	XX	LF
Bar Reinforcing Steel Bridge	XX	LB
Tubular Bicycle Railing	XX	LF
Concrete Barrier (Type 80)	XX	LF

**2015 CALTRANS STANDARD PLANS**

A3A	Abbreviations (Sheet 1 of 3)
A3B	Abbreviations (Sheet 2 of 3)
A3C	Abbreviations (Sheet 2 of 3)
A10A	Legend - Lines and Symbols (Sheet 1 of 5)
RSP A10B	Legend - Lines and Symbols (Sheet 2 of 5)
A10C	Legend - Lines and Symbols (Sheet 3 of 5)
A10D	Legend - Lines and Symbols (Sheet 4 of 5)
A10E	Legend - Lines and Symbols (Sheet 5 of 5)
A10F	Legend - Soil (Sheet 1 of 2)
A10G	Legend - Soil (Sheet 2 of 2)
A10H	Legend - Rock
A62C	Limits of Payment for Excavation and Backfill - Bridge
B0-1	Bridge Details
B0-3	Bridge Details
B0-5	Bridge Details
B0-13	Bridge Details
B6-21	Joint Seals (Maximum Movement Rating = 2")
B7-1	Box Girder Details
RSP B8-5	Cast-in-Place Post-Tensioned Girder Details
RSP B9-6	Structure Approach - Drainage Details
B11-60	Concrete Barrier Type 80 (Sheet 1 of 2)
B11-61	Concrete Barrier Type 80 (Sheet 2 of 2)

**HYDROLOGIC SUMMARY**



Drainage area:	2.4 Square Miles	
	Design Flood	Base Flood
Frequency (years)	50	100
Discharge (cubic feet per second)	1540	1790
Water Surface Elev at Bridge (ft)	233.7	235.2

Flood plain data based upon information available when the plans were prepared and are shown to meet Federal requirements. The accuracy of said information is not warranted by the County and interested or affected parties should make their own investigations.

**GENERAL NOTES**

**LOAD AND RESISTANCE FACTOR DESIGN**


- DESIGN:** AASHTO LRFD Bridge Design Specifications, 6th edition with California Amendments; except that Standard Bridge Detail XS sheets are designed using Bridge Design Specifications (1996 AASHTO w/Revisions by Caltrans).
- SEISMIC DESIGN:** Caltrans Seismic Design Criteria (SDC), version 1.7, dated April 2013.
- DEAD LOAD:** Includes 35 psf for future wearing surface.
- LIVE LOADING:** HL93 and permit design load.
- SEISMIC LOADING:** Soil profile  $V_{s30} = 250$  m/s  
Moment Magnitude  $M_{max} = 8.0$   
Peak Ground Acceleration = 0.55 g
- REINFORCED CONCRETE:**
- $f_y = 60$  ksi
  - $f'_c = 3.6$  ksi, unless otherwise noted
  - $n = 8$
- PRESTRESSED CONCRETE:** See "Prestressing Notes" on "Girder Layout" sheet.

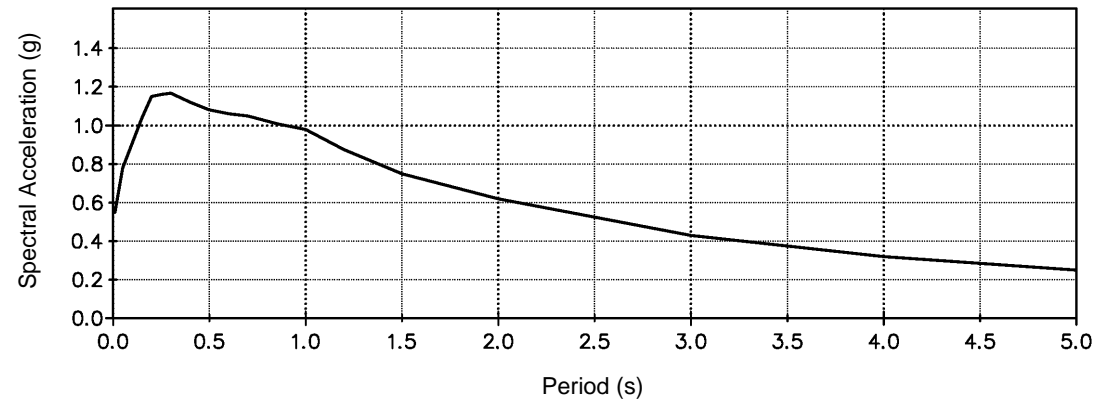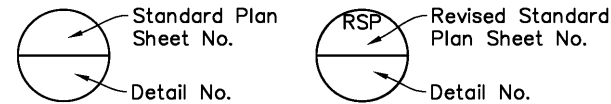

**ACCELERATION RESPONSE SPECTRA CURVE**


65% SUBMITTAL

DESIGN BY <b>S. SALVADOR</b>	REGISTERED CIVIL ENGINEER <b>1/31/2018</b>	CONSTRUCTION COMPLETED: DATE: _____ BY: _____ APPROVED: _____	<b>QUINCY ENGINEERING, INC.</b> 11017 Cobblerock Drive, Suite 100 Sacramento, CA 95670	<b>COUNTY OF SONOMA</b> DEPARTMENT OF TRANSPORTATION & PUBLIC WORKS SUSAN KLASSEN, DIRECTOR	<b>GENERAL NOTES</b> <b>FREESTONE FLAT ROAD</b> <b>BRIDGE REPLACEMENT</b>	ROAD NUMBER: XXX BUDGET NUMBER: XXX FISCAL YEAR: 2015-16 SHEET NUMBER: 19 TOTAL SHEETS: 32
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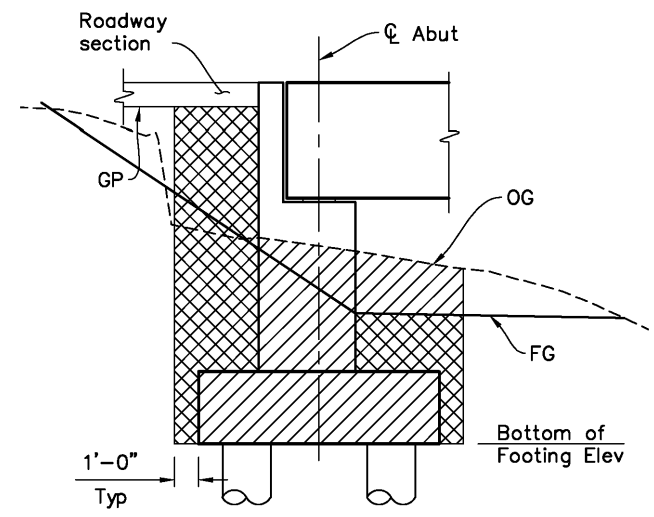


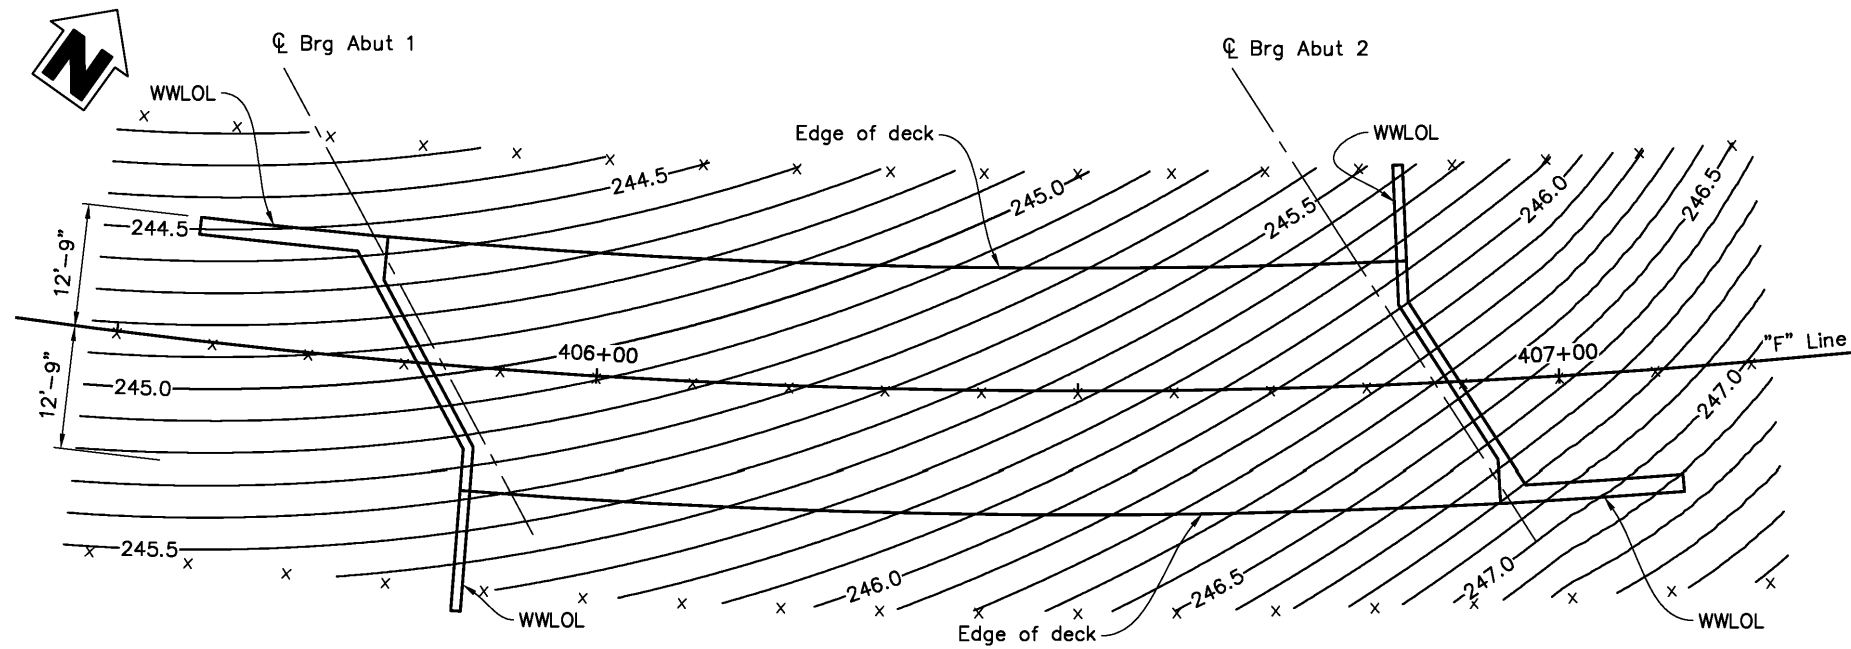Notes:  
 X = 10' intervals along station line  
 Contours Intervals = 0.10'  
 Contours do not include camber

**PLAN**  
 1"=10'

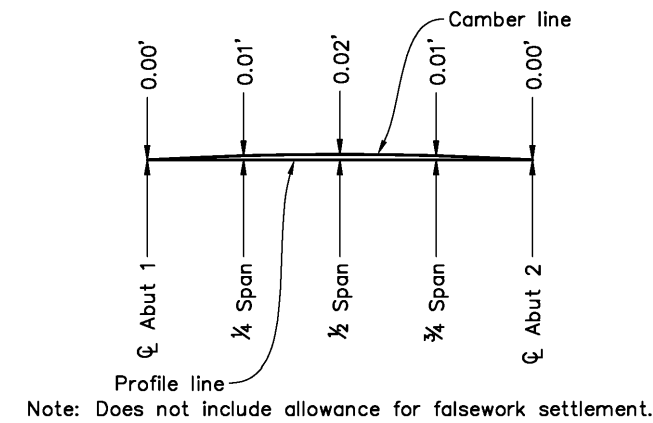


**CAMBER DIAGRAM**  
 No Scale



**ABUTMENT TYPICAL SECTION**

- Indicates Structure Excavation (Bridge)
- Indicates Structure Backfill (Bridge)

**LIMITS OF PAYMENT FOR EXCAVATION AND BACKFILL**  
 No Scale

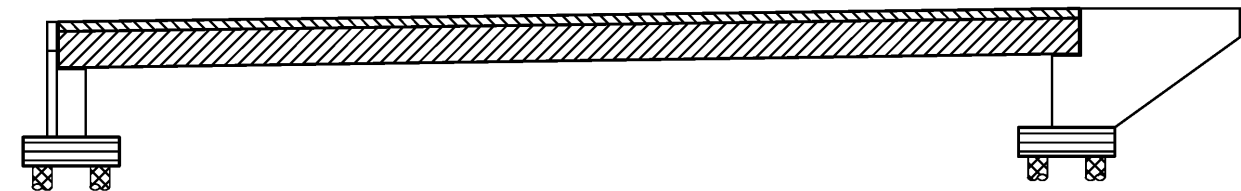

- Structural Concrete, Bridge
- Structural Concrete, Bridge (Polymer Fiber) (f'c=4.0 ksi at 28 days)
- Structural Concrete, Bridge Footing
- CIDH Concrete Piling (f'c=4.0 ksi at 28 days)
- Structural Concrete, Bridge (f'c=4.0 ksi at 28 days)

**CONCRETE STRENGTH AND TYPE LIMITS** 65% SUBMITTAL  
 No Scale

DESIGN BY	S. SALVADOR
DRAWING BY	P. KENNEY
CHECKED BY	DES CHK


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 1/31/2018  
 PLANS APPROVAL DATE  
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 S22-200\CAD\BRIDGE\S22200A-D-DC01.DWG 1/30/2018  
 2:36 PM

CONSTRUCTION COMPLETED:	
"AS BUILT" INFORMATION TO BE COMPLETED AFTER CONSTRUCTION	
DATE	BY
	APPROVED

QUINCY ENGINEERING, INC.  
 11017 Cobblerock Drive, Suite 100  
 Sacramento, CA 95670

COUNTY OF SONOMA  
 DEPARTMENT OF TRANSPORTATION & PUBLIC WORKS  
 SUSAN KLASSEN, DIRECTOR

DECK CONTOURS	
FREESTONE FLAT ROAD BRIDGE REPLACEMENT	
ROAD NUMBER	XXX
BUDGET NUMBER	XXX
FISCAL YEAR	2015-16
SHEET NUMBER	20
TOTAL SHEETS	32

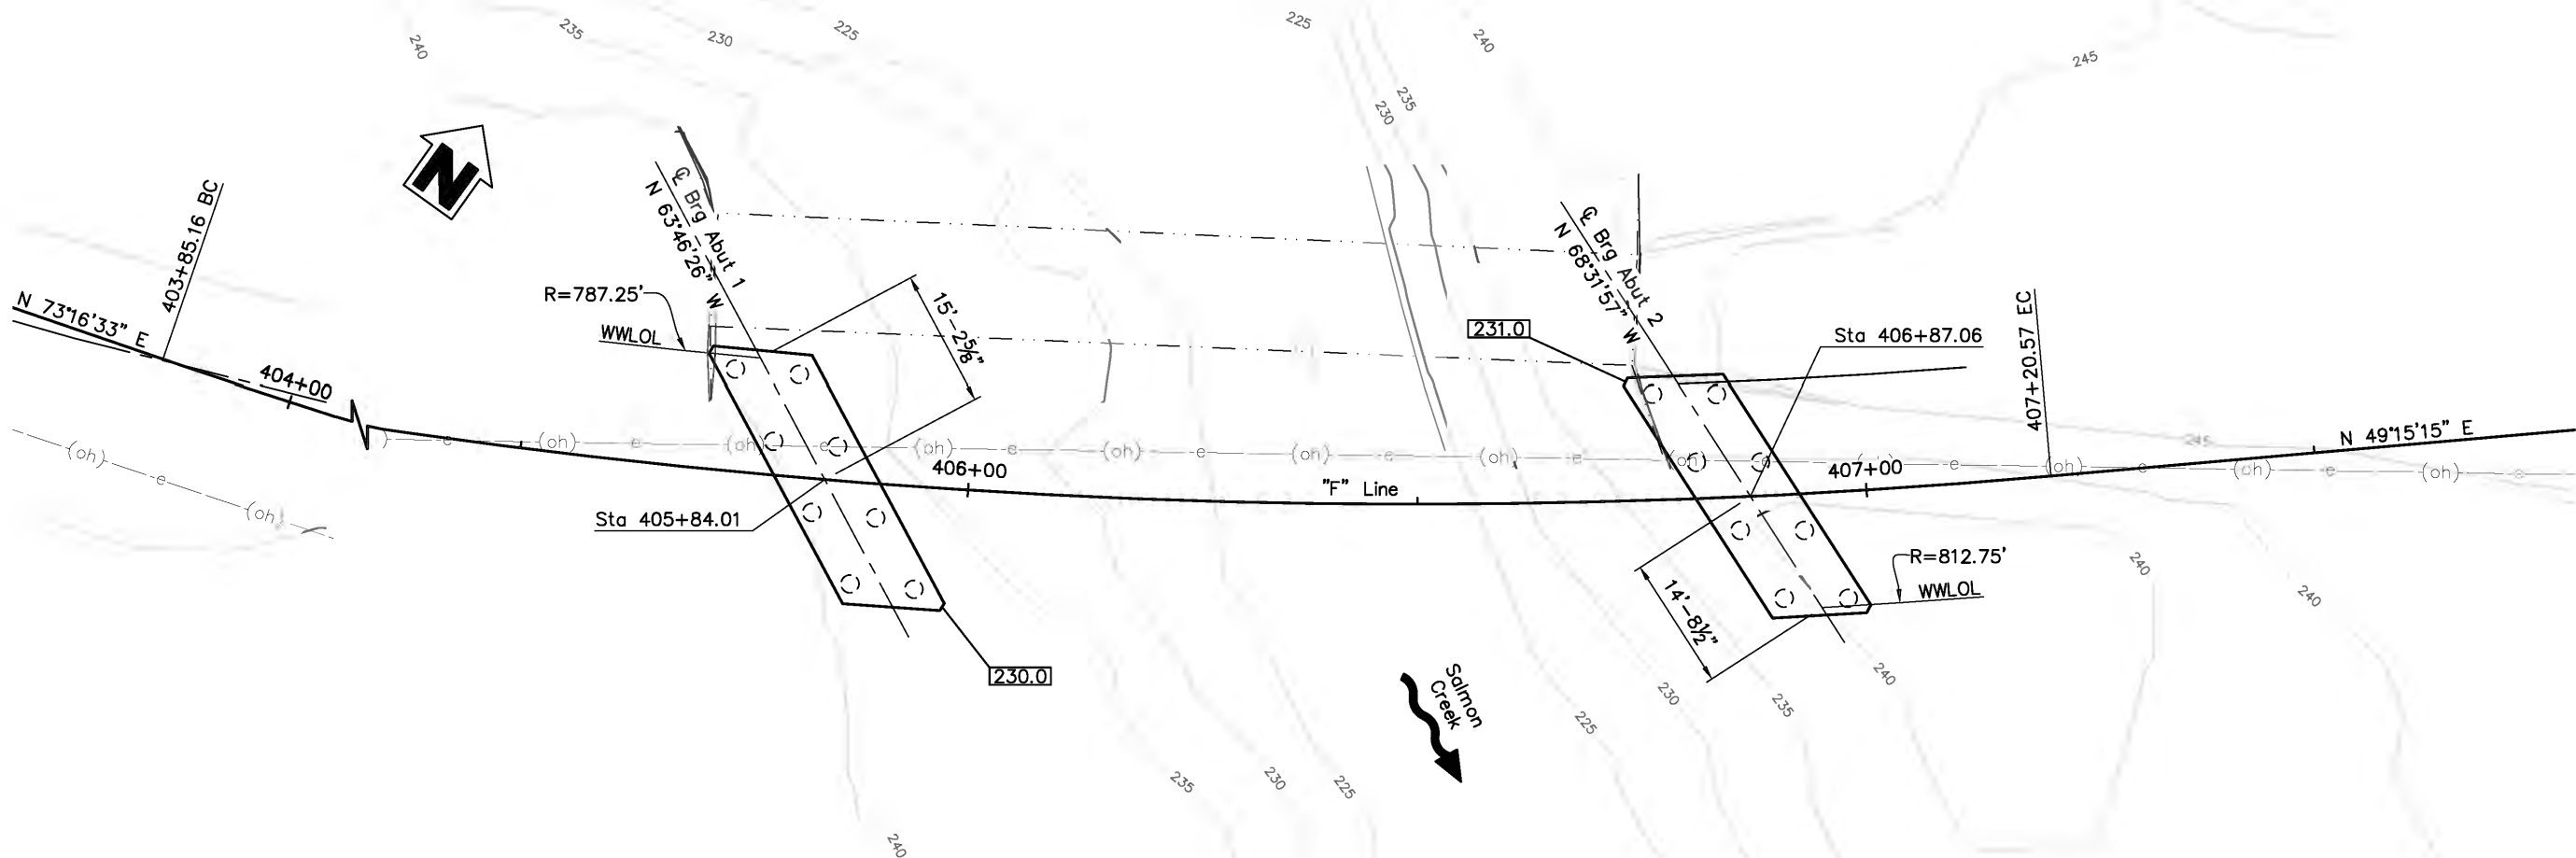

SCOUR DATA TABLE

SUPPORT No.	LONG TERM (DEGRADATION AND CONTRACTION) SCOUR ELEVATION (ft)	SHORT TERM (LOCAL) SCOUR DEPTH (ft)
Abut 1	232.4	0
Abut 2	232.4	0

Thalweg Elev: 220.00

PLAN  
1"=10'

Legend:  
 X.X Indicates bottom of footing elevation  
 ○ Indicates vertical pile

BENCH MARK DATA

No.	NORTHING	EASTING	ELEVATION	LINE	STATION	OFFSET	DESCRIPTION
1	1901509.829	6297473.345	252.05	"F"	411+53.82	7.85' Rt	MAG DOTPW 1
2	1901375.763	6297285.227	252.82	"F"	409+22.66	6.97' Rt	MAG DOTPW 2
3	1901301.460	6297143.651	247.30	"F"	407+66.38	26.44' Lt	MAG DOTPW 3
4	1901119.633	6296937.868	244.53	"F"	404+91.49	9.98' Rt	MAG DOTPW 4
5	1901004.458	6296575.558	246.58	"F"	401+12.38	8.88' Rt	MAG DOTPW 5
6	1901263.84	6296891.491	241.48	"F"	405+12.33	140.30' Lt	MAG DOTPW 6
7	1901169.129	6296988.133	244.59	"F"	405+58.75	139.44' Lt	MAG DOTPW 7

PILE DATA TABLE

LOCATION	PILE TYPE	NOMINAL RESISTANCE		DESIGN TIP ELEVATION	SPECIFIED TIP ELEVATION
		COMPRESSION	TENSION		
Abut 1	24" CIDH	360 kips	0	195(a), 215(b)	195.0
Abut 2	24" CIDH	360 kips	0	205(a), 215(b)	205.0

Notes:  
 1. Design Tip Elevation is controlled by the following demands:  
 (a) Compression, (b) Tension, (c) Lateral Loads (d) Settlement.  
 2. The specific tip elevation shall not be raised above design tip elevations for lateral and tolerable settlement.

65% SUBMITTAL

DESIGN BY S. SALVADOR  
 DRAWING BY P. KENNEY  
 CHECKED BY DES CHK

REGISTERED CIVIL ENGINEER  
 1/31/2018  
 PLANS APPROVAL DATE  
 S:\CLIENT\SONOMA COUNTY - S22\FREESTONE FLAT ROAD  
 S22-200\CAD\BRIDGE\S22200A-E-FPL01.DWG 1/30/2018  
 2:36 PM

CONSTRUCTION COMPLETED  
 "AS BUILT" INFORMATION TO BE COMPLETED AFTER CONSTRUCTION  
 RESIDENT ENGINEER AS BUILT DRAWINGS BY:  
 DATE BY APPROVED

QUINCY ENGINEERING, INC.  
 11017 Cobblerock Drive, Suite 100  
 Sacramento, CA 95670

COUNTY OF SONOMA  
 DEPARTMENT OF TRANSPORTATION & PUBLIC WORKS  
 SUSAN KLASSEN, DIRECTOR


FOUNDATION PLAN  
 FREESTONE FLAT ROAD  
 BRIDGE REPLACEMENT

ROAD NUMBER	XXX
BUDGET NUMBER	XXX
FISCAL YEAR	2015-16
SHEET NUMBER	21
TOTAL SHEETS	32









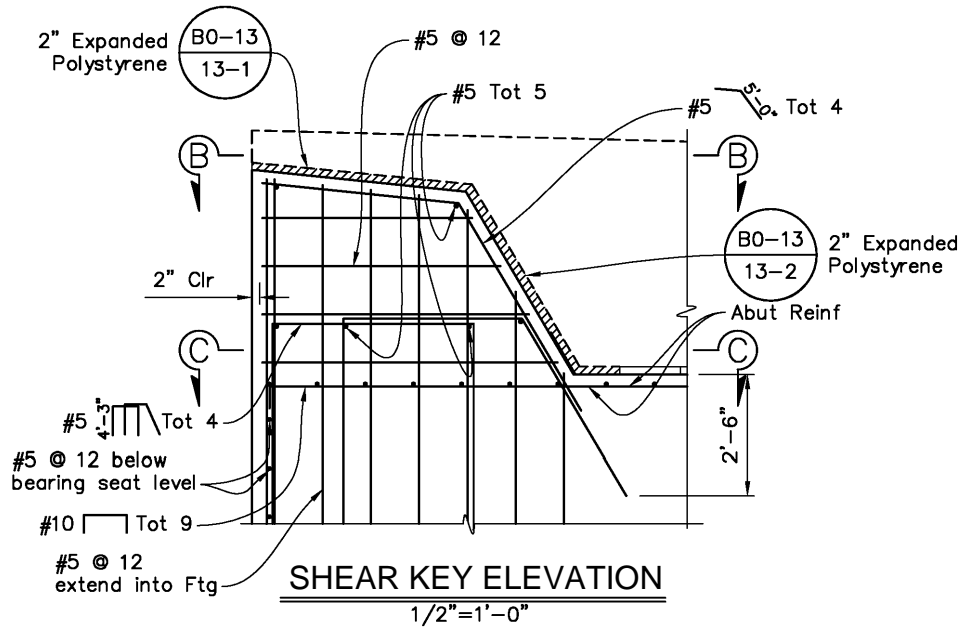

Notes:  
 1. Abutment 1 shown, Abutment 2 similar.

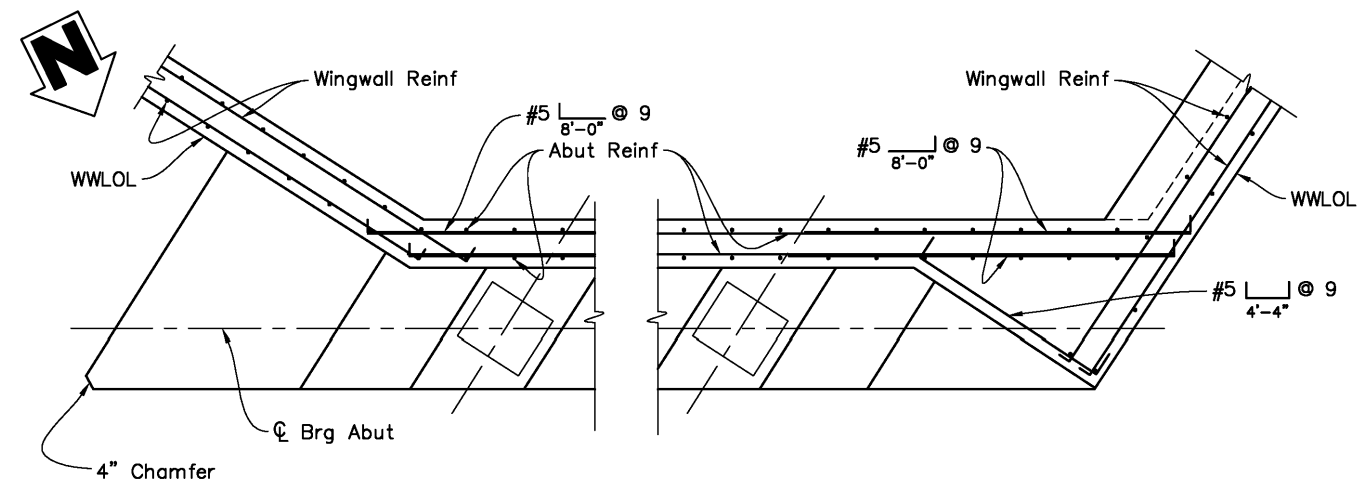


SECTION B-B  
 1/2"=1'-0"

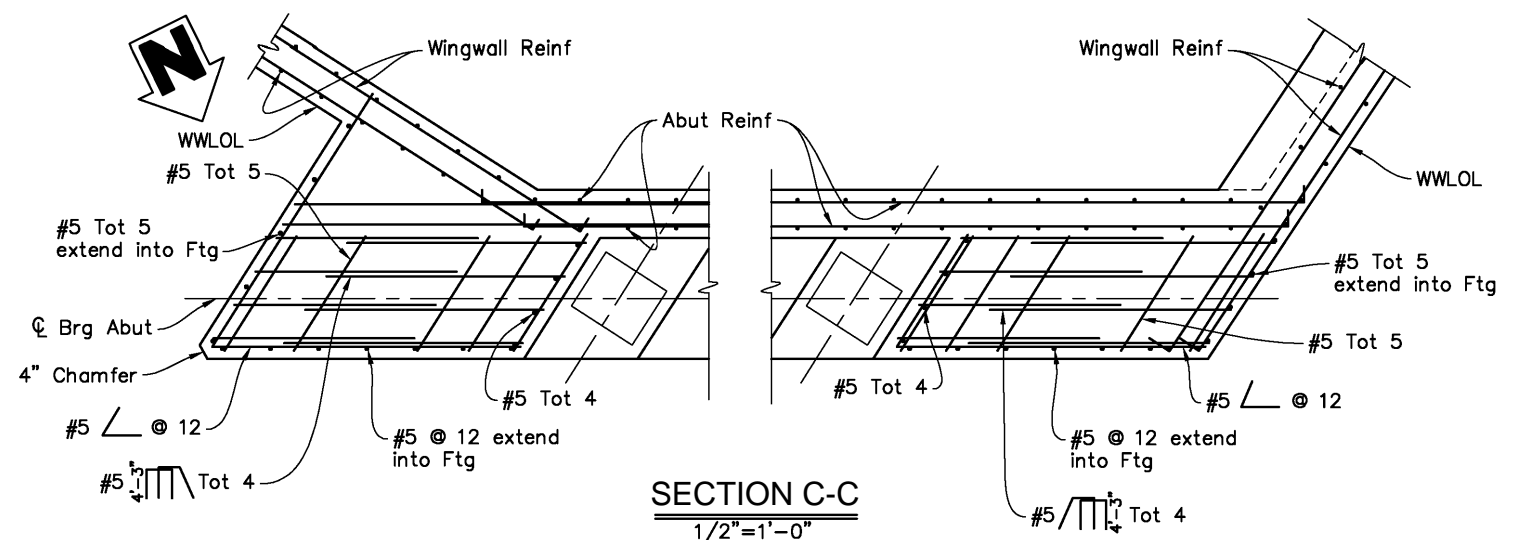

SECTION C-C  
 1/2"=1'-0"

65% SUBMITTAL



DESIGN BY	S. SALVADOR		CONSTRUCTION COMPLETED:		QUINCY ENGINEERING, INC. 11017 Cobblecreek Drive, Suite 100 Sacramento, CA 95670		COUNTY OF SONOMA DEPARTMENT OF TRANSPORTATION & PUBLIC WORKS SUSAN KLASSEN, DIRECTOR	ABUTMENT DETAILS NO. 1	ROAD NUMBER	XXX
DRAWING BY	P. KENNEY		REGISTERED CIVIL ENGINEER					RESIDENT ENGINEER	BUDGET NUMBER	XXX
CHECKED BY	DES CHK		1/31/2018					AS BUILT DRAWINGS BY:	FISCAL YEAR	2015-16
PLANS APPROVAL DATE: 1/30/2018 2:37 PM S:\CLIENT\SONOMA COUNTY - S22\FREESTONE FLAT ROAD BRIDGE\200\CAD\BRIDGE\S22200A-F-A01D11.DWG								SHEET NUMBER	24	
								TOTAL SHEETS	32	

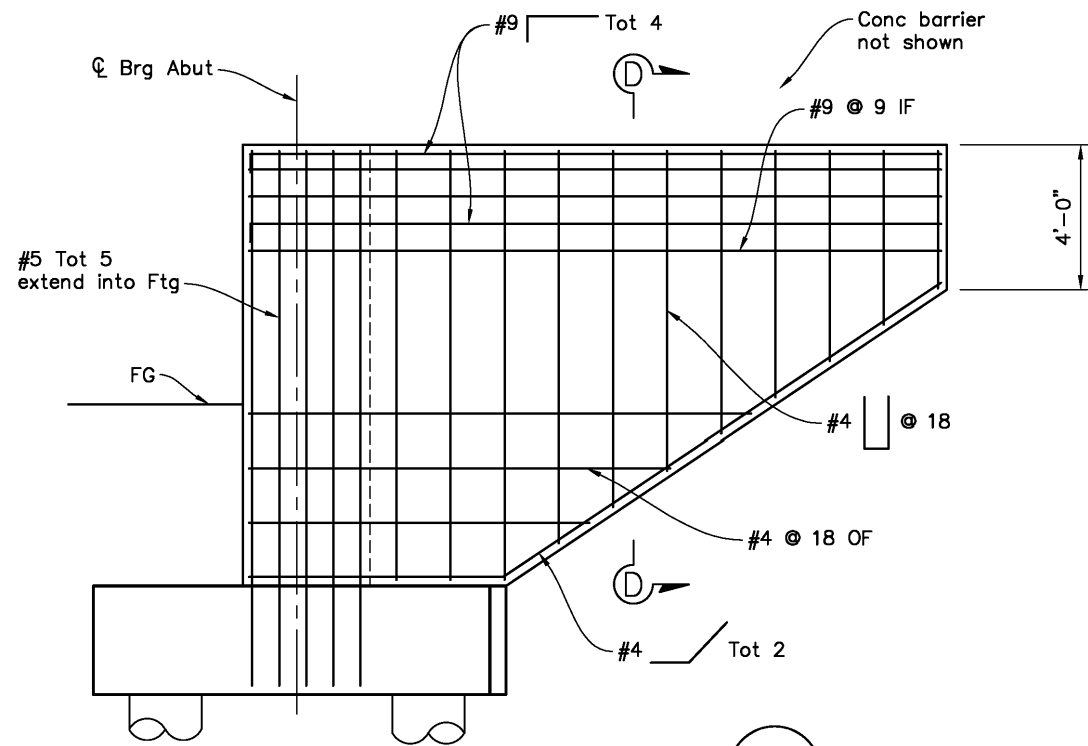

Note:  
Abutment 1 left wingwall and  
Abutment 2 right wingwall shown.


**WINGWALL ELEVATION**

3/8" = 1'-0"

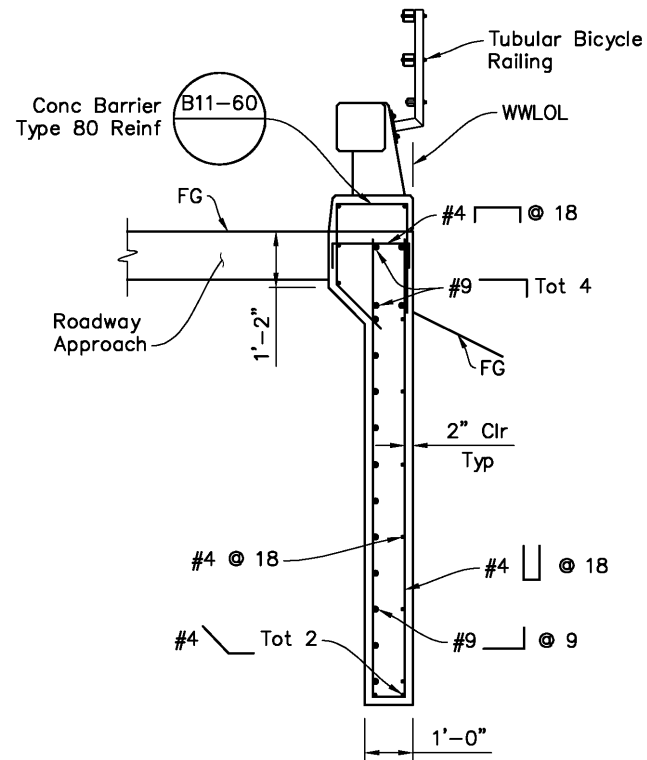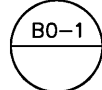


**SECTION D-D**

1/2" = 1'-0"

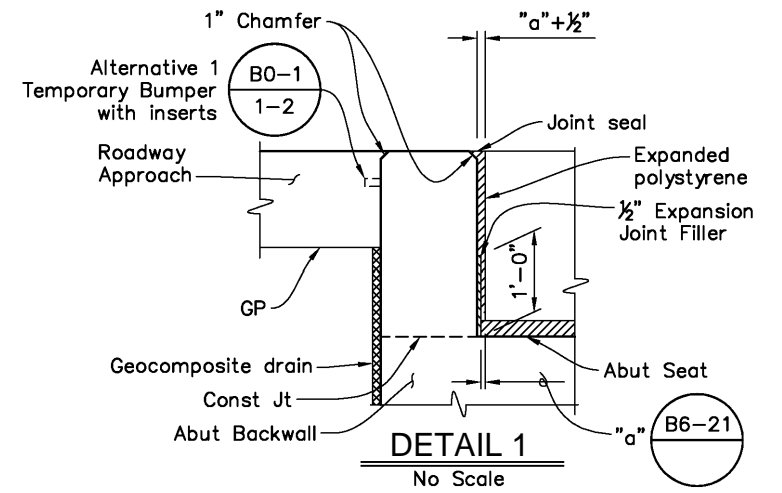


**DETAIL 1**  
No Scale

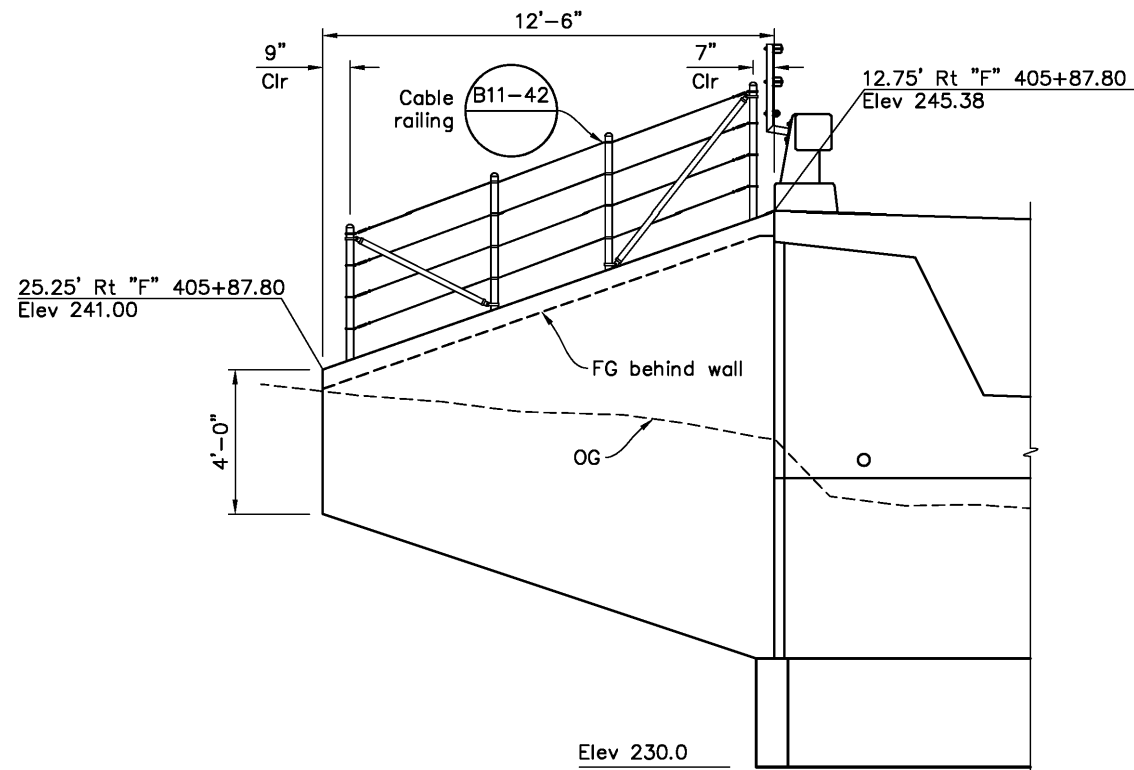

**WINGWALL ELEVATION - ABUTMENT 1 RIGHT**

3/8" = 1'-0"

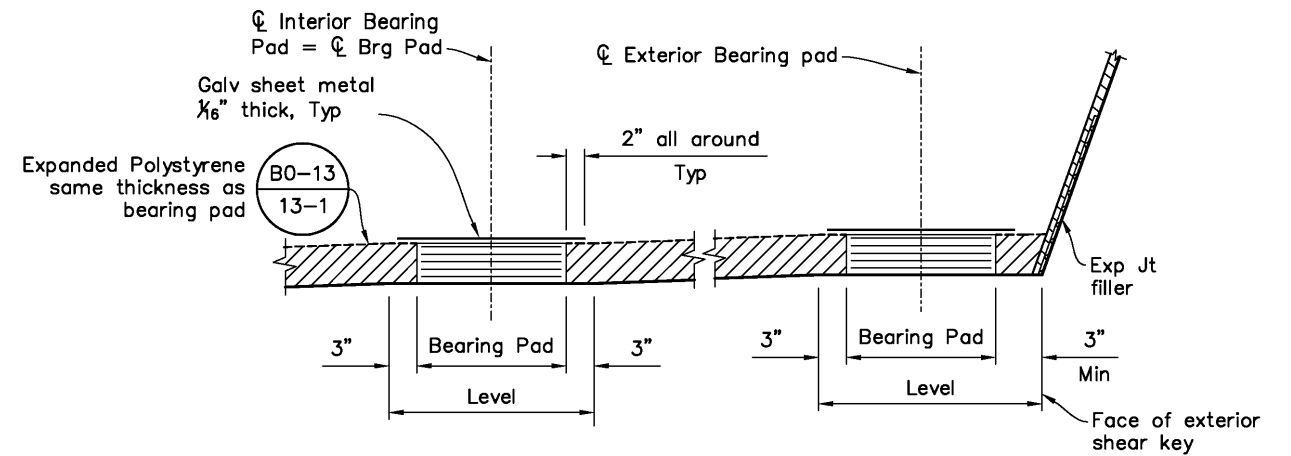

Note: Coat top of Bearing Pad with silicon grease prior to placing sheet metal.

**BEARING PAD DETAIL**

No Scale

Notes:

1. Portion of wingwall to be constructed during Stage 4A. Shoring may be required to maintain traffic.

65% SUBMITTAL

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DRAWING BY	P. KENNEY
CHECKED BY	DES CHK

REGISTERED CIVIL ENGINEER  
1/31/2018

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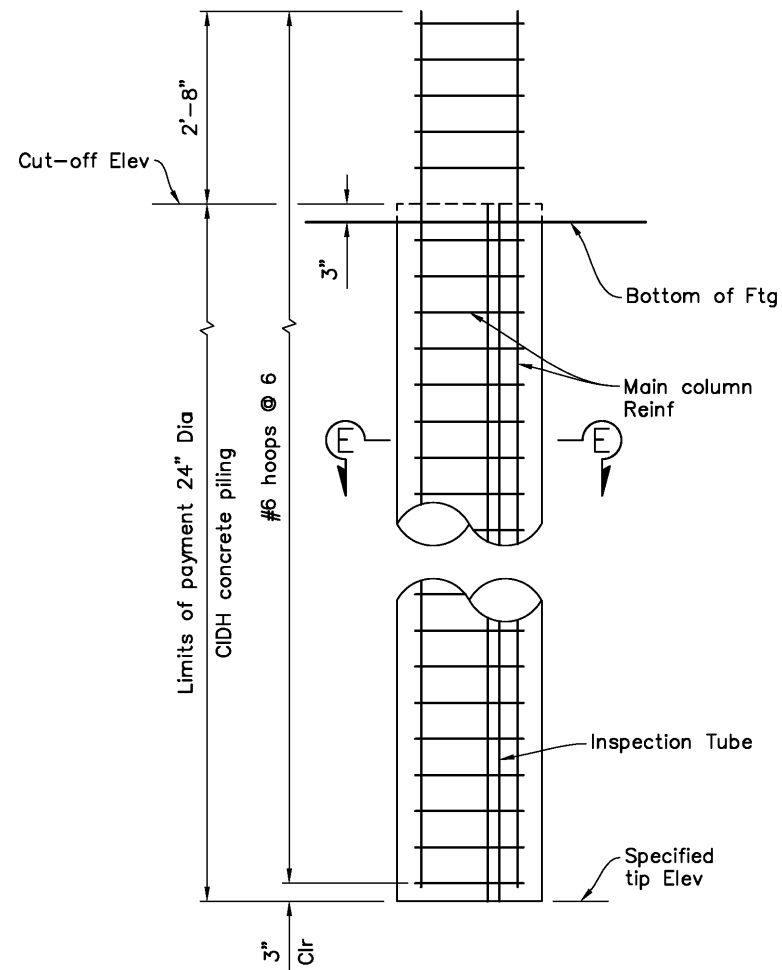
CONSTRUCTION COMPLETED:	
DATE	BY
RESIDENT ENGINEER AS BUILT DRAWINGS BY:	
APPROVED	

QUINCY ENGINEERING, INC.  
11017 Cobblerock Drive, Suite 100  
Sacramento, CA 95670


**COUNTY OF SONOMA**  
DEPARTMENT OF TRANSPORTATION & PUBLIC WORKS  
SUSAN KLASSEN, DIRECTOR

ABUTMENT DETAILS NO. 2	
ROAD NUMBER	XXX
BUDGET NUMBER	XXX
FISCAL YEAR	2015-16
SHEET NUMBER	25
TOTAL SHEETS	32


**FREESTONE FLAT ROAD  
BRIDGE REPLACEMENT**




**24" CIDH CONCRETE PILE**  
3/4"=1'-0"

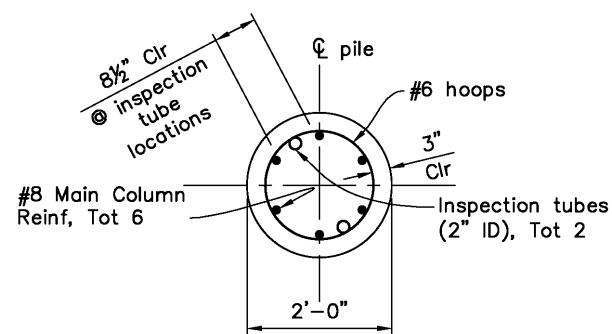

**SECTION E-E**  
Scale

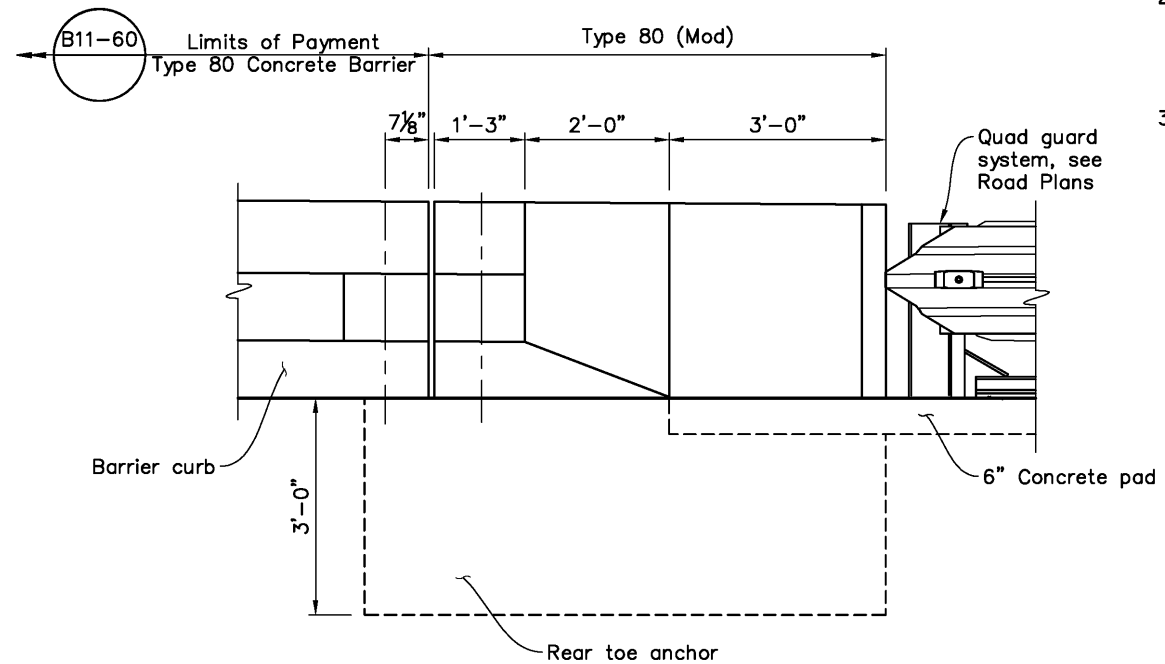

**QUAD GUARD CONNECTION**  
3/4"=1'-0"

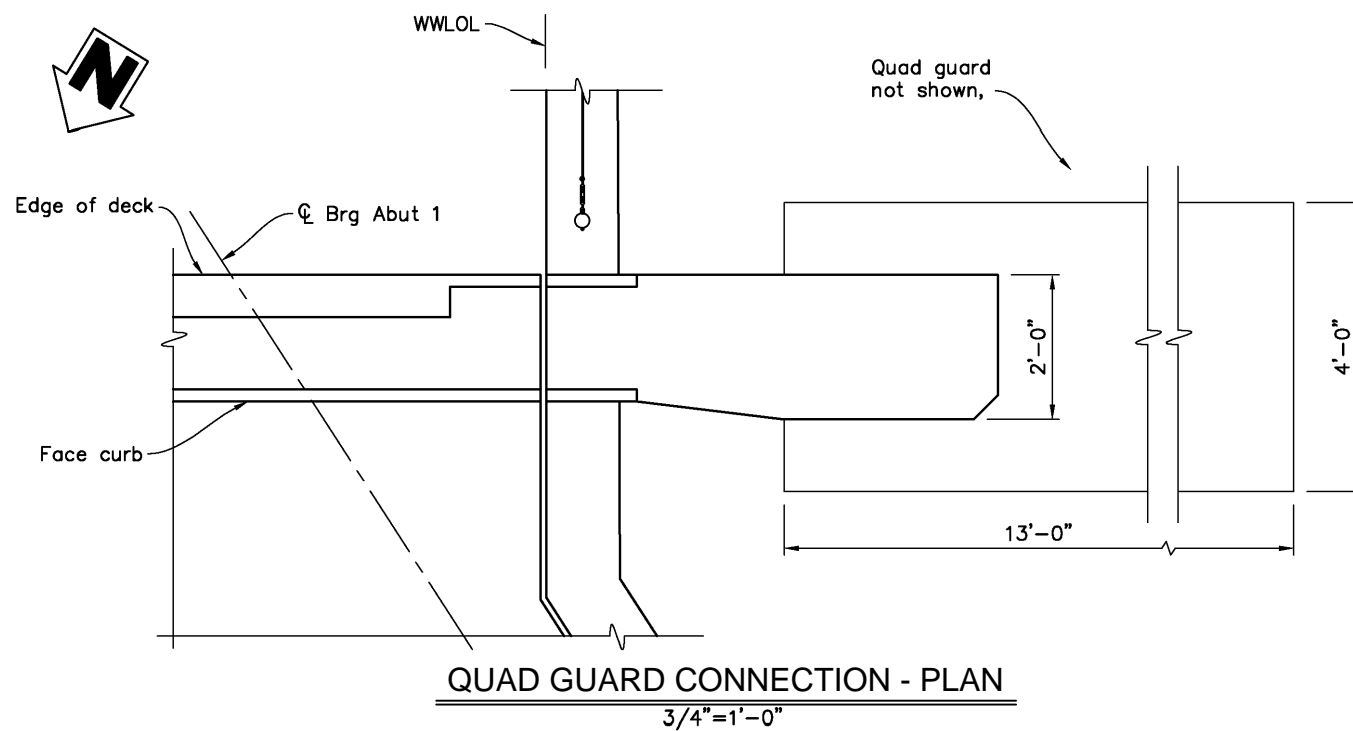

**QUAD GUARD CONNECTION - PLAN**  
3/4"=1'-0"

**Notes:**

1. No splices allowed in the pile longitudinal and spiral reinforcement.
2. No pile boring shall take place adjacent to an open pile bearing. Construct pile and allow pile to set prior to drilling a hole for the adjacent pile.
3. Reinforcement extending into footing shall be hooked as required to provide clearance to top of footing.

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DRAWING BY	P. KENNEY
CHECKED BY	DES CHK

REGISTERED CIVIL ENGINEER  
1/31/2018

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CONSTRUCTION COMPLETED:	
DATE	BY

"AS BUILT" INFORMATION TO BE COMPLETED AFTER CONSTRUCTION



RESIDENT ENGINEER AS BUILT DRAWINGS BY:

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**QUINCY ENGINEERING, INC.**  
11017 Cobblecreek Drive, Suite 100  
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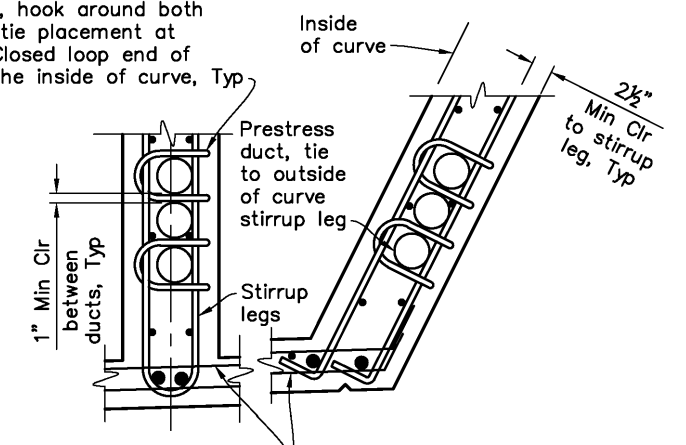
**COUNTY OF SONOMA**  
DEPARTMENT OF TRANSPORTATION & PUBLIC WORKS  
SUSAN KLASSEN, DIRECTOR

ABUTMENT DETAILS NO. 3		ROAD NUMBER	XXX
FREESTONE FLAT ROAD BRIDGE REPLACEMENT		BUDGET NUMBER	XXX
		FISCAL YEAR	2015-16
		SHEET NUMBER	26
		TOTAL SHEETS	32



GIRDER ELEVATION
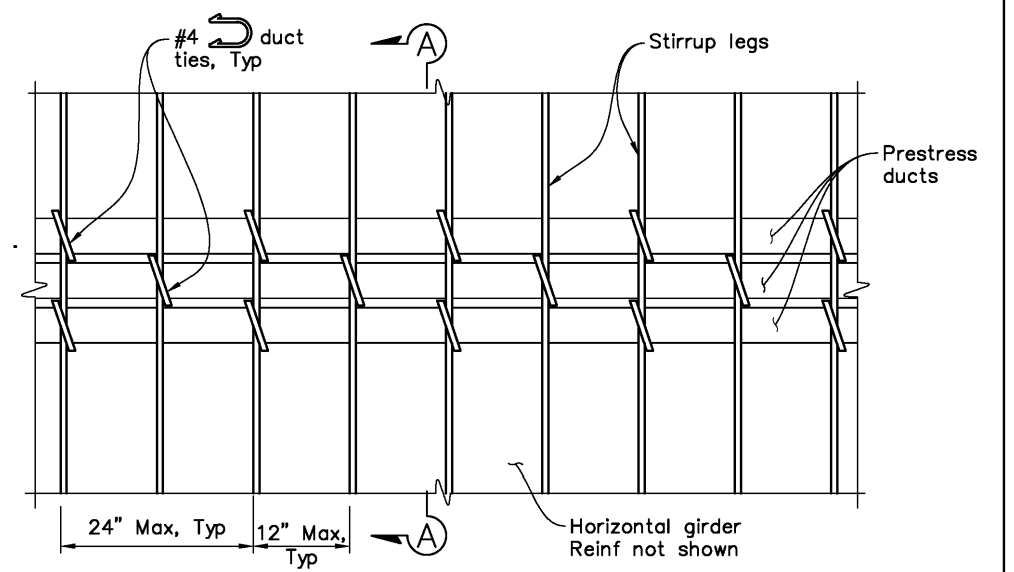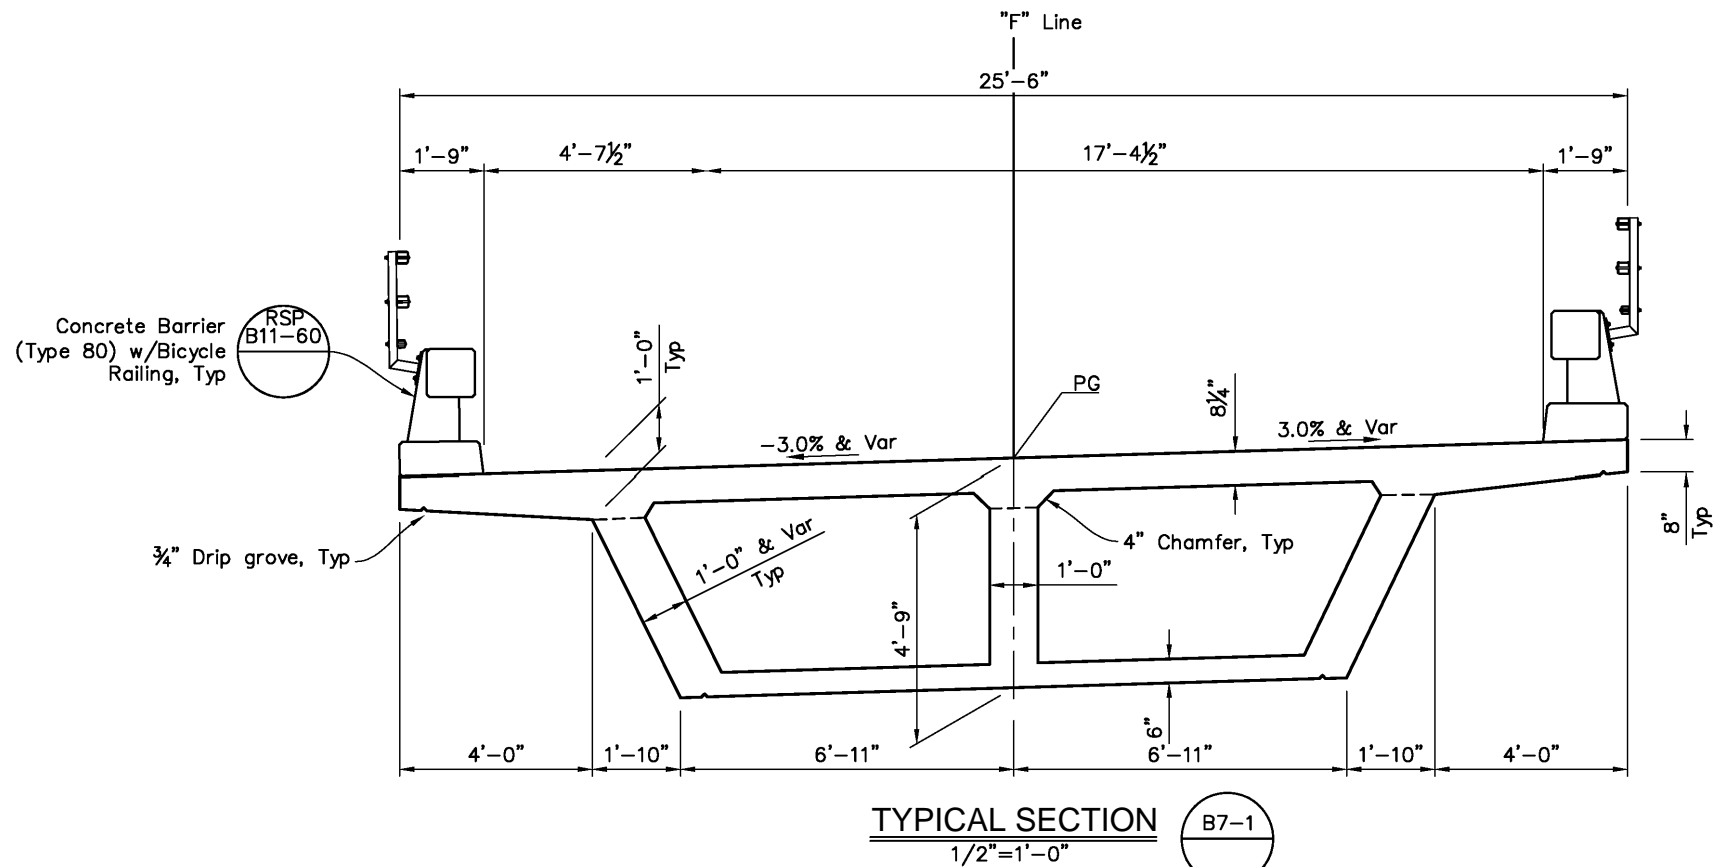
#4 duct ties @ 24 Max, hook around both stirrup legs. alternate duct tie placement at adjacent ducts @ 12 Max. Closed loop end of duct ties to be placed on the inside of curve, Typ




SECTION A-A  
DETAIL A  
No Scale

Notes:

1. Place transverse top and bottom slab reinforcement perpendicular to and spaced along "F" Line.
2. No "Lap Splices" allowed. Service splices only.
3. Where ducts change horizontal direction, such as at girder flares, Standard Detail B8-5 supercedes "Detail A".
4. "Detail A" reinforcement for the anticipated duct size. Girder stem width may need to be increased beyond the typical 12" width.

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- \* Distribution reinforcement
- o Additional bottom slab reinforcement, see "Girder Reinforcement No. 1" sheet

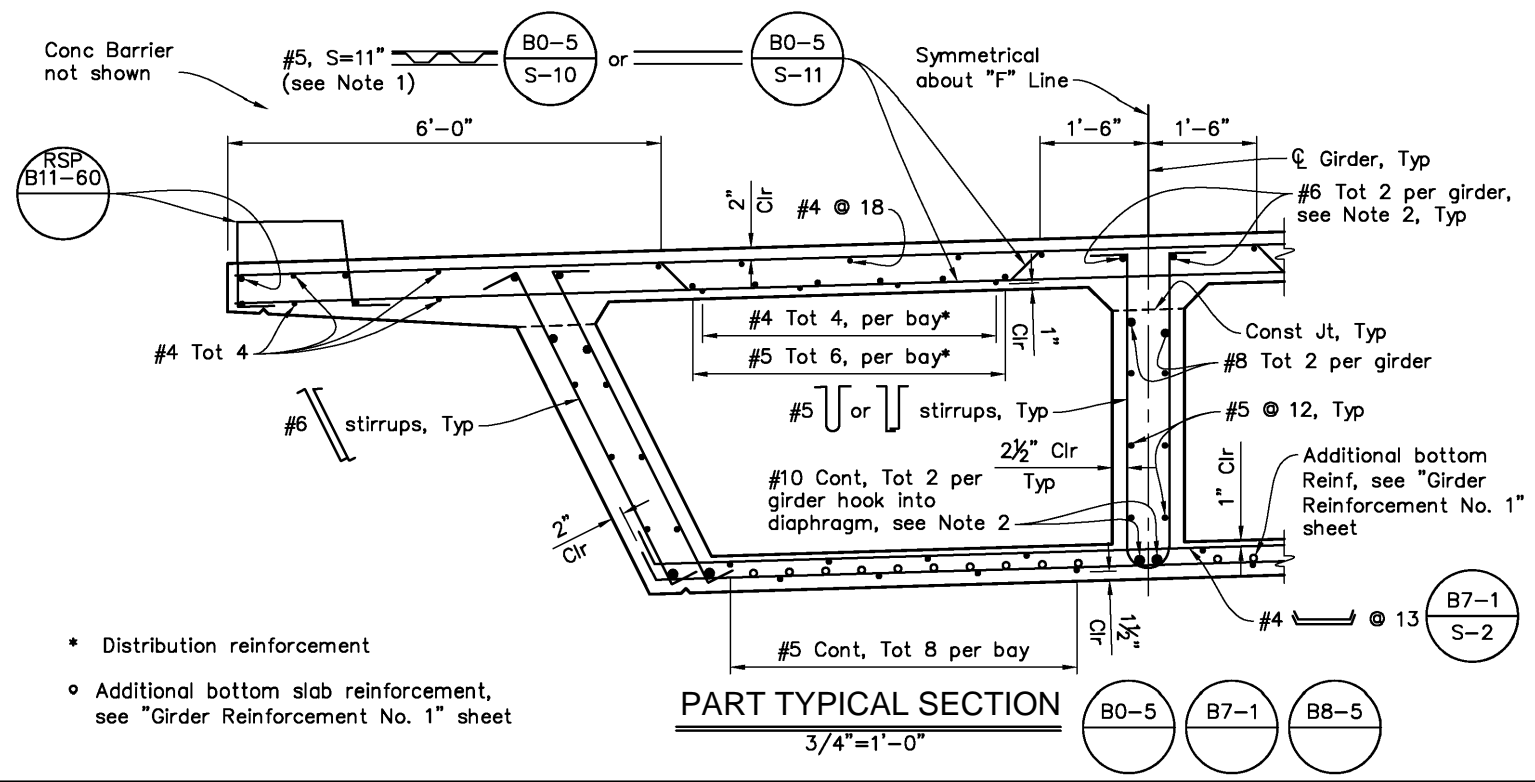PART TYPICAL SECTION B7-1  
3/4" = 1'-0"

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DRAWING BY	P. KENNEY
CHECKED BY	DES CHK

REGISTERED CIVIL ENGINEER  
1/31/2018

PLANS APPROVAL DATE  
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S22-200\CAD\BRIDGE\S22200A-K-TS01.DWG 1/30/2018  
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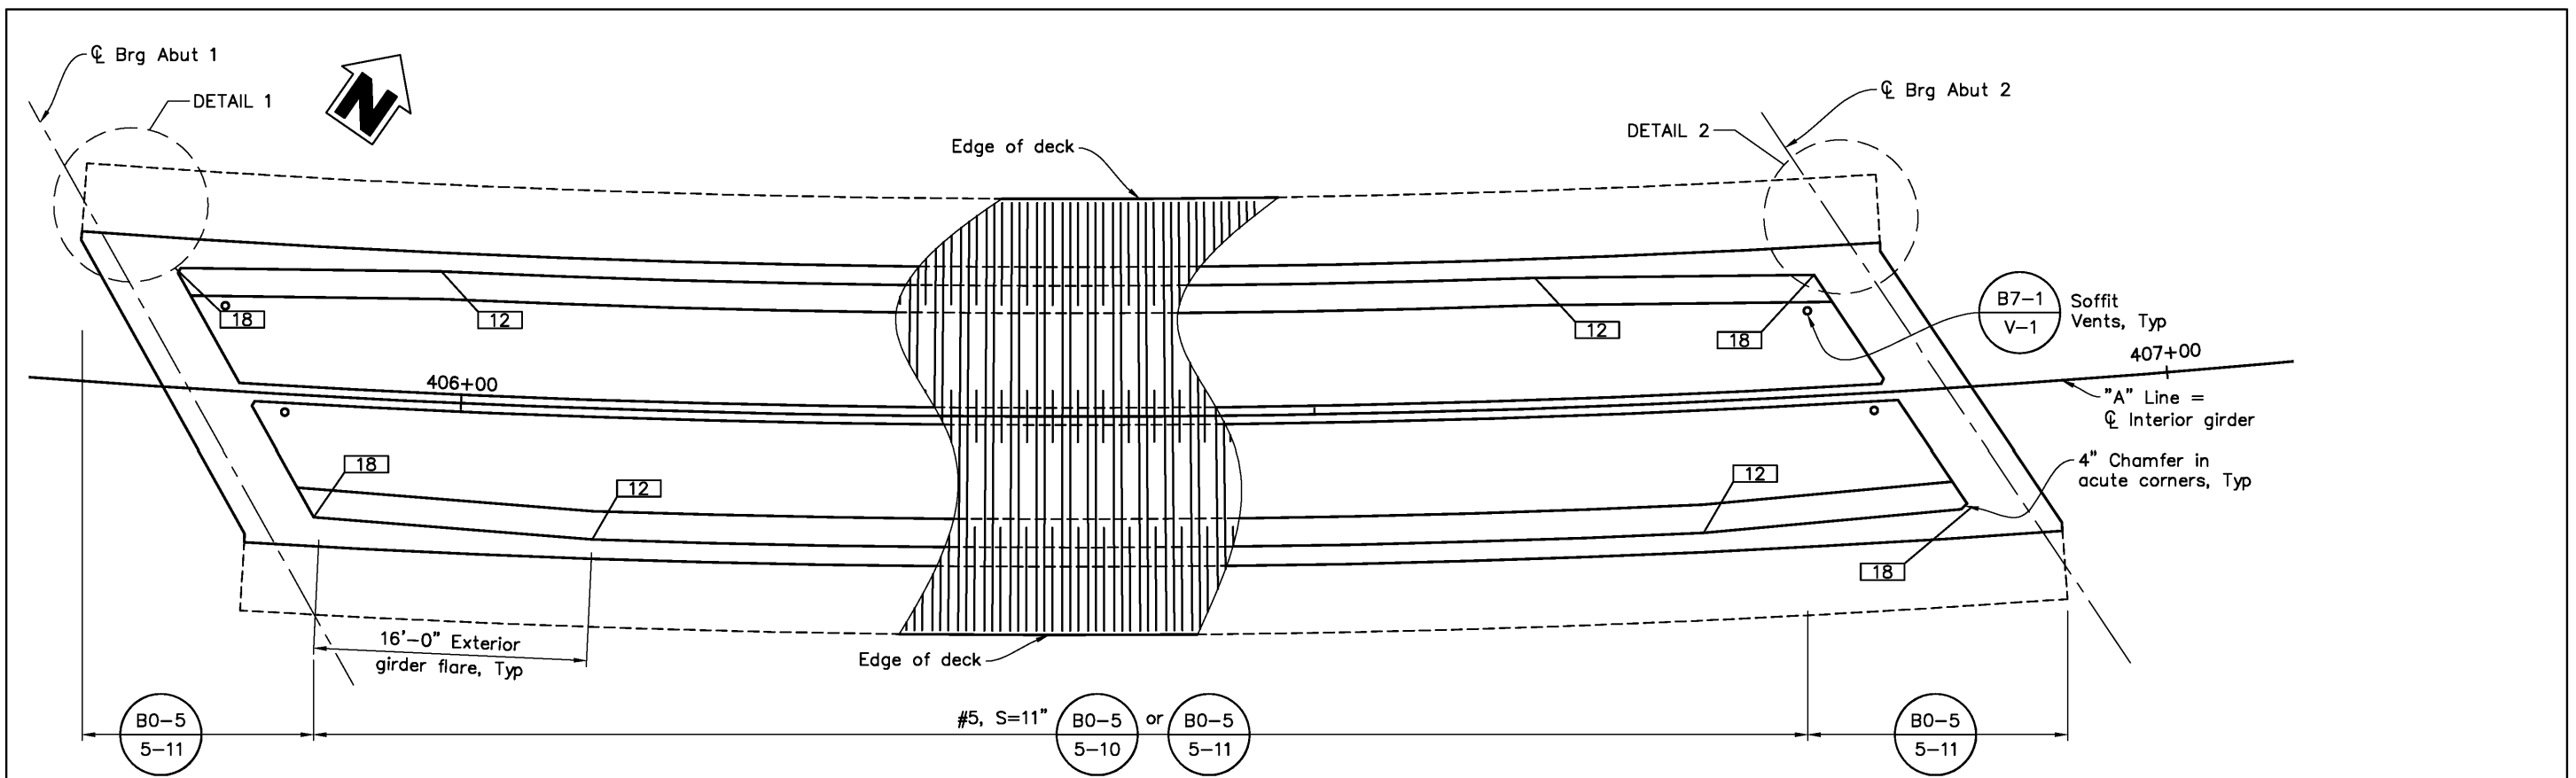
CONSTRUCTION COMPLETED:	
DATE	BY

RESIDENT ENGINEER AS BUILT DRAWINGS BY:

QUINCY ENGINEERING, INC.  
11017 Cobblerock Drive, Suite 100  
Sacramento, CA 95670

COUNTY OF SONOMA  
DEPARTMENT OF TRANSPORTATION & PUBLIC WORKS  
SUSAN KLASSEN, DIRECTOR

TYPICAL SECTION	ROAD NUMBER	XXX
FREESTONE FLAT ROAD BRIDGE REPLACEMENT	BUDGET NUMBER	XXX
	FISCAL YEAR	2015-16
	SHEET NUMBER	27
	TOTAL SHEETS	32



**PLAN**  
1"=5'

- LEGEND:**  
 Indicates girder stem width in inches
- Notes:**
- For additional top and bottom slab reinforcement, see "Typical Section" sheet.
  - For Detail 1 and Detail 2, see "Girder Reinforcement No. 2" sheet.

**PRESTRESSING NOTES**

270 KSI Low Relaxation Strand:

$P_{jack} = 6,300$  kips

Anchor set =  $\frac{3}{8}$  in

Total Number of Girders = 2

Distribution of prestress force ( $P_{jack}$ ) between girders shall not exceed the ratio of 10:9.  
 Maximum final force variation between girders shall not exceed 725 kips.

Concrete:  $f'_c = 4000$  psi @ 28 days


$f'_{ci} = 3500$  psi @ time of stressing

Contractor shall submit elongation calculations based on initial stress at


$\boxtimes = 0.953$  times jacking stress.

$\mu = 0.0002$  K = 1.15

One end stressing shall be performed from Abutment 1 end.

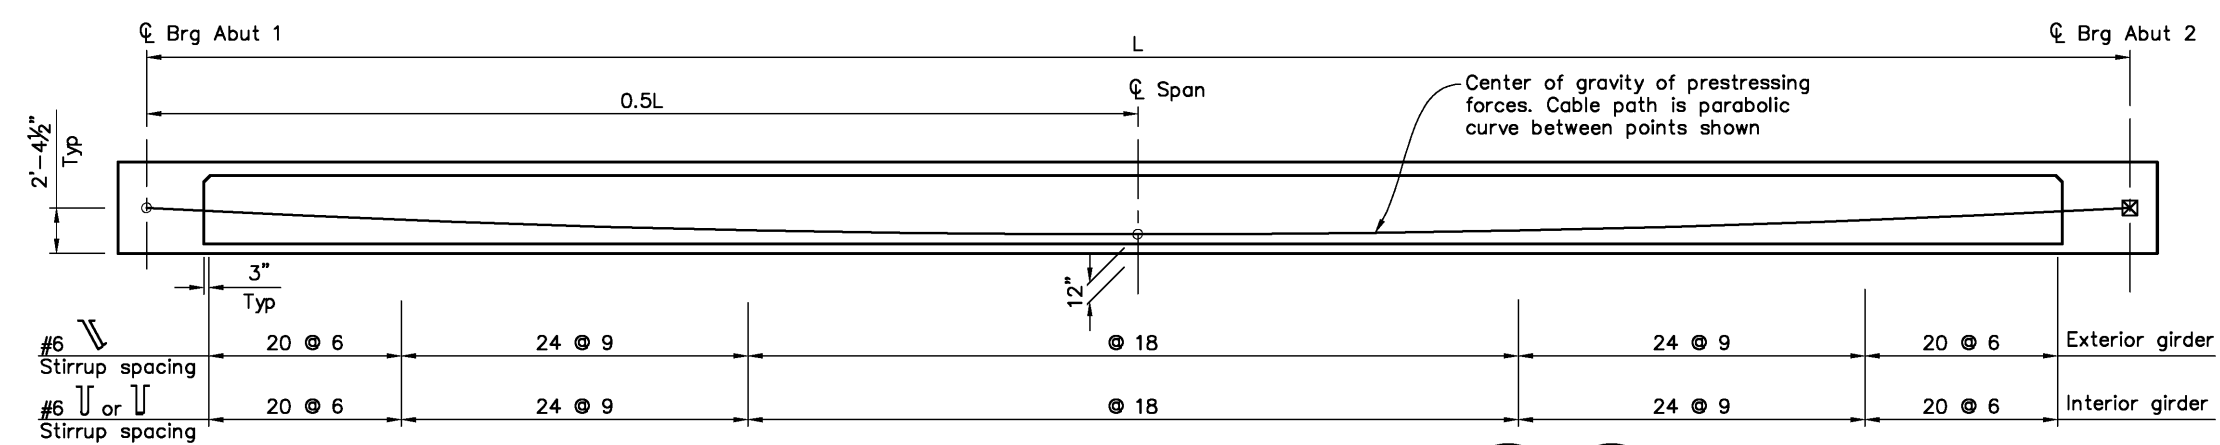

**LONGITUDINAL SECTION**  
1"=5'

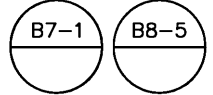



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DESIGN BY	S. SALVADOR		CONSTRUCTION COMPLETED:		QUINCY ENGINEERING, INC. 11017 Cobblerock Drive, Suite 100 Sacramento, CA 95670		COUNTY OF SONOMA DEPARTMENT OF TRANSPORTATION & PUBLIC WORKS SUSAN KLASSEN, DIRECTOR	GIRDER LAYOUT		ROAD NUMBER	XXX
DRAWING BY	P. KENNEY		REGISTERED CIVIL ENGINEER					RESIDENT ENGINEER	BUDGET NUMBER	XXX	
CHECKED BY	DES CHK		1/31/2018					AS BUILT DRAWINGS BY:	FISCAL YEAR	2015-16	
PLANS APPROVAL DATE: 1/31/2018 CLIENT: SONOMA COUNTY - S22\FREESTONE FLAT ROAD S22-200\CAD\BRIDGE\S22200A-L-G_L001.DWG 1/30/2018 2:38 PM								SHEET NUMBER	28		
								TOTAL SHEETS	32		




Notes:

1. No "Lap" splices allowed. "Service" splices only.
2. Diaphragm stirrup hooks shall run along same plane as girder reinforcing.
3. Top transverse deck reinforcement not shown, see "Girder Layout" sheet.

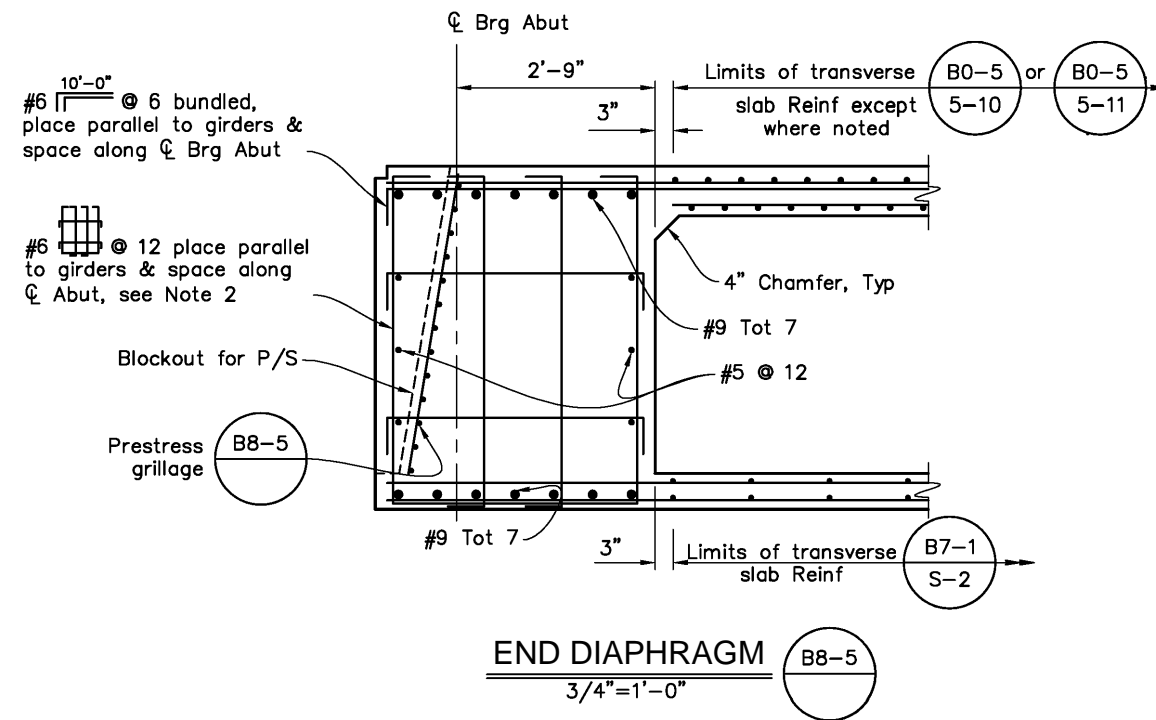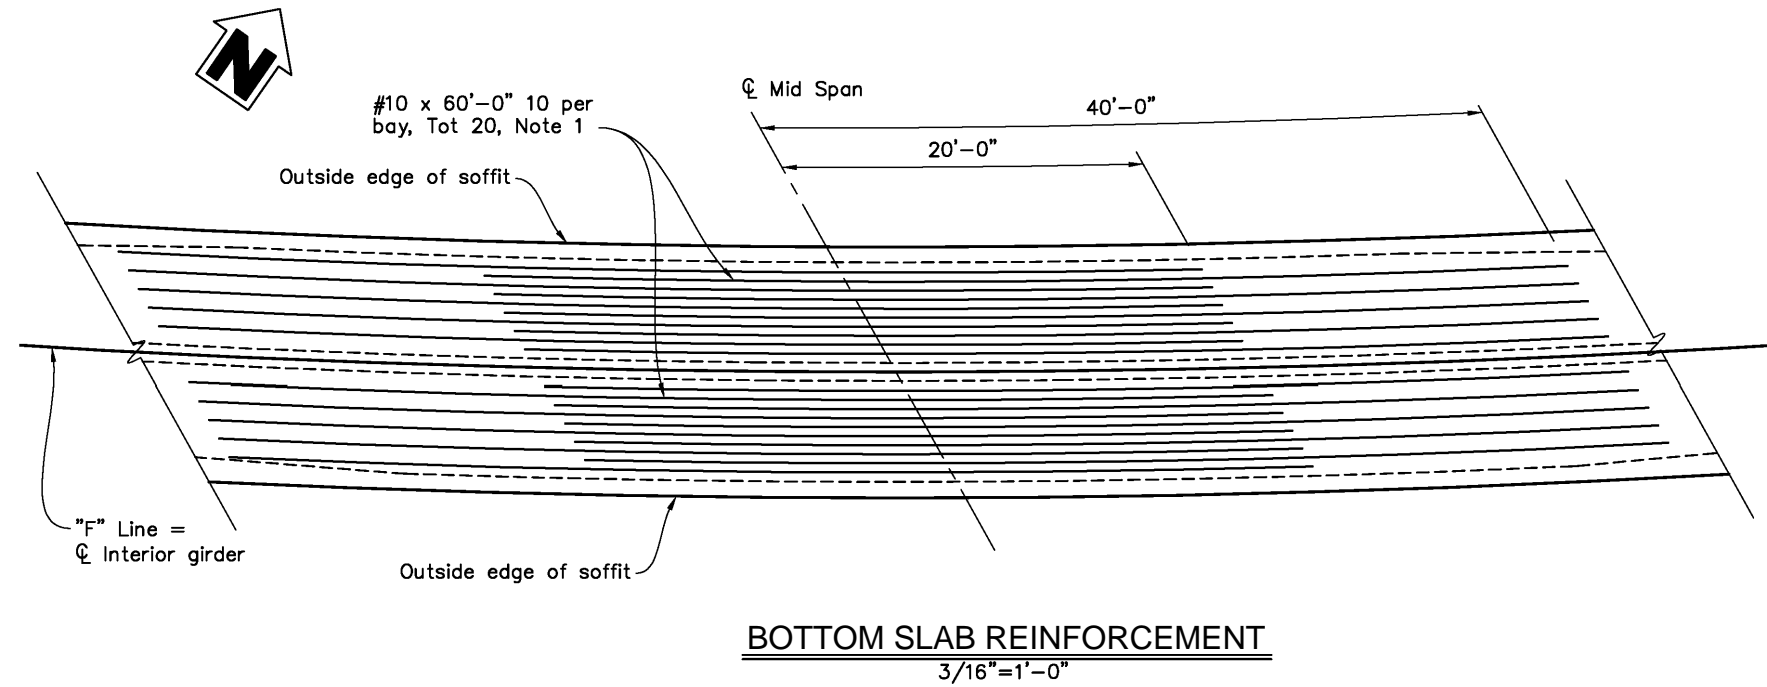


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DESIGN BY	S. SALVADOR		CONSTRUCTION COMPLETED:			<b>COUNTY OF SONOMA</b> DEPARTMENT OF TRANSPORTATION & PUBLIC WORKS SUSAN KLASSEN, DIRECTOR	GIRDER REINFORCEMENT NO. 1	ROAD NUMBER	XXX			
DRAWING BY	P. KENNEY		REGISTERED CIVIL ENGINEER				RESIDENT ENGINEER	BUDGET NUMBER	XXX	FREESTONE FLAT ROAD	FISCAL YEAR	2015-16
CHECKED BY	DES CHK		1/31/2018				AS BUILT DRAWINGS BY:	SHEET NUMBER	29	BRIDGE REPLACEMENT	TOTAL SHEETS	32
PLANS APPROVAL DATE		1/30/2018 2:38 PM	DATE	BY	APPROVED							

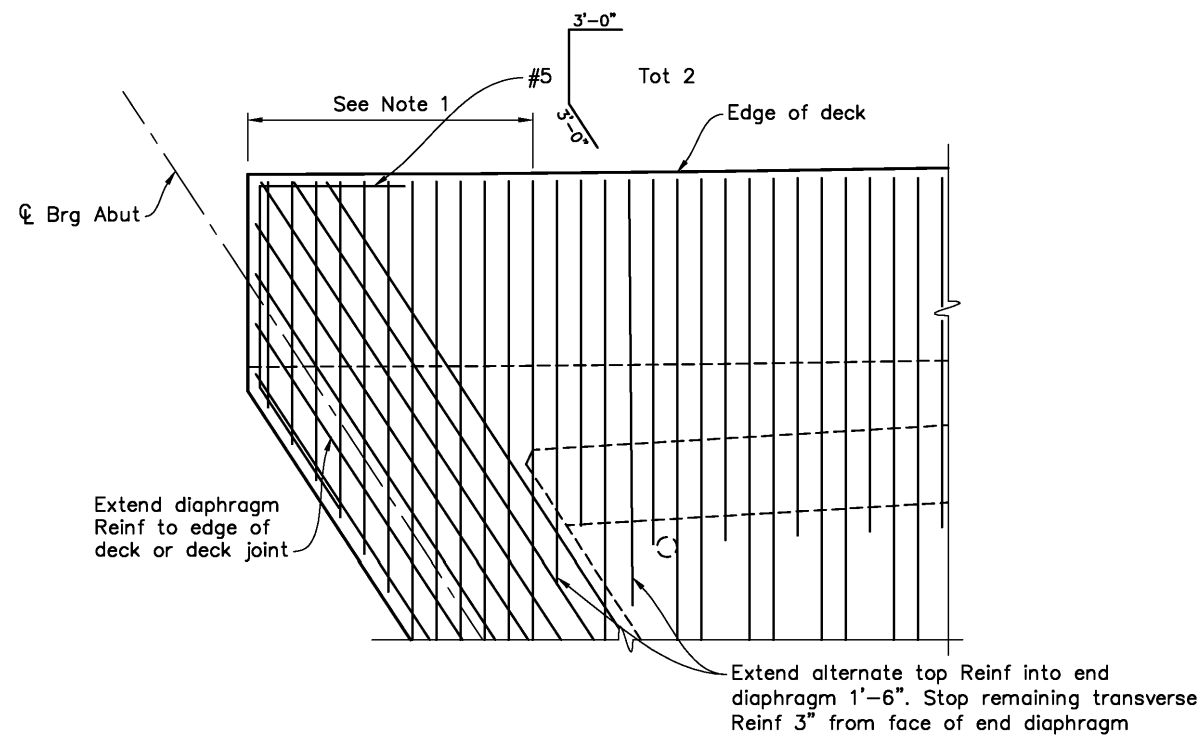

**DETAIL 1**  
1/2"=1'-0"

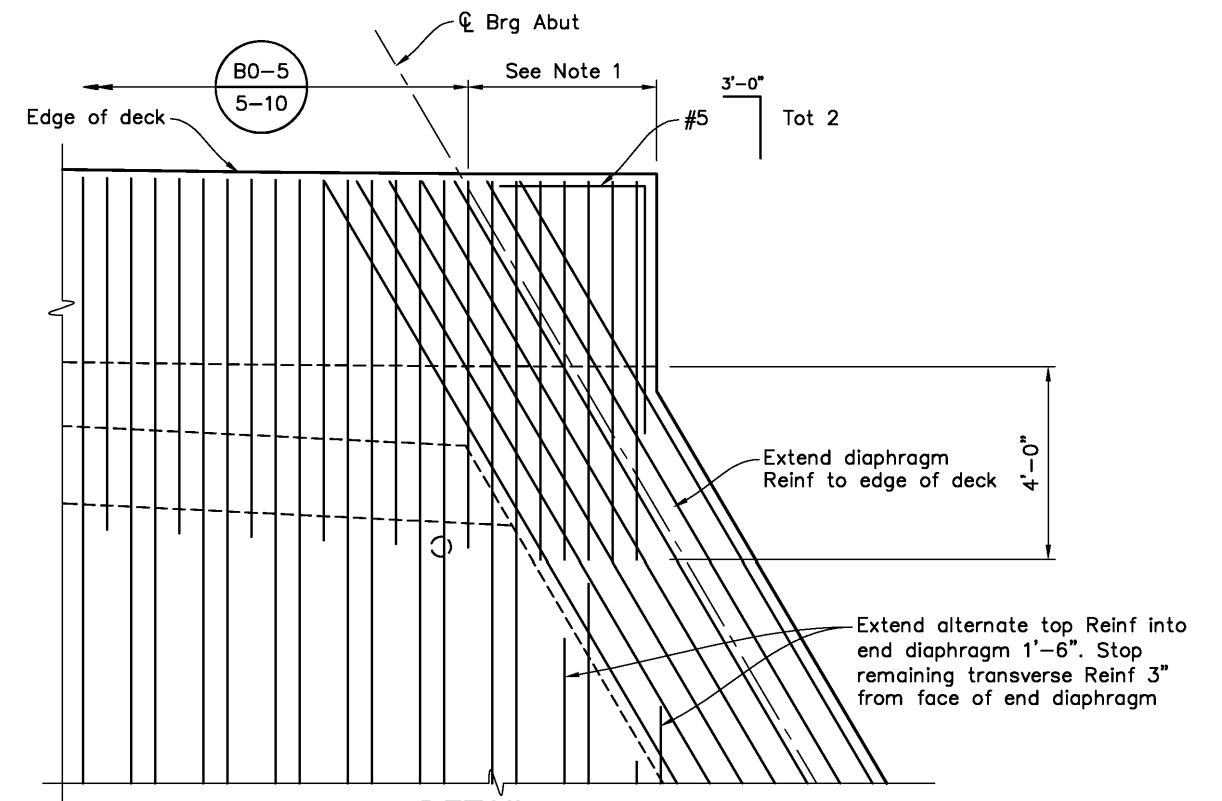


**DETAIL 2**  
1/2"=1'-0"

- Notes:
1. Extend all transverse deck reinforcement through end diaphragm to the edge of deck at deck corners.

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DESIGN BY	S. SALVADOR
DRAWING BY	P. KENNEY
CHECKED BY	DES CHK

REGISTERED CIVIL ENGINEER  
1/31/2018  
PLANS APPROVAL DATE  
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CONSTRUCTION COMPLETED		RESIDENT ENGINEER AS BUILT DRAWINGS BY:	
DATE	BY	DATE	APPROVED

QUINCY ENGINEERING, INC.  
11017 Cobblecreek Drive, Suite 100  
Sacramento, CA 95670

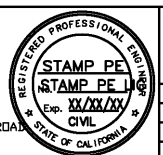**COUNTY OF SONOMA**  
DEPARTMENT OF TRANSPORTATION & PUBLIC WORKS  
SUSAN KLASSEN, DIRECTOR


GIRDER REINFORCEMENT NO. 2  
**FREESTONE FLAT ROAD  
BRIDGE REPLACEMENT**

ROAD NUMBER	XXX
BUDGET NUMBER	XXX
FISCAL YEAR	2015-16
SHEET NUMBER	30
TOTAL SHEETS	32


Dist	COUNTY	ROUTE	POST MILES TOTAL PROJECT	SHEET No.	TOTAL SHEETS
DIS	Son	RTE	XXX XXXXX	31	32

**65% SUBMITTAL**  
REGISTERED CIVIL ENGINEER DATE \_\_\_\_\_  
PLANS APPROVAL DATE \_\_\_\_\_


*The State of California or its officers or agents shall not be responsible for the accuracy or completeness of scanned copies of this plan sheet.*  
*The Registered Civil Engineer for the project is responsible for the selection and proper application of the component design and any modifications shown.*

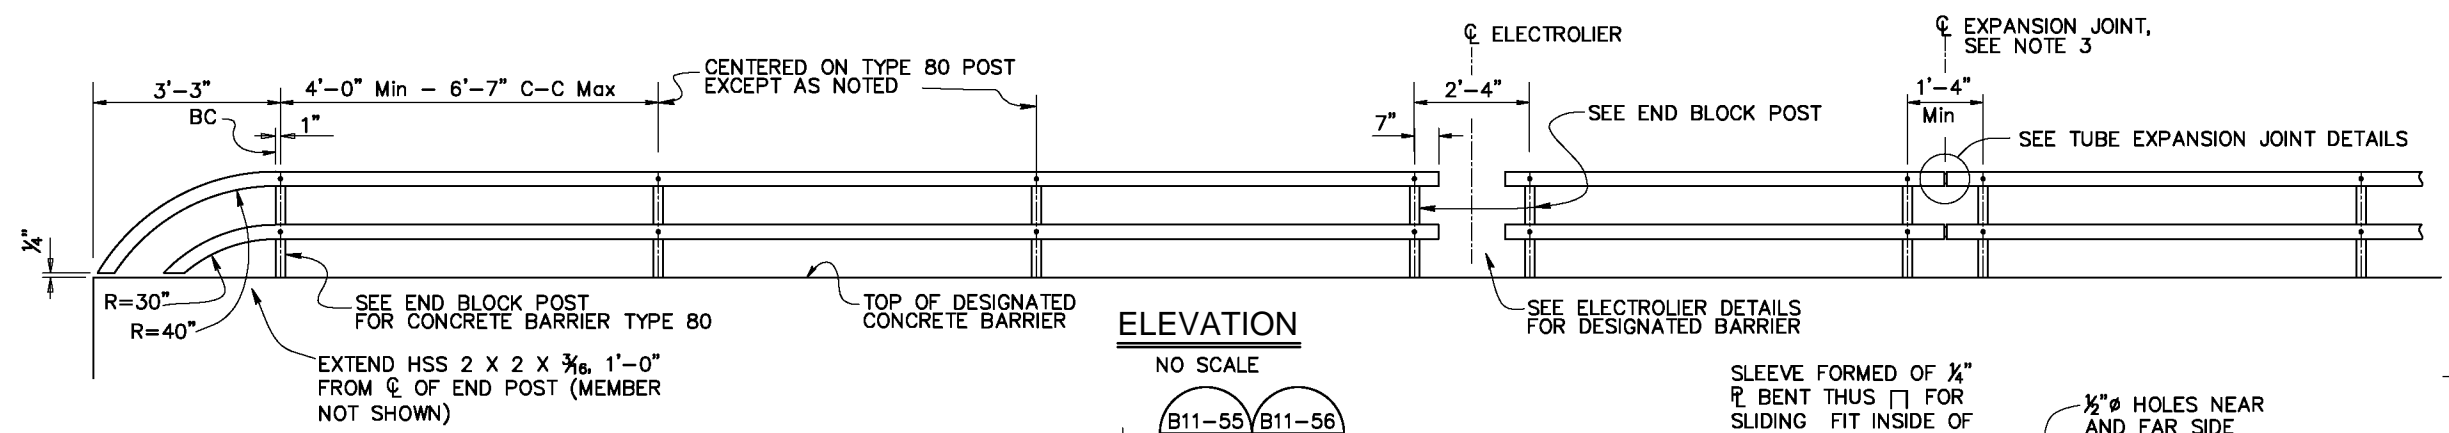


**ELEVATION**  
NO SCALE

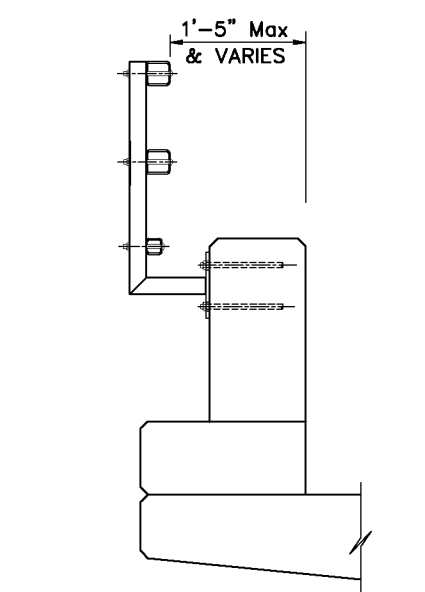


**TYPE 80 END BLOCK POST**  
1" = 1'-0"

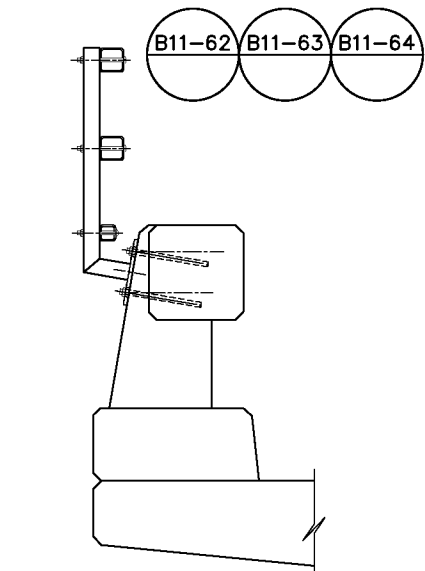


**TYPE 80**  
1" = 1'-0"

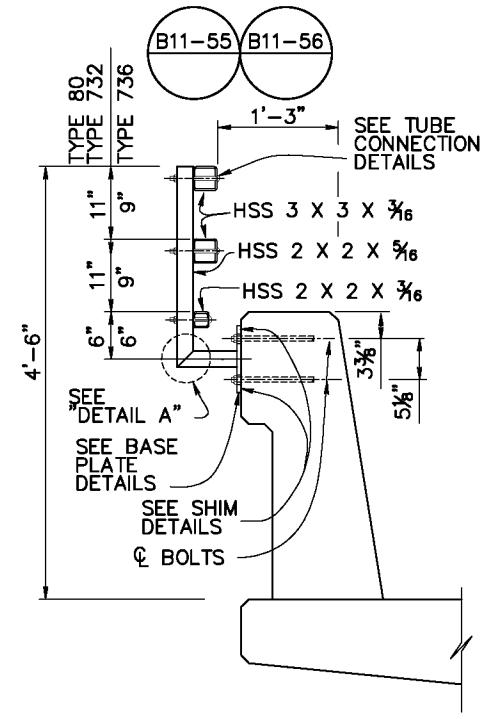


**TYPE 732 OR 736**  
1" = 1'-0"

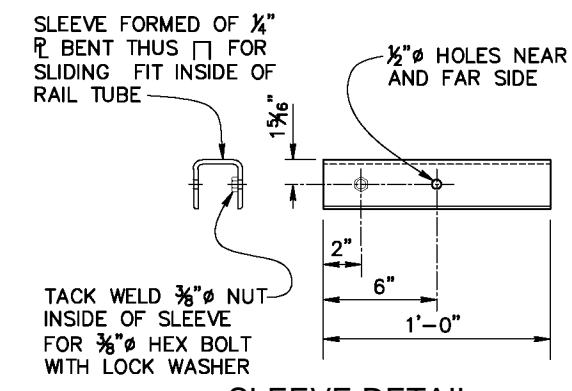


**SLEEVE DETAIL**  
NO SCALE

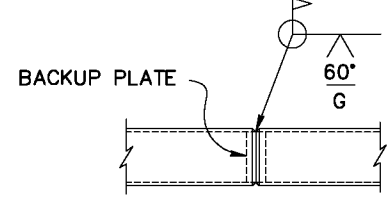

**WELDED SPLICE DETAIL**  
NO SCALE

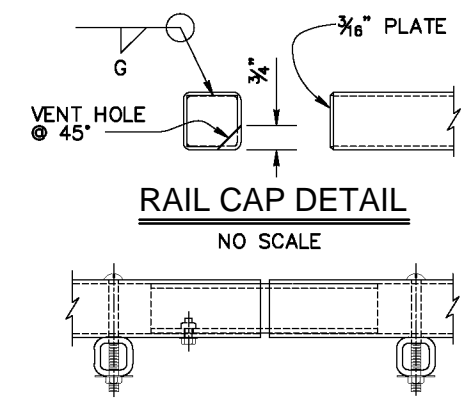


**RAIL CAP DETAIL**  
NO SCALE

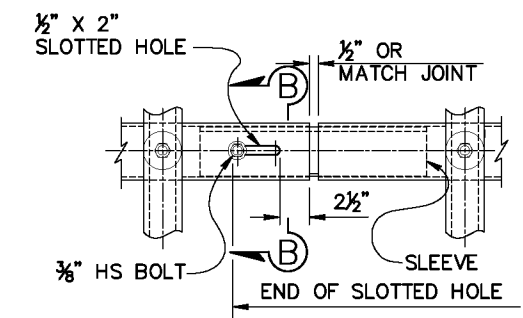


**TUBE EXPANSION JOINT DETAILS**  
NO SCALE


**SECTION B-B**  
NO SCALE

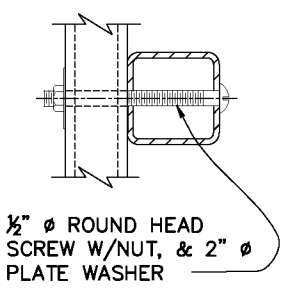


**TUBE CONNECTION DETAIL**  
NO SCALE

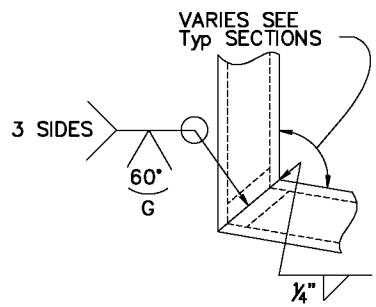

**DETAIL A**  
NO SCALE

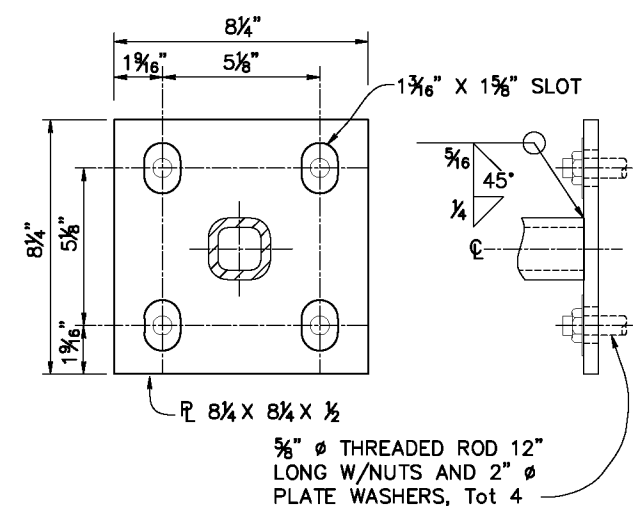

**BASE PLATE DETAIL**  
NO SCALE

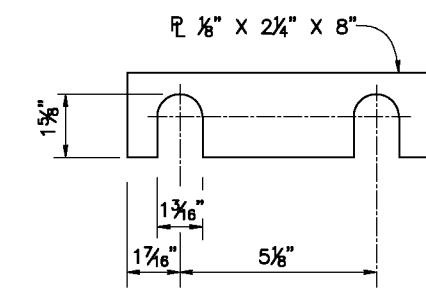

**SHIM DETAILS**  
NO SCALE

- NOTES:
1. Post must be normal to railing.
  2. Rail tubes must be shop bent or fabricated to fit horizontal curve when radius is less than 950'.
  3. Tube expansion joints must be located in the tubes spanning deck or wall joints. Increase joint width in tubes to match expansion joint width and increase sleeve length correspondingly.
  4. Top rail tube must be continuous over not less than two posts except a short post spacing is permitted near deck or wall joints, electroliers, or other rail discontinuities as noted.
  5. See Project Plans for limits of tubular bicycle railing.

<b>BRIDGE STANDARD DETAILS</b>			<b>STATE OF CALIFORNIA</b>			<b>DIVISION OF ENGINEERING SERVICES</b>			<b>FREESTONE FLAT ROAD</b>		
xs16-035	October 2014	The components of the Bridge Standard Details have been prepared under the responsible charge of the Technical Owner, a Registered Civil Engineer in the State of California.	DEPARTMENT OF TRANSPORTATION & PUBLIC WORKS			BRIDGE NO. 00C000			TUBULAR BICYCLE RAILING DETAILS		
FILE NO.	APPROVAL DATE		PROJECT NUMBER & PHASE: PROJECT NUMBER			POST MILE PM			SHEET 31 OF 15		

Refer to: <http://www.dot.ca.gov/hq/esc/techpubs/manual/bridgemanuals/bridge-standard-detail-sheets/index.html>  
FILE S:\Client\Sonoma County - S22\Freestone Flat Road S22-200\CAD\Bridges\222200\BRIDGE\DETAILS\BRIDGE PLANS  
USERNAME Patrickk TIME PLOTTED 2:38:51 PM DATE PLOTTED 1/30/2018 2:38:51 PM


DIST.	COUNTY	ROUTE	POST MILES TOTAL PROJECT	SHEET NO.	TOTAL SHEETS
04	SON	C.R.			

REGISTERED GEOTECHNICAL ENGINEER  
 PLANS APPROVAL DATE  
 Crawford and Associates, Inc.  
 1100 Corporate Way  
 Sacramento, CA 95831  
 (916) 455-4225  
 JOB No. 2012-0115 LOCATION: 40122-C3-406N-246W




Quincy Engineering, Inc.  
 11017 Cobblecreek Drive, Suite 100  
 Rancho Cordova, CA 95670  
 (916) 358-9181

- Notes: English
- Field classification of soils was in accordance with ASTM D 2488-09a "Description and Identification of Soils (Visual-Manual Procedure)".
  - Standard Penetration tests (SPTs) were performed in accordance with ASTM D 1586-11 using hammer operated with an automated drop system. Drill rods were 1 5/8-inch diameter "A"-rods; sampler was driven with brass and steel liners. Hammer energy transfer ratio (ETR) measurements indicate an ETR = 64.5% as of 01/03/2013.
  - The length of each sampled interval is shown graphically on the boring log. Whole number blow counts ("N") represent the "standard penetration resistance" interval in accordance with ASTM D1586-11. Where less than 1 foot of penetration is achieved, the blow count shown is for that fraction of the "standard penetration resistance" interval actually penetrated. Where indicated by an asterisk (\*) the number of blows shown is for only that fraction of the initial 0.5 ft "sealing drive" interval penetration. Material characteristics shown in ( ) where estimated.
  - Rock classification according to Bureau of Reclamation, U.S. Department of the Interior (USBR), "Engineering Geology Field Manual"; and "Manual of Field Geology"; (Compton, Robert R.). Rock Quality Designation (RQD), Weathering, Rock Hardness/Strength, Bedding, and Fracture Density, as shown on this sheet, were used to describe all rock core from boring B-2, B-3 and B-4. Descriptors were determined in the field. REC = Core Recovered (percent). RQD = Rock Quality Designation (percent).
  - Groundwater surface elevations in the borings indicated on the "Log of Test Boring" sheet reflect the fluid level in the borings on the specified date. Groundwater surface elevations are subject to seasonal fluctuations and may occur at higher or lower elevations depending on the conditions at any particular time.
  - Boring elevations were surveyed by Quincy Engineering, Inc. in the field subsequent to Taber Consultants field exploration.
  - Electronic media for plan view provided by Quincy Engineering, Inc.
  - The Ground line profile is estimated from topography provided by Quincy Engineering, Inc.

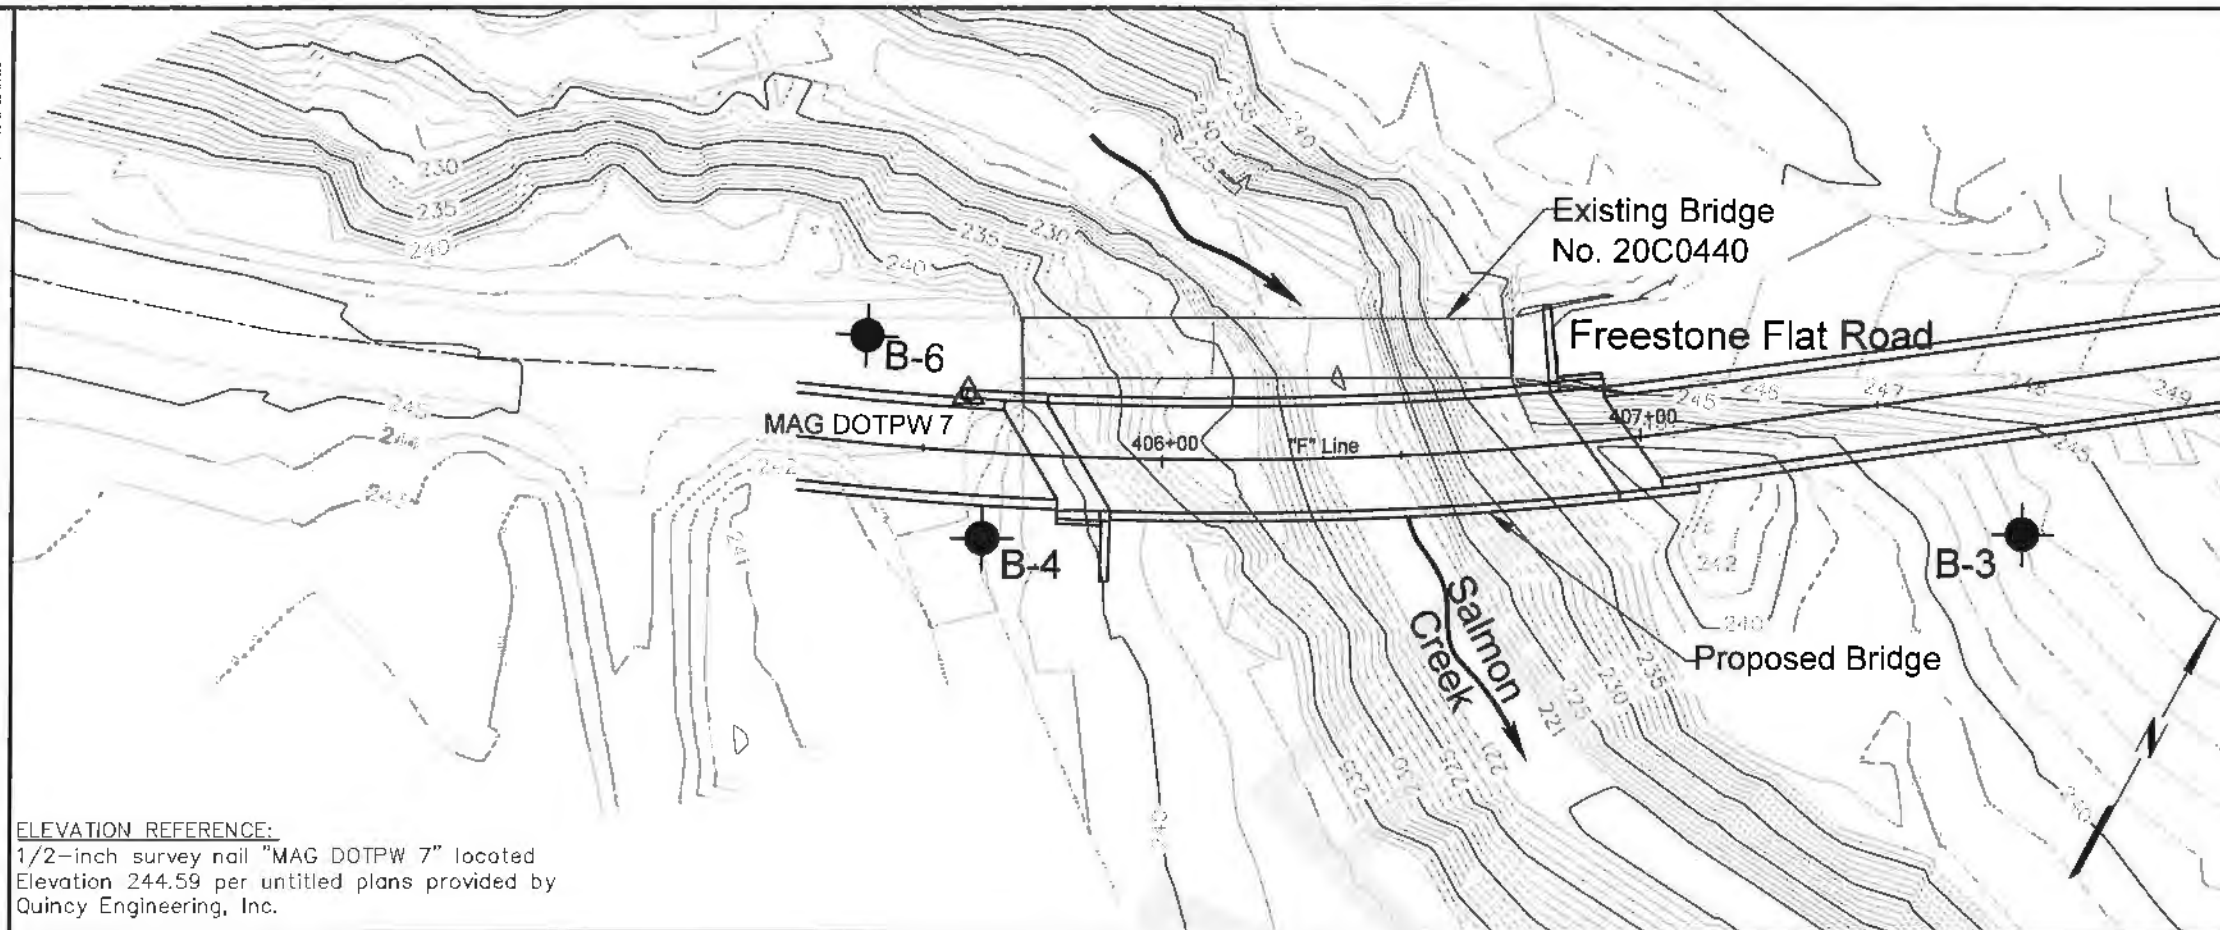


ELEVATION REFERENCE:  
 1/2-inch survey nail "MAG DOTPW 7" located  
 Elevation 244.59 per untitled plans provided by  
 Quincy Engineering, Inc.

PLAN  
 1"=20'

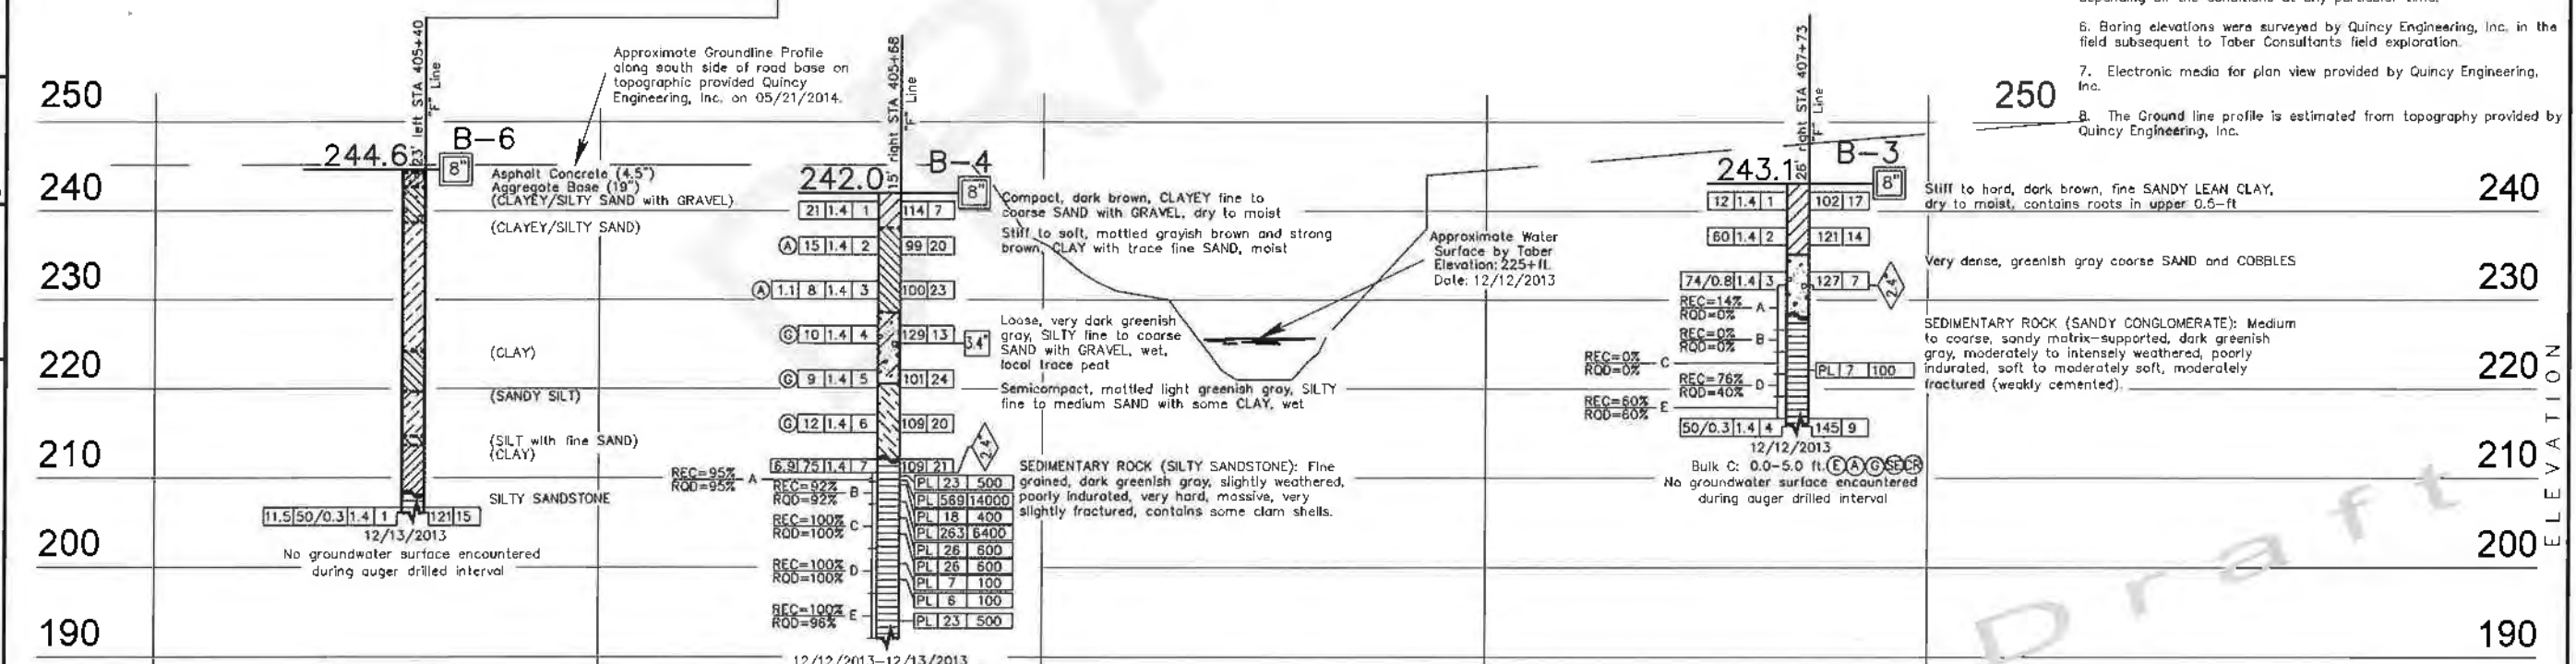

PROFILE  
 HOR. 1"=20'  
 VERT. 1"=10'

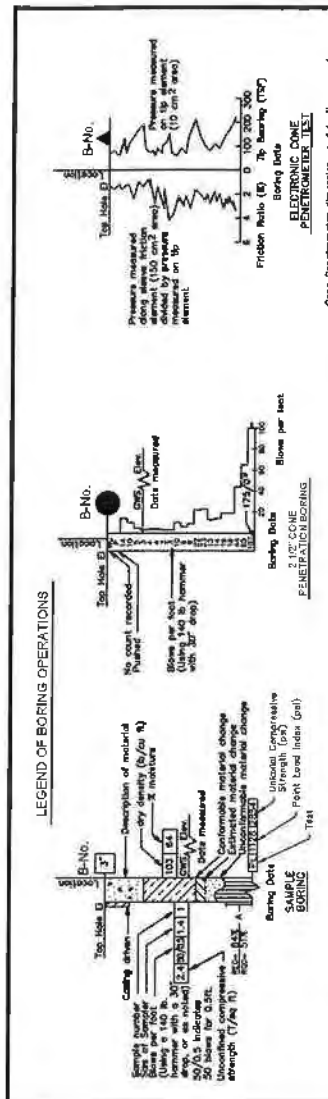

LEGEND OF EARTH MATERIALS

GRAVEL	CLAY
SAND	SILT
SANDY SILT	SANDY CLAY
SILT CLAY	CLAYEY SAND
CLAYEY SILT	SILT CLAY
CLAYEY CLAY	CLAYEY SILT
SANDY CLAY	SANDY SILT
SANDY SILT	SANDY CLAY
SILT SAND	SILT CLAY
SILT CLAY	SILT SAND
SANDY SILT	SANDY CLAY
SANDY CLAY	SANDY SILT
SILT SAND	SILT CLAY
SILT CLAY	SILT SAND

LEGEND OF BORING OPERATIONS

Asphalt Concrete (4.5")	Aggregate Base (19")
CLAYEY/SILTY SAND with GRAVEL	CLAYEY/SILTY SAND
Compact, dark brown, CLAYEY fine to coarse SAND with GRAVEL, dry to moist	Stiff to soft, mottled grayish brown and strong brown, CLAY with trace fine SAND, moist
(CLAY)	Loose, very dark greenish gray, SILTY fine to coarse SAND with GRAVEL, wet, local trace peat
(SANDY SILT)	Semicompact, mottled light greenish gray, SILTY fine to medium SAND with some CLAY, wet
(SILT with fine SAND)	(CLAY)
SILT SANDSTONE	SEDIMENTARY ROCK (SILTY SANDSTONE): Fine grained, dark greenish gray, slightly weathered, poorly indurated, very hard, massive, very slightly fractured, contains some clam shells.

DESIGN OVERSIGHT	DRAWN BY X. Van	Bret D. McIntyre FIELD INVESTIGATOR	PREPARED FOR SONOMA COUNTY DEPARTMENT OF PUBLIC WORKS	BRIDGE NO. Freestone Flat Road Bridge over Salmon Creek
SIGN OFF DATE	CHECKED BY A. Kahn/S. Leyva	DATE October 2017	PROJECT ENGINEER	POST MILE
				LOG OF TEST BORINGS