

County of Sonoma Permit & Resource Management Department

To: Interested Agencies July 27, 2023

The following application has been filed with the Sonoma County Permit and Resource Management Department.

File Number: PLP16-0046 Applicant Name: Guy Byrne

Owner Name: Fremont Ranch LLC; Poggetto Newton Dal

Site Address: 4310 Fremont Dr., Sonoma

APN: 126-111-022

Zoning: LIA B6 60 Z, LG/MTN RC50/50 SR VOH

Project Description: Resubmittal of a Use Permit and Design Review application for a new winery proposal consisting of a 35,679-square-foot process facility with an annual production capacity of 30,000 cases, a public tasting room, wine cave storage, 28 promotional events per year, and 20 acres of permitted vineyard development under ACO17-0161, located on a 58.68-acre site zoned LIA 60 (Land Intensive Agriculture) with a 60-acre density at the intersection of Highway 121 and Napa Road (Stonetta Creamery site) at 4310 Fremont Drive, APNs 126-111-022, 126-111-015; Supervisorial District 1.

We are submitting the above application for your review and recommendation. Additional information is on file in this office.

Responses to referrals should include a combination of any or all of the following details:

- (1) Statement of any environmental concerns or uncertainties your agency may have with the project.
- (2) Comments you wish to make regarding the merits of the project.
- (3) Identification of any missing information or application submittals that will preclude you from providing conditions and mitigations for this project in the future.
- (4) Your proposed conditions of approval and/or mitigations for this project.

After reviewing this application, please respond to the planner with your marked response below:

[] Conditions will be provided and no further information is necessary.
[] Conditions will be provided and additional information is necessary.
[] Comments and/or concerns.
[] No comments or conditions.

Responsible agencies under CEQA are requested to indicate whether permits will be required for this project.

Your comments will be appreciated by August 10, 2023, and should be sent to the attention of:







PLP16-0046, Derik Michaelson (<u>derik.michealson@sonoma-county.org</u>). The project planner can also be reached at (707) 565-3095. **If no response is received by August 10, 2023, it will be assumed that no comments or conditions will be provided.**

Please send a copy of your comments to the applicant(s) or their representatives as indicated on the attached Planning Application.

[X] Fire F	revention
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[X] Health Specialist

 $[{\sf X}]\,{\sf Grading}\,{\sf and}\,{\sf Storm}\,{\sf Water}$

[X] Management Group

[X] Natural Resources

[X] Survey and Land Development

[X] SUSMP

[X] Well & Septic

[X] Ag Commissioner

[X] Dist. 1 Director and Commissioners

[X] Economic Development Board

[X] Environmental Health

[X] Regional Parks Dept

[X] SPI (DTPW), Land Development

[X] Trans Authority/RCPA

[X] Transit/BPAC

[X] SVCAC

[X] Valley of the Moon Alliance and Kenwood Press

[X] NW Information Center, S.S.U.

[X] Sonoma/Taylor Mtn. Preservation Group

[X] Schell-Vista FPD

[X] Sonoma Valley School District

[X] Sonoma City Water Division

[X] Recology Sonoma Marin (Disposal)

[X] Chamber of Commerce, Sonoma Valley

[X] Caltrans - State Dept of Transportation

[X] Groundwater Sustainability Agency – Sonoma

Valley

[X] State Dept of Fish and Wildlife

[X] State Dept of Water Resources Control Board,

Drinking Water

[X] State Parks and Recreation - Duncans Mills Office

[X] Regional Water QCB: SF Bay

[X] Air Pollution Control: Bay Area AQM

[X] Sonoma MOAG

[X] Tribal Notification





Planning Application PJR-001

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Application Type(s):			File # PL P	6-0046	1	
Admin Cert. Compliance	-	Review Admin.	☐ Minor Subdi			Use Permit
Ag. Or Timber Preserve/Contract		Review Full	☐ Voluntary M	-		Variance
☐ Conditional Cert. of Compliance ☐ Cert. of Modification	-	l Plan Amendment Adjustment	reasons .	nterpretation		Zone Change
Coastal Permit	p	ubdivision	☐ Second Unit	t Permit a Plan Amendn	L Sent	Other:
Zoning Permit for:				a Hall / Milonais		
By placing my contact informat submitting it to Sonoma County public information purposes, inc	y PRMD, i u	understand and ontact informat	l authorize PRMD to p tion.	ess, etc.) on oost this app	this applic lication to	cation form and the internet o
APPLICA		PRINT	CLEARLY			
Name Frament Danah I.I.C.		:		OTHER THA	N APPLICA	ANT)
Name Fremont Ranch LLC - C Mailing Address 68 Coombs St.,	***************************************	***************************************	Name Mailing Address			
City Napa	State CA	Zip 94559	City		State	Zip
<u> </u>		ch@LRICO.co		Email	_ Ciate	
Signature	111.40010110	Date 9.20.16	Signature			Date
OTHER PE	RSONS TO		f listed they must sign	application fo	orm)	
Name/Title Dusan Motolik, archi				roe - Always		rina Inc.
Mailing Address 2352 Marinship \		211 × 11.0	Mailing Address 131 Sto			11179 11101
City Sausalito	State CA	Zip 94965	^{City} Santa Rosa		State CA	Zip 95401
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Signature / Mary		Date 9.20.16	Signature			Date 9.20.16
1		PROJECT II	NFORMATION			
Address(es) 126-111-022 & 015	(well site))		City Sonor	na	
		emont D				
Project Description <u>Use permit re</u>	equest to co	<u>onstruct a win</u>	ery with tasting roon	n with a max	kimum pro	oduction of
60,000 cases	per year a	and up to 20 p	promotional events p	er year.		
Acreage 58			Number of new lots proposed	d N/A		
Site Served by Public Water?	Yes X No		Site Served by Public Sewer	Yes	⊠ No	
	ТО	BE COMPLETE	ED BY PRMD STAFF			
Planning Area Si	upervisorial Dist	rict /	Latitude	Long	jitude	
Current Zoning LIA BC GC	DZ L	_G/MTN	RC 50/50 SR	VOH		
General Plan Land Use			Specific/Area Plan			
S.P. Land Use			Violation? Yes	No File	No.	
Application resolve planning violation?	Yes 🔽	No	Penalty application?	Yes 🖪 No		
Previous Files						
Application accepted by G. Hunn	ig fond		Date 9.76	2016		
Approved by			Date			

Fremont Ranch Winery and Tasting Room Proposal Statement

Fremont Ranch, LLC Revised March 13, 2023

Applicant / Owner: Fremont Ranch, LLC

68 Coombs St., Suite D-10 Napa, CA 94559

Attn: Guy Byrne (707) 287-1026 Guy.byrne@Irico.com

Project location: 4310 Fremont

Dr. Sonoma,

APN: CA 95476 126-111-022; 126-111-015 (well site)

Site Size: 58.65 acres

Zoning: LIA B6 60 Z – Agricultural Preserve

General Plan: Land Intensive Agriculture – 60 acre density

Revised Project Statement:

The Applicant submitted a use permit application for an annual 60,000-case winery that went before the Sonoma Valley Citizens Advisory Committee (SVCAC) in 2018. While certain members of the SVCAC recognized the need to rehabilitate the old dairy property, SVCAC could not support the project due to its size, in particular the volume of wine production, the number of visitors and events, and related water usage from those activities. After taking time to re-evaluate, the Applicant submits this revised project to address SVCAC's concerns. As set forth in greater detail below, the revised project significantly decreases the production volume, number of tasting room guests, and size of events.

The project consists of a 30,000-case winery and public tasting room on a 58.65-acre site. The winery will be able to process winegrapes grown on-site from a 20-acre vineyard previously approved in 2017 (ACO17-0161). The entitled vineyard area is located within the site's 200-foot scenic corridor area along Highway 121 and Napa Road. The design of the winery buildings will ensure the site maintains a rural and agricultural character consistent with the historical agricultural uses on the property.

The winery will be able to process winegrapes from the on-site vineyard, as well as other vineyards located in Sonoma County and neighboring areas. At least 51% of the grapes processed on-site will come from Sonoma County. The Applicant will also continue to use portions of the site for grazing. The previously-entitled vineyard and grazing uses are agricultural and, therefore, not subject to this use permit.

The site is well suited for production and visitation due to its proximity to Highway 121. The change in use from an old dairy that has been largely destroyed due to the 2017 fire disaster to the proposed winery will dramatically improve the visual aesthetic along this entry point into the Sonoma Valley.

Proposed Operations and Agricultural Promotion:

Operations:

The winery facility and tasting room will be open seven days per week. Regular winery production hours of operation will be from 7:00 am to 8:00 pm. Hours of operation for the winery facility during harvest will be as needed. Public tastings, wine and food pairings, and events are a critical function of how wine is sold today. Visitors want to see how and where the wine is made, taste the possibilities of how they may integrate it into their own meal preparation and learn about the local agricultural practices that make the wine and food possible. In addition to featuring wine and wine related merchandise, the tasting room may also offer local agricultural related products grown or produced in Sonoma County.

Employees:

15 year round employees.

The revised project maintains the same number of 15 regular employees, but no longer requests 6 additional employees during harvest.

Daily Tasting & Tours:

Daily tours and tastings will occur from 10:00 am to 5:00 pm and will include food and wine pairings. This will consist of an average of 65 visitors daily and a maximum capacity of 135 visitors. The site will hold no more than two tours per day with a maximum attendance of 10 guests per tour (included in the 135 max above). All tours will include a wine tasting with an optional food pairing. The tour will include a portion of the winemaking facility and the outdoor terraces. A small commercial kitchen is proposed for food preparation for these limited activities. No cooked to order food is proposed. Daily tastings were reduced from a maximum capacity of 200 guests to a maximum of 135 guests per day.

Winery Events:

The project proposes 28 Agricultural Promotional & Industry Events as follows:

- 4 events with a maximum capacity of 200 attendees.
- 9 events with a maximum capacity of 100 attendees.
- 15 events with a maximum capacity of 50 attendees.

The SVCAC raised concerns about the size of the events for the previous iteration of the project. In response, the Applicant has significantly reduced the size of its largest events from a maximum capacity of 500 to 200, medium-sized events from 275 to 100, and smaller-sized events from 80 to 50 guests. The project proposes an increase in the number of its smallest events, but this revised project decreases the overall scale of annual event guests by 53% and the average event size by 59%. The comparison chart below details the significance of the project reductions in response to the SVCAC hearing.

PRIOR PROJECT	Event Capacity		# of Event		uests Per vent Type
	500		4		2000
	275		10		2750
	80		6		480
Avg Siz Per Ever	e 1t 285	Annua Events		Annuc Guesi	

REVISED PROJECT	Event Capacity		# of Event		uests Per vent Type
	200		4		800
	100		9		900
	50		15		750
Avg Size Per Ever	e 11 116.7	Annua Events	el 28	Annua Guest	~ 7/5/)

All events will be private and focused on education of Sonoma's regional agriculture. All events shall conclude no later than 9:00 PM and clean-up activities shall end by 10:00 PM. Events will occur throughout the year. A sample event calendar is as follows:

Events	Jan	Feb	Mar	Apr	May	Jun	Jul	Aug	Sept	Oct	Nov	Dec	Total
Small	1	1	2	2	2	1	1	1	1	1	1	1	15
Medium		1		1	1	1	1	1	1	1	1		9
Large						1	1	1	1				4

The Applicant anticipates that the smaller events with 50 guests will consist of winemaker dinners, lunches, and other food and wine pairings for customers, clients, wholesalers, distributors, and other members of the trade. These smaller events will be by invitation only. A small commercial kitchen is proposed for food preparation for these limited activities. No cooked to order food is proposed. The Applicant anticipates participating in industry events as part of the winery's general public tasting room operations, which may include industry promoted activities such as Savor Sonoma Valley, April in Carneros, etc.

Music:

While the winery has very limited residential neighbors, the project wants to be sensitive to any sensitive receptors. To that end, the winery does not propose amplified music in outdoor areas. Acoustic music may occur inside the winery and tasting room buildings as well as the outdoor courtyard and terrace areas immediately adjacent to the tasting rooms. Acoustic music shall be concluded no later than 9:00 PM.

Existing Use of Property:

The 58-acre site was formally operated as the Stornetta Dairy and for animal grazing. The parcel is under a Williamson Act contract. There were several existing buildings and barn structures located on the south end of the site fronting Highway 121. There is a former wastewater pond on the southwest corner of the site, also adjacent to Highway 121. All existing buildings were destroyed during the October 2017 Nunns Fire and the site is currently vacant with the exception of an existing 90,000 gallon fire protection and potable water storage tank, a 28,000 gallon treated process wastewater storage tank, and an approximately 500 SF barn which will be removed.

Proposed Improvements:

The Applicant proposes to build a two-story winery with the first floor being built into the hillside reducing the structure's visibility from the highway. The Applicant assessed the original proposed winery building design based upon the comments received from the SVCAC and has reduced the proposed winery facility square footage by 18%, from 43,318 SF to approximately 35,679 SF.

Wine production will be on the ground floor with the tasting room, and the office building, and courtyard areas will be on the second level above. As shown in the site plan, the Applicant has designed the buildings and landscape to preserve and complement the rural character of the area. The architectural style of the winery and outbuildings draws upon Sonoma County's agrarian heritage of large barns and small outbuildings. The design focuses on vernacular forms and traditional materials, such as white stained wood board and batten siding with corrugated metal roofing, consistent with the agricultural buildings that had historically existed on the site before being destroyed by the 2017 fires. The buildings are conceived as simple, plain-spoken shelters which will accommodate a 21st century wine making facility and a pleasant wine tasting experience with views of the south Sonoma valley.

The main winery and tasting building will be built into the hillside facing the south and include wine caves built within the hillside. This building layout and inclusion of caves will help decrease energy requirements from a conditioning perspective since the hillside will help regulate any fluctuations in temperature. The winery and tasting room facility will have less than significant impacts on greenhouse gas emissions and air quality based on the enclosed report from Geosyntec.

All new structures will sit behind the 200-foot scenic corridors from Highway 121 / 12 and Napa Rd. The project would reconstruct two burned agricultural buildings that were destroyed during the 2017 Nunn wildfire and located within the 200-foot scenic corridor. Existing paved parking surrounding the reconstructed agricultural buildings will also be improved and remain as part of the site. Vineyards in the scenic corridor will replace improvements in much of the area currently developed.

Traffic, Property Access, Parking, and Signage:

The project site benefits from being on a major transportation corridor as a result of its location on State Highway 121 / 12. Traffic and Circulation consultant, W-Trans, prepared an addendum to the previous traffic study to reflect the revised project and analyze vehicle miles traveled to the project site. Due to lack of any new development projects within the vicinity of the site and more people working from home, W-Trans concluded that traffic counts would not be substantially different than its previous traffic counts from 2016.

When the project came before SVCAC, some members raised comments about the impacts on traffic. In light of the significant reductions to the number of visitors to the tasting room and the size of events under the revised project, the Applicant has taken great steps to reduce the project's potential impacts. Based on W-Trans' review, the revised project will result in an annual average of less than 110 daily trips.

The site currently has four existing driveways from Highway 121 for vehicle access. The project will eliminate two of these driveways and improve the two others for primary site access. The first driveway will be for guest and staff access to the property. The second driveway to the west will be for service and truck access. There is an existing center turning lane along Highway 121 in front of the site providing left turn access for east bound traffic.

In addition to the driveways along Highway 121, the site currently has two existing driveways that front Napa Road. The Applicant intends to retain both for agricultural access. All driveways will have gates; the main entry gate shall be open during business hours.

The Site Plan includes 90 parking spaces for guests and staff and overflow and events. Truck loading zones, trash enclosures, and traffic circulation is reflected on the site plan. Parking designations for ADA accessible locations have been labeled in accordance with applicable code. The Applicant also plans to

include bicycle parking. There will be sufficient parking on site for all public tasting and events.

The primary winery signage shall consist of an identification monument sign placed at the main entry driveway from Highway 121, consistent with County sign standards. Low-level post and panel signs will be used on-site to direct visitors and winery related vehicles. For certain scheduled events, a sign indicating that "the winery is closed for private event" will be posted.

Water Supply:

The project will receive water from two sources: groundwater and recycled water from the treated process waste water system. The project includes a new sustainable wastewater system that will allow the winery to treat that water so it can be used for irrigation (as discussed in greater detail below). In order to provide the County and State required 50 foot well seal, the project will replace the existing well to serve domestic uses. Hydrologist, O'Connor Environmental Inc., prepared a Ground Water Report, which is enclosed with this revised project description. As indicated by the Ground Water Report, there is sufficient groundwater available to supply this project. Further, the project will require significantly less water compared to the previous iteration reviewed by SVCAC.

Waste Disposal:


A Wastewater Feasibility Study has been prepared by NorCal Civil and submitted with this revised project description to address disposal of sanitary sewage and winery process wastewater. Sanitary sewage will be collected into septic tanks, treated to appropriate discharge levels via an engineered package treatment system and dispersed via a subsurface drip irrigation septic system in the area receiving percolation test approval from Sonoma County PRMD. There is sufficient area available to disperse of the proposed sanitary wastewater from the project at acceptable application rates.


Winery process wastewater will be treated to acceptable irrigation levels by a separate package treatment system. Treated winery process wastewater will be stored in a pond or storage tank during periods of seasonal rain and saturation, when irrigation cannot occur. The project will be able to utilize its treated process wastewater for vineyard irrigation and winery landscaping to reduce any impact to groundwater supply. A wastewater site plan is provided with this revised project description to assist with review of the wastewater feasibility study and these project components.

Grape pomace generated by the winemaking operations will be collected in dumpsters onsite and routinely transported offsite for conversion into compost by a County approved composting operation. No onsite composting of grape pomace is currently planned.

Drainage and Grading:

Please refer to the Preliminary Grading and Drainage Plan Set enclosed with this revised project description. The project's site drainage complies with the Sonoma County Grading Ordinance which includes the use of storm water treatment and infiltration in site design. A supplemental Storm Water Management Report and Plan summarizing the overall drainage impacts is also enclosed with this revised project description.

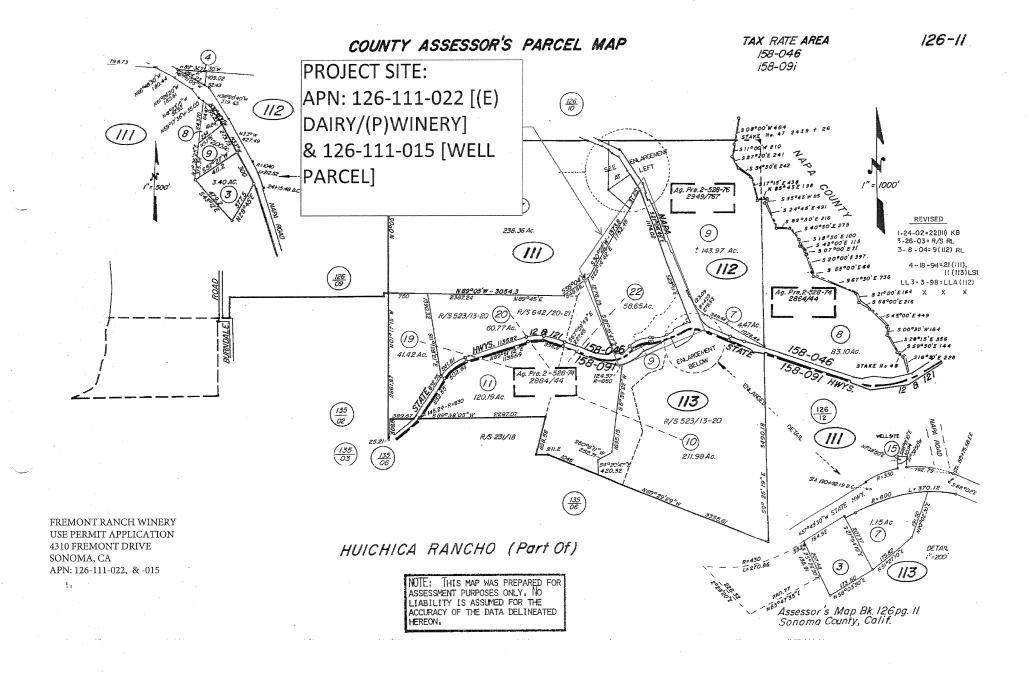

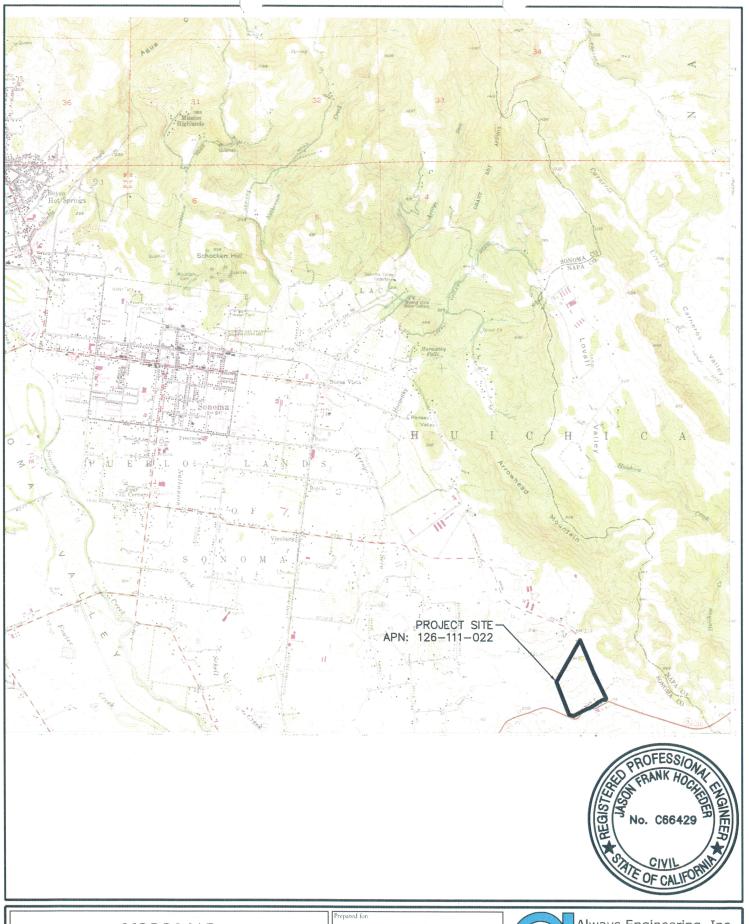

USGS MAP

4310 Fremont Dr. Sonoma, CA APN: 126-111-022

Freemont Ranch LLC

September 19, 2016




Always Engineering, Inc. Civil Engineering & Topographic Surveying 131 Stony Circle, Suite 1000(707) 542-8795 Santa Rosa, CA 95401 Fax (707) 542-6147 jason@alwayseng.com





FREMONT RANCH WINERY

USE PERMIT SUBMITTAL 4310 FREMONT DRIVE, SONOMA, CA 95476 APN#:126-111-022

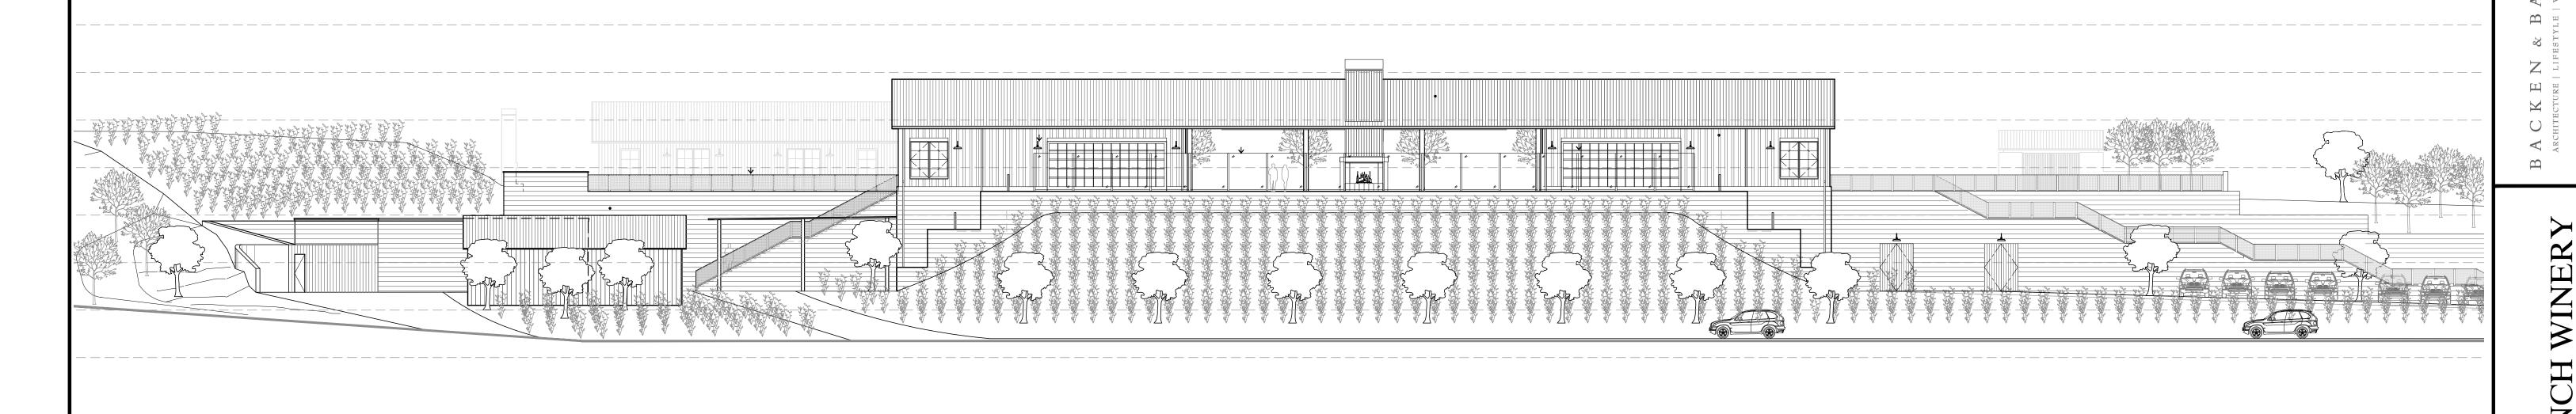

ABBREVIATIONS	SYMBOL LEGEND	PROJECT DIRECTORY	DRAWING INDEX	NT RA USE PERM 4310 FREI SONON APPN#
				$\overline{}$
& And E.J. Expansion Joint I.D. Inside Diameter REFR. Refrigerator VERT. Vertical Control of the Nation Contro			SHEET NUMBER REVISION NUMBER REV 1 REV 2	-
Q At ELEC. Electrical INSUL. Insulation REINF. Reinforced V.G.D.F. Vertical Grain Douglas Fir O Diameter or Round EMER. Emergency INT. Interior REQ. Required V.I.F. Verify in Field # Pound or Number ENCL. Enclosure INTER. Intermediate RESIL. Resilient VOL. Volume A.C. Air Conditioning or A.C. Asphaltic Concrete EQ. Equal JST. Joist REV. Revision/Revised/Reversed W/ With ACOUS. Acoustical EQUIP. Equipment JT. Joint RM. Room W.C. Wall Covering A.D. Area Drain EXIST. Existing KIT. Kitchen REMOV. Removable WD. Wood ADJ. Adjustable EXP. Expansion LAM. Laminate ADJAC. Adjacent EXT. Exterior LAW. Lavatory A.G.C. Asponsion EXT. Exterior LB. Pound South W.P. Work Point or AGGRA Advanced to EXP. Expansion EXT. Exterior LB. Pound South	D 8 B INTERIOR ELEVATION NUMBERS SHEET NUMBER	OWNER: Fremont Ranch, LLC Contact: Guy Byrne 68 Coombs St. Suite D-10 T: (707) 287-1026 Napa, CA 94559 E: guy.byrne@LRico.com	UP0.0 COVER SHEET 03/20/18 02/03/22 UP0.1 PROJECT INFORMATION 02/03/22 UP0.2 EXISTING SITE PHOTOGRAPHS 03/20/18 02/03/22 UP1.0 PROPERTY OVERALL SITE PLAN 02/03/22 UP1.1 SITE PLAN DETAIL 03/20/18 02/03/22	FRE
ALT. Alternate ALUM. Aluminum APPROX. Approximate ARCH. Architectural ASPH. Asphalt A.S.R.B. Architectural site review board BD. Board BEV. Beverage LIN. Linear LIN. Linear LIN. Linear LIN. Linear LIN. Linear S.C. Solid Core S.C.D. See Civil Drawings W.P.M. Waterproofing W.P.M. Waterproof Membrane WSCT. Wainscot WS.P. Wet Standpipe WT. Weight WS.P. Weight SECT. Section S.E.D. See Electrical Drawings S.E.D. See Electrical Drawings SEP. Separation SEP. Separation S.H. Sprinkler Head	SECTION/ ELEVATION NUMBER SHEET NUMBER	PLANNING DEPARTMENT: Sonoma County Permit and Resource Management Department 2250 Ventura Avuenue Santa Rosa, CA 95403	UP2.0 LOWER LEVEL - PRODUCTION, CAVE, MECH. & 02/03/22 TRASH BLDG. FLOOR PLANS UP2.1 UPPER LEVEL - MAIN PUBLIC BUILDING FLOOR PLANS UP2.2 UPPER LEVEL - COURTYARD & OFFICE BUILDING PLOOR PLANS FLOOR PLANS	
BITUM. Bituminous F.H.W.S. Flat Head Wood Screw BLDG. Building FIN. Finish Overlay Overlay SHT. Sheet BLK. Block FIXT. Fixture MECH. Mechanical SHTG. Sheathing BLKG. Blocking FLR. Floor MEMB. Membrane SIM. Similar BM. Beam FLASH. Flashing MTL. Metal SL. Sliding B.O. Bottom of BOT Bottom FLUOR. Fluorescent MFR. Manufacturer S.K.D. See Kitchen Drawings B.P. Building Paper F.O.C. Face of Concrete BTWN. Between C.B. Catch Basin F.O. Ply Face of Plywood MUL. Mullion SPEC. Specification or Special	DETAIL NUMBER SHEET NUMBER SHEET NUMBER ENLARGED DETAIL NUMBER	ARCHITECT: Backen & Backen Contact: Dusan Motolik 1421 Main Street T: (510) 213-0650 St. Helena, CA 94574 E: dmotolik@backenarch.com	UP3.0 ELEVATIONS & SECTIONS UP3.1 ELEVATIONS & SECTIONS UP3.2 UPPER LEVEL - OFFICE & AGRICULTURAL BUILDINGS 03/20/18 02/03/22 UP4.0 COLOR STUDY & MATERIAL PALETTE 02/03/22	Plot Date 02/03/2023 Drawn By DM Checked By DM Project No. 2015-68 Date Issue 09-22-2016 USE PERMIT SUBMITTA 03-20-2018 UP SUBMITTAL - REV 1
CER. Ceramic F.P.R.F. Fireproof N. North S.S. Stainless Steel CIP Cast in Place FR. Frame N. North S.S. Stainless Steel C.J. Control Joint FT. Foot or Feet N.I.C. Not in Contract S.S.D. See Structural Drawing CLKG. Ceiling FTG. Footing NO. or # Number S.S.K. Service Sink CLKG. Caulking FURR. Furring NOM. Norminal STD. Standard CLR. Clear FUT. Future N.T.S. Not to Scale STL. Steel C.M.U. Concrete Masonry Unit G. Gas Outlet O.A. Overall CNTR. Counter GA. Gauge O.C. On Center STRL. Structural CONC. Clean-Out GALV. Galvanized O.D. Outside Diameter (Dim.) COL. Column G.D. Garbage Disposal CONC. Concrete GEN. General COND. Condition G.E. I Ground Fault (P) Proposed SYS. System	A6.1 SHEET NUMBER WINDOW SYMBOL	CIVIL ENGINEER: NorCal Civil Engineering Inc. Contact: Ben Monroe 6645 Center Street T: (707) 318-7099 Forestville, CA 95436 E: Ben@NorCalCivil.com	C1 COVER SHEET 03/20/18 02/03/22 C2 GRADING PLAN 03/20/18 02/03/22 C3 DRIVEWAY PROFILES 02/03/22 C4 DRAINAGE PLAN 03/20/18 02/03/22 C4 WSTWG MISES WAS SITE FLAN 03/20/18 02/03/22 WW1 WASTEWATER PLAN 02/03/22	
CONN. Connection Interrupt PERIM. Perimeter T. Tread CONST. Construction GL. Glass PL. Plate T.B. Towel Bar CONT. Continuous GND. Ground PLAS. Plaster T.C. Top of Curb CONTR. Contractor GR. Grade PLAS. Plaster T.C. Top of Curb CLOS. Closet G.S.M. Galvanized Sheet PLYWD. Plywood TEL. Telephone C.T. Ceramic Tile PNL. Panel TEMP. Tempered CTR. Center GYP. Gypsum PNT. Paint T.&G. Tongue & Groove C.W. Cold Water H.B. Hose Bibb P.S.I. Per Square Inch DBL. Double H.C. Hollow Core or DET. Detail P.T. Pressure Treated T.M.E. To Match Existing T. Tread T. Tread T. Tread T. Towel Bar T. Detail T.B. Towel Bar	E DOOR SYMBOL REVISION	LANDSCAPE ARCHITECT: MacNair Landscape Architects Contact: Don MacNair PO Box 251 T: (707) 833-2288 Kenwood, CA 95452 E: don@macnairlandscapes.co	O L-1.2 CONCLITTEANTING LAN	COVER SHEET
D.F. Drinking Fountain DIA. Diameter HDBD. Hardboard PTD. Painted T.O.C. Top of Concrete T.O.P. Top of Plate T.O.P. Top of Pla	GRID LINE ROOM ROOM NAME ROOM NUMBER	PLANNING CONSULTANT Summit Engineering Contact: Demae Rubins 575 W College Ave, Suite 201 T: (707) 636-9166 Santa Rosa, CA 95401 E: demae@summit-sr.com	L-1.3 CONCEPT PLANTING PLAN O9/01/22	SCALE: NTS
(E) Existing H.R. Handrail REF. Reference VAR. Varies E.I.F.S. Exterior Insulation & H.W.H. Hot Water Heater REFL. Reflected V.C.T. Vinyl Composition Tile Finish System VEN. Veneer	FLOOR ELEVATION OR DIMENSION POINT			

PROJECT STATISTICS PROJECT NAME: FREMONT RANCH WINERY APPLICABLE CODES SONOMA COUNTY MUNICIPAL CODE 4310 FREMONT STREET PROJECT LOCATION: SONOMA, CA 95476 2022 CALIFORNIA BUILDING CODE WITH SONOMA COUNTY AMENDMENTS APN#:126-111-022 2022 CALIFORNIA MECHANICAL CODE WITH SONOMA COUNTY AMENDMENTS 2022 CALIFORNIA PLUMBING CODE WITH SONOMA COUNTY AMENDMENTS (E) WELL SITE 2022 CALIFORNIA ELECTRICAL CODE WITH SONOMA COUNTY AMENDMENTS APN#: 126-111-015 2022 CALIFORNIA FIRE CODE WITH SONOMA COUNTY AMENDMENTS 2022 CALIFORNIA ENERGY WITH SONOMA COUNTY AMENDMENTS PARCEL SIZE : 58.65 ACRES ZONING: LIA B6 60 Z GENERAL PLAN: LAND INTENSIVE AGRICULTURAL DISTRICT- 60 ACRES DENSITY MAX. BUILDING HEIGHT: 35' EXCEPT AGRICULTURAL BUILDINGS AND STRUCTURES MAY REACH UP TO 50'. ADDITIONAL HEIGHT MAY BE PERMITTED PROVIDED THAT SITE PLAN APPROVAL IN ACCORDANCE W/ARTICLE 82 IS FIRST SECURED. MAX. LOT COVERAGE: 85.000 SF OR 5%, WHICHEVER IS GREATER SETBACKS: 200' SCENIC CORRIDOR SETBACK FROM THE CENTER LINE OF THE HIGHWAY 12/121 & NAPA ROAD APPLIES UNDER CALIFORNIA DEPARTMENT OF TRANSPORTATION JURISDICTION ENTRY DRIVEWAY: PLANNING AREA: 9-SONOMA VALLEY GROUND WATER AVAILABILITY: ZONE 3 - MARGINAL GROUNDWATER WILLIAMSON LAND CONTRACT: TYPE II CONTRACT USGS QUAD: AREA & SPECIFIC PLAN: SOUTH SONOMA VALLEY AREA II AREA PLAN PARCEL IS LOCATED IN/ON: - SCENIC LANDSCAPE UNITS & SCENIC CORRIDOR RESOURCE AREAS (OSRC-1) - STATE HIGHWAY & CLASS II BIKEWAY (CT-1i) - EARTQUAKE GROUND SHAKING HAZARD AREA W/ VERY STRONG GROUND SHAKING PROBABILITY VIII (PS-1a) - VERY HIGH LANDSLIDE SUSCEPTIBILITY W/ CLASS VIII & IX (PS-1d) - STATE RESPONSIBILITY AREA & MODERATE FIRE HAZARD SEVERITY ZONE (PS-1g) COUNTY ASSESSORS PARCEL MAP VICINITY MAP PROJECT SITE: COUNTY ASSESSOR'S PARCEL MAP 4310 FREMONT DRIVE SONOMA, CA 95476 PROJECT SITE: APN#:126-111-022 4310 FREMONT DRIVE (E) WELL SITE SONOMA, CA 95476 APN#:126-111-015 APN#:126-111-022 Mission Highlands S 89°39'34" E 5 54°30'00" E R=1470.73 L=356.8 N 35°45'00" E ±143.97 Ac. ±238.36 Ac. ___S89°30′E 216.0 (111)-N40°30'W 275.0 Ag Pre 2-528-7 2949/767 14 R=350 L=110.98 15 S60'11'20'W 159.48 16 S60'11'20'W 141.77 17 N29'48'40'W 18.14 -N18*30'W 100.0 R/S 759/42-43 58.65 Ac.

Gundlach

Vineburg


Peru Rd

(116)

Bundschu Winery

Artesa Vineyards

Nicholson Ranch LLC Domaine Carneros 9

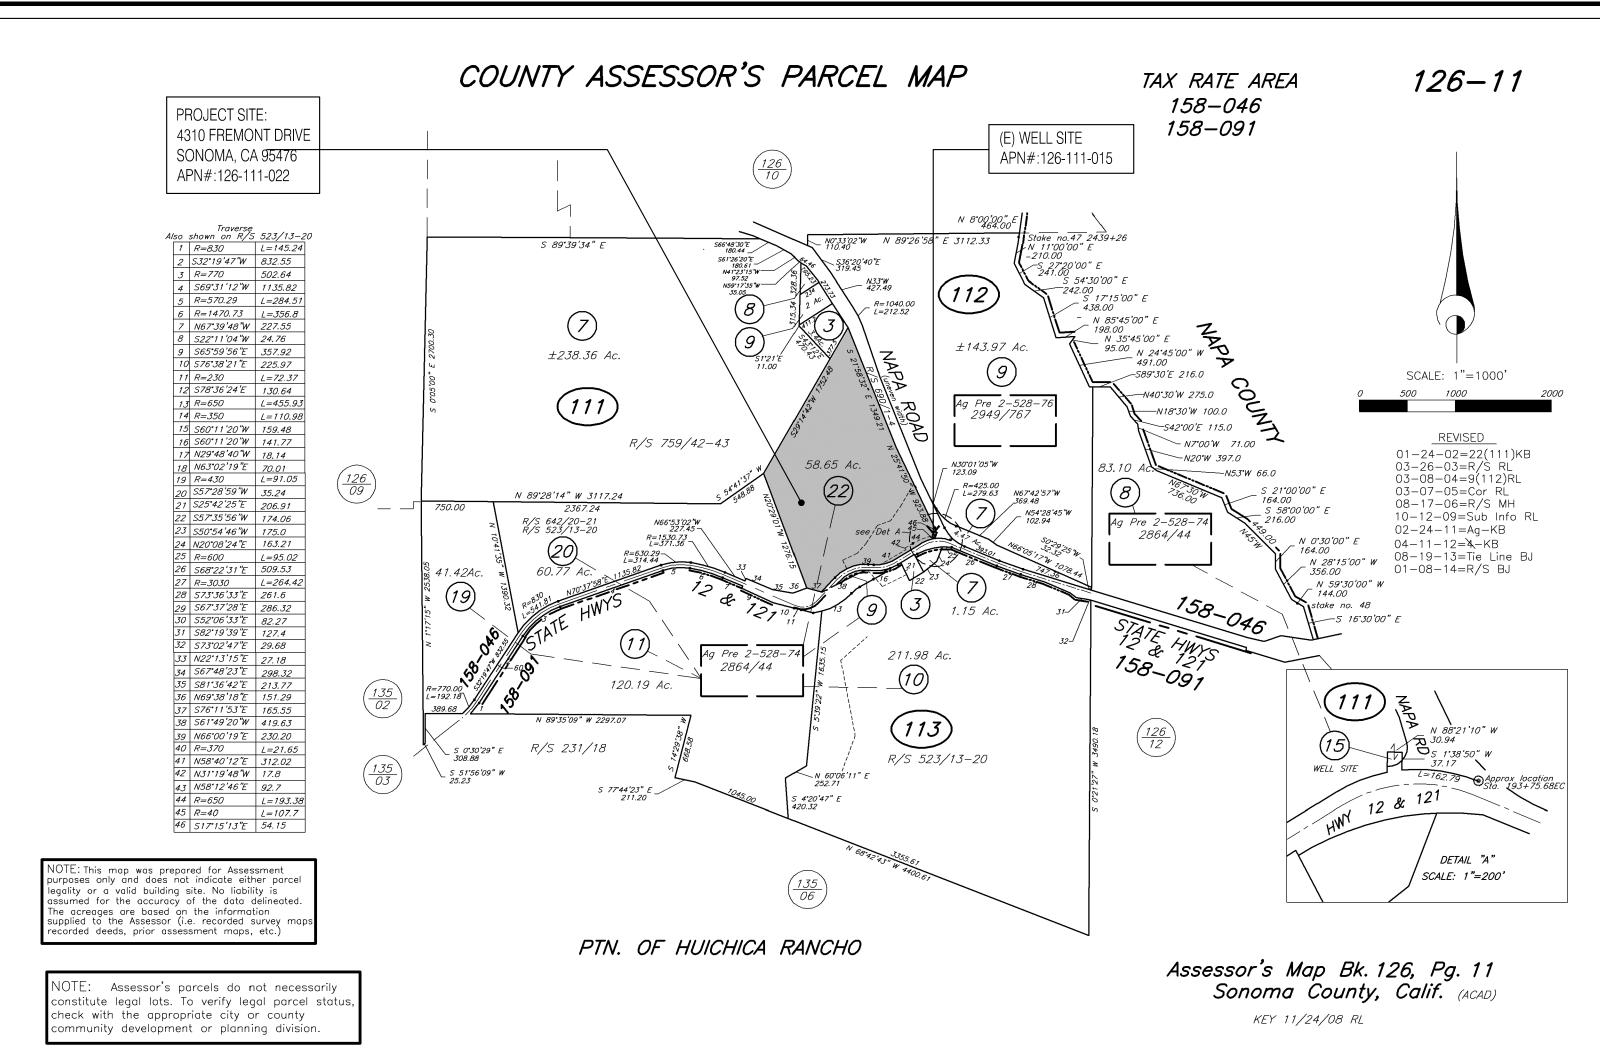

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USE PERMIT SUBMITTA

UP SUBMITTAL - REV 1

UP SUBMITTAL - REV 2

PROJECT


INFORMATION

SCALE: NTS

VIEW LOOKING SOUTHWEST



VIEW LOOKING SOUTH

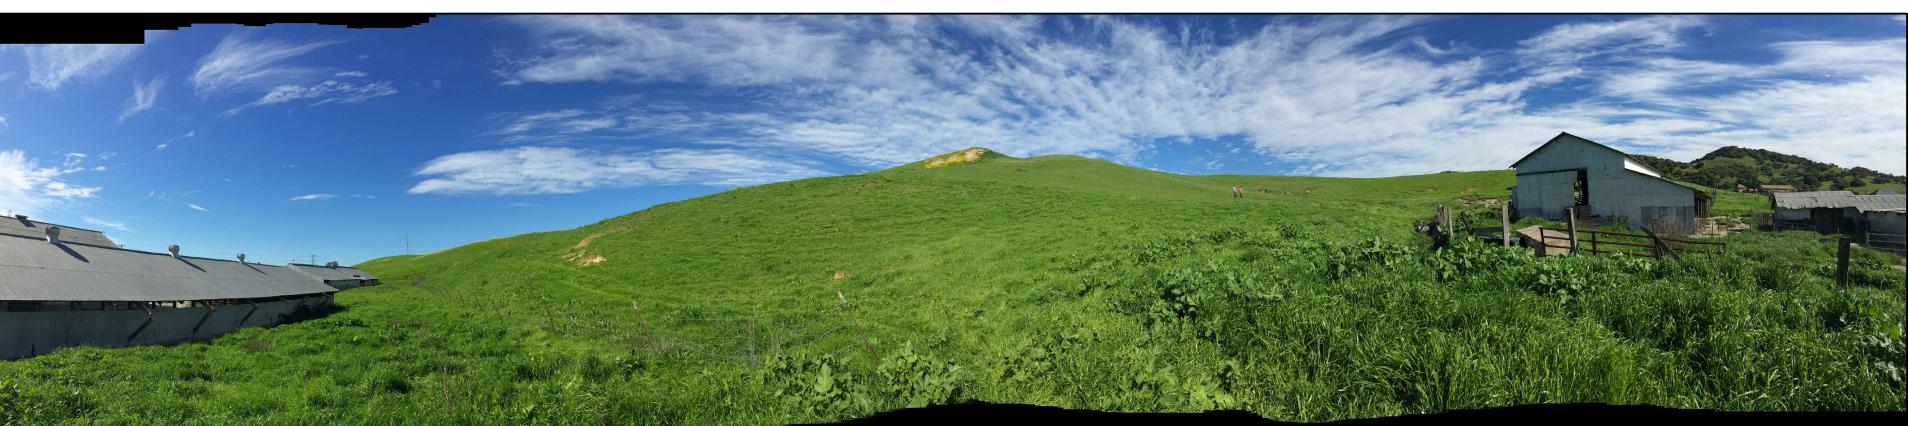

VIEW LOOKING NORTH






VIEW LOOKING SOUTH



VIEW LOOKING SOUTHEAST

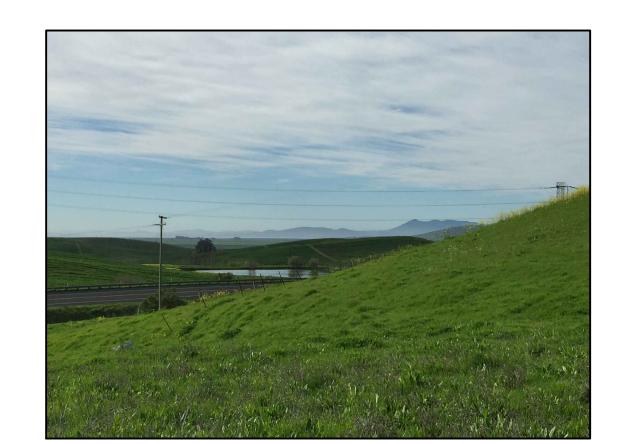

THE PHOTOGRAPHS WERE TAKEN IN

ALL EXISTING BUILDINGS WERE BURNED

THAT OCCURRED ON OCTOBER 18, 2017.

AND DESTROYED DURING THE NUNS FIRE

MARCH 2016.

VIEW LOOKING EAST

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RCHITHCTURE | LIFHSTYLE | WELLBHING

MONTECITO LOS ANGELES


USE PERMIT SUBMITTAL 4310 FREMONT DRIVE, SONOMA, CA 95476 APN#:126-111-022

Plot Date 02/03/2023
Drawn By DM
Checked By DM
Project No. 2015-68
Date Issue

EXISTING SITE PHOTOGRAPHS


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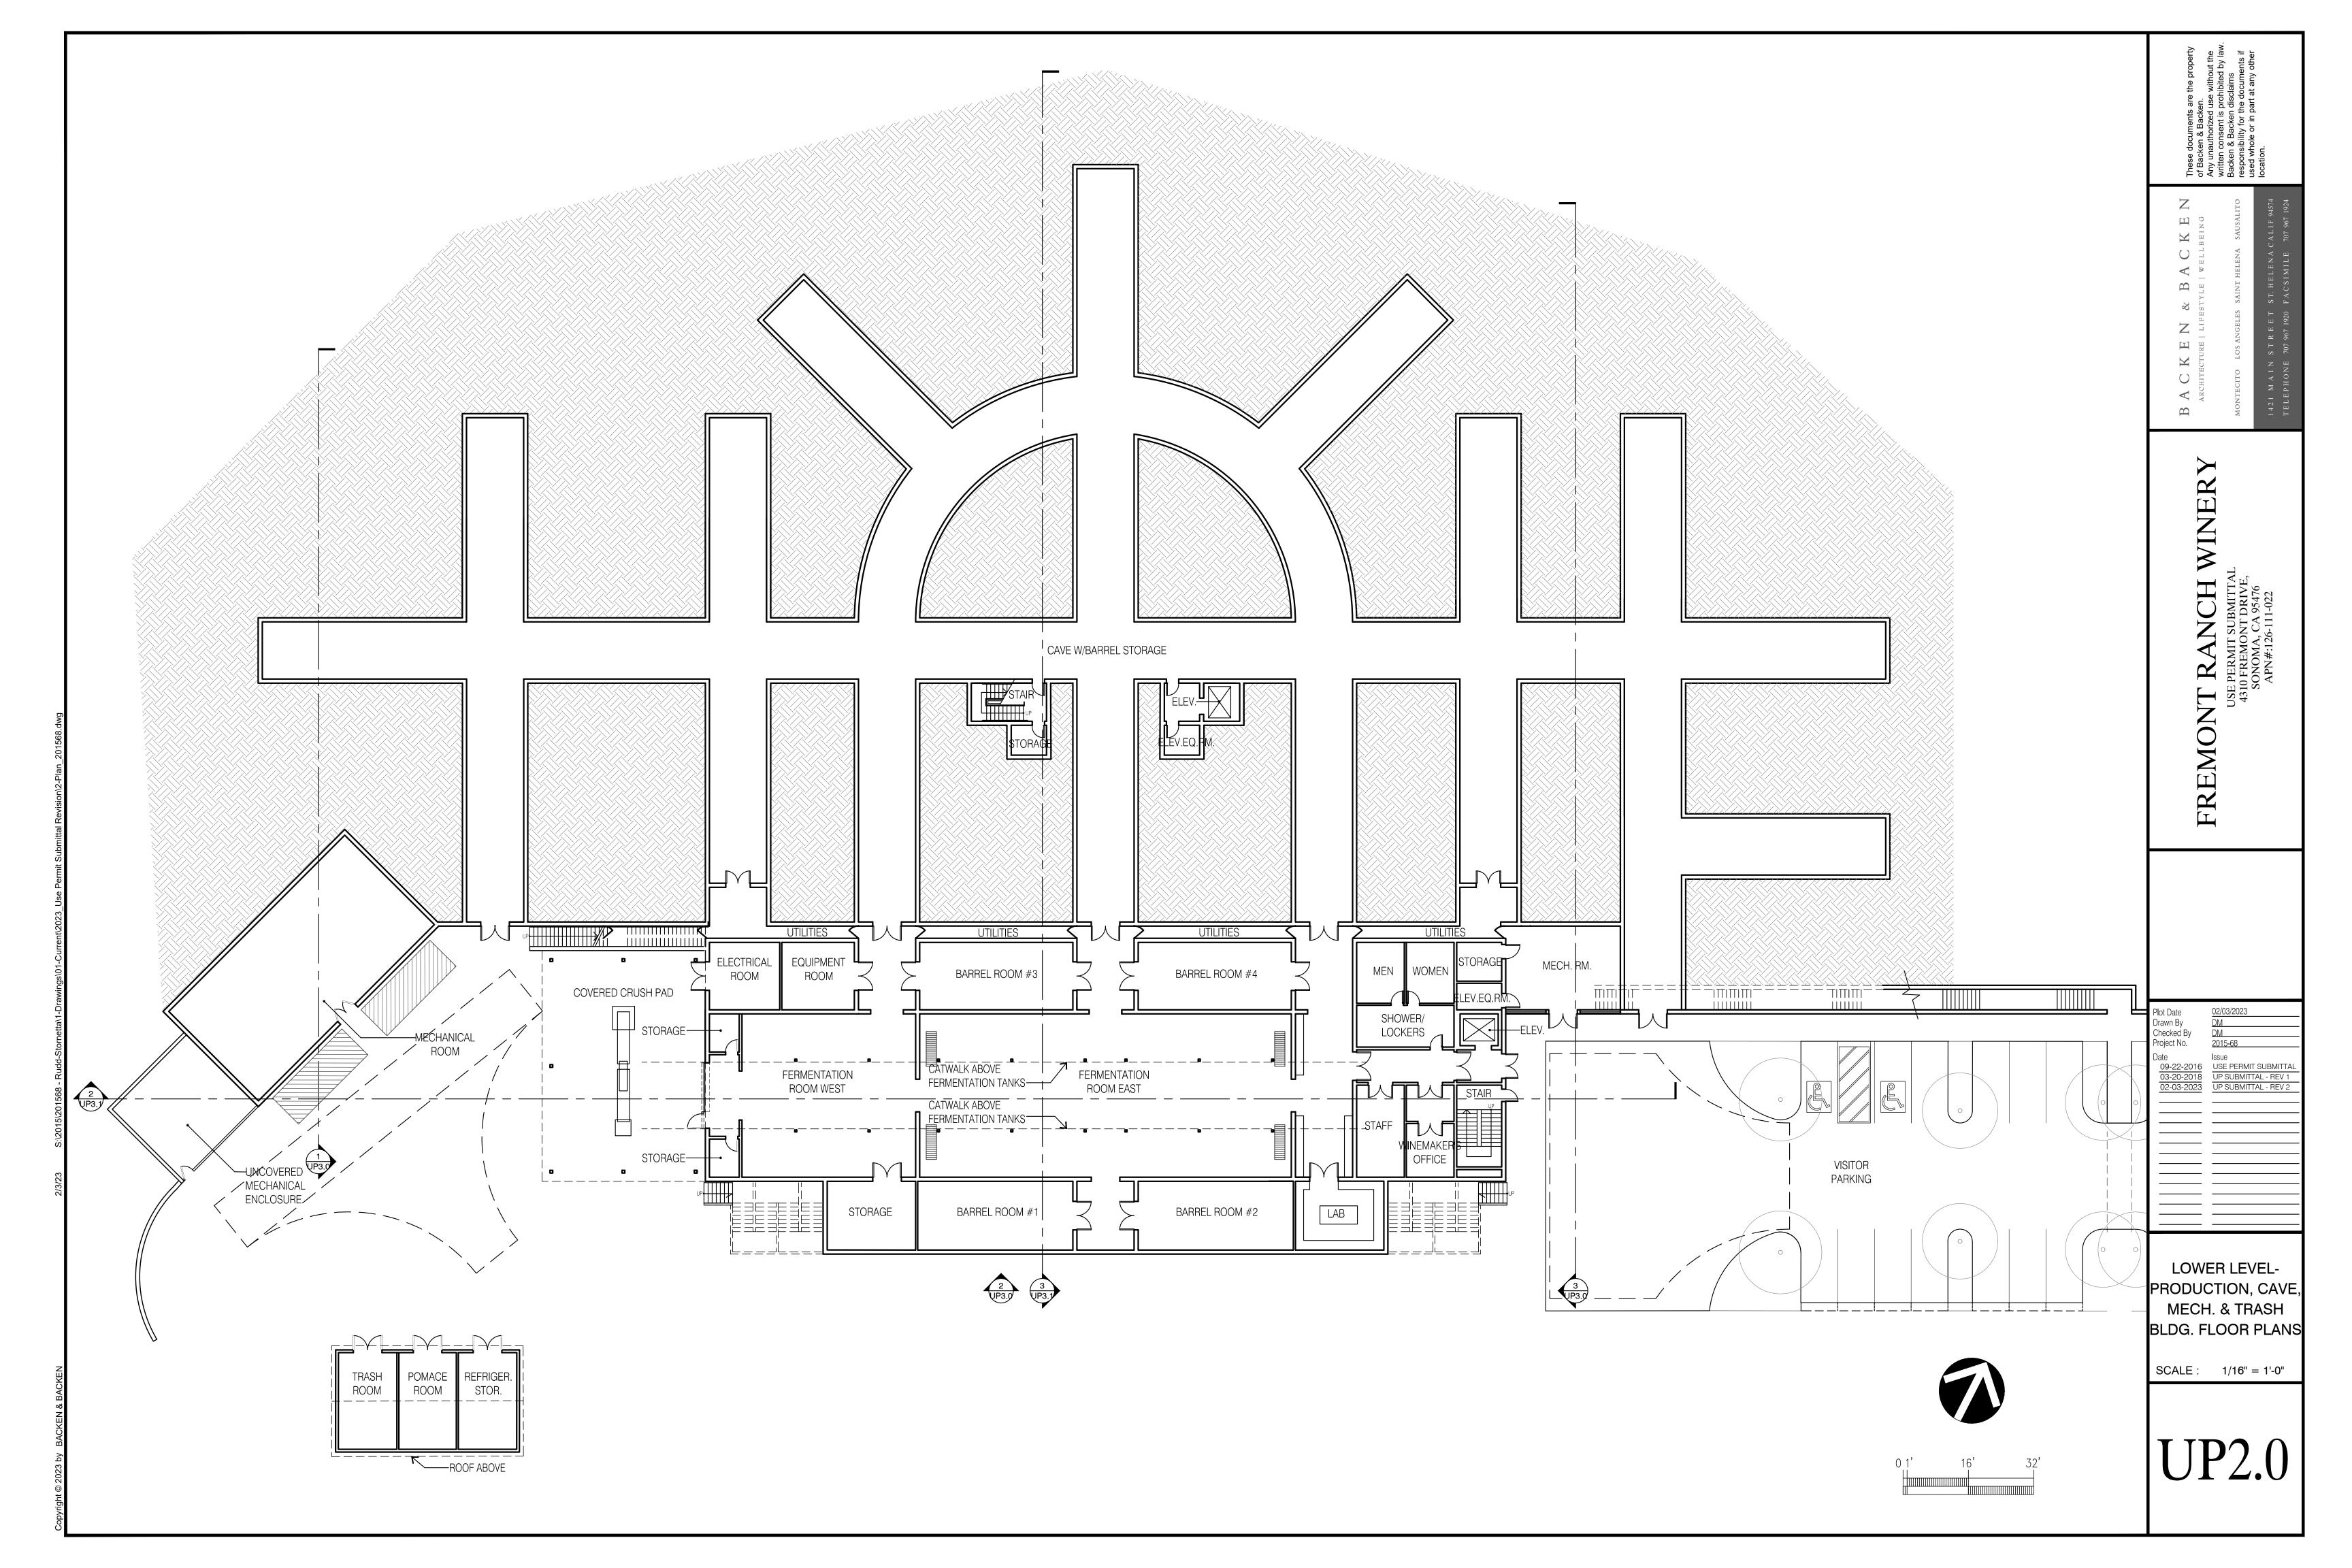
UP0.2

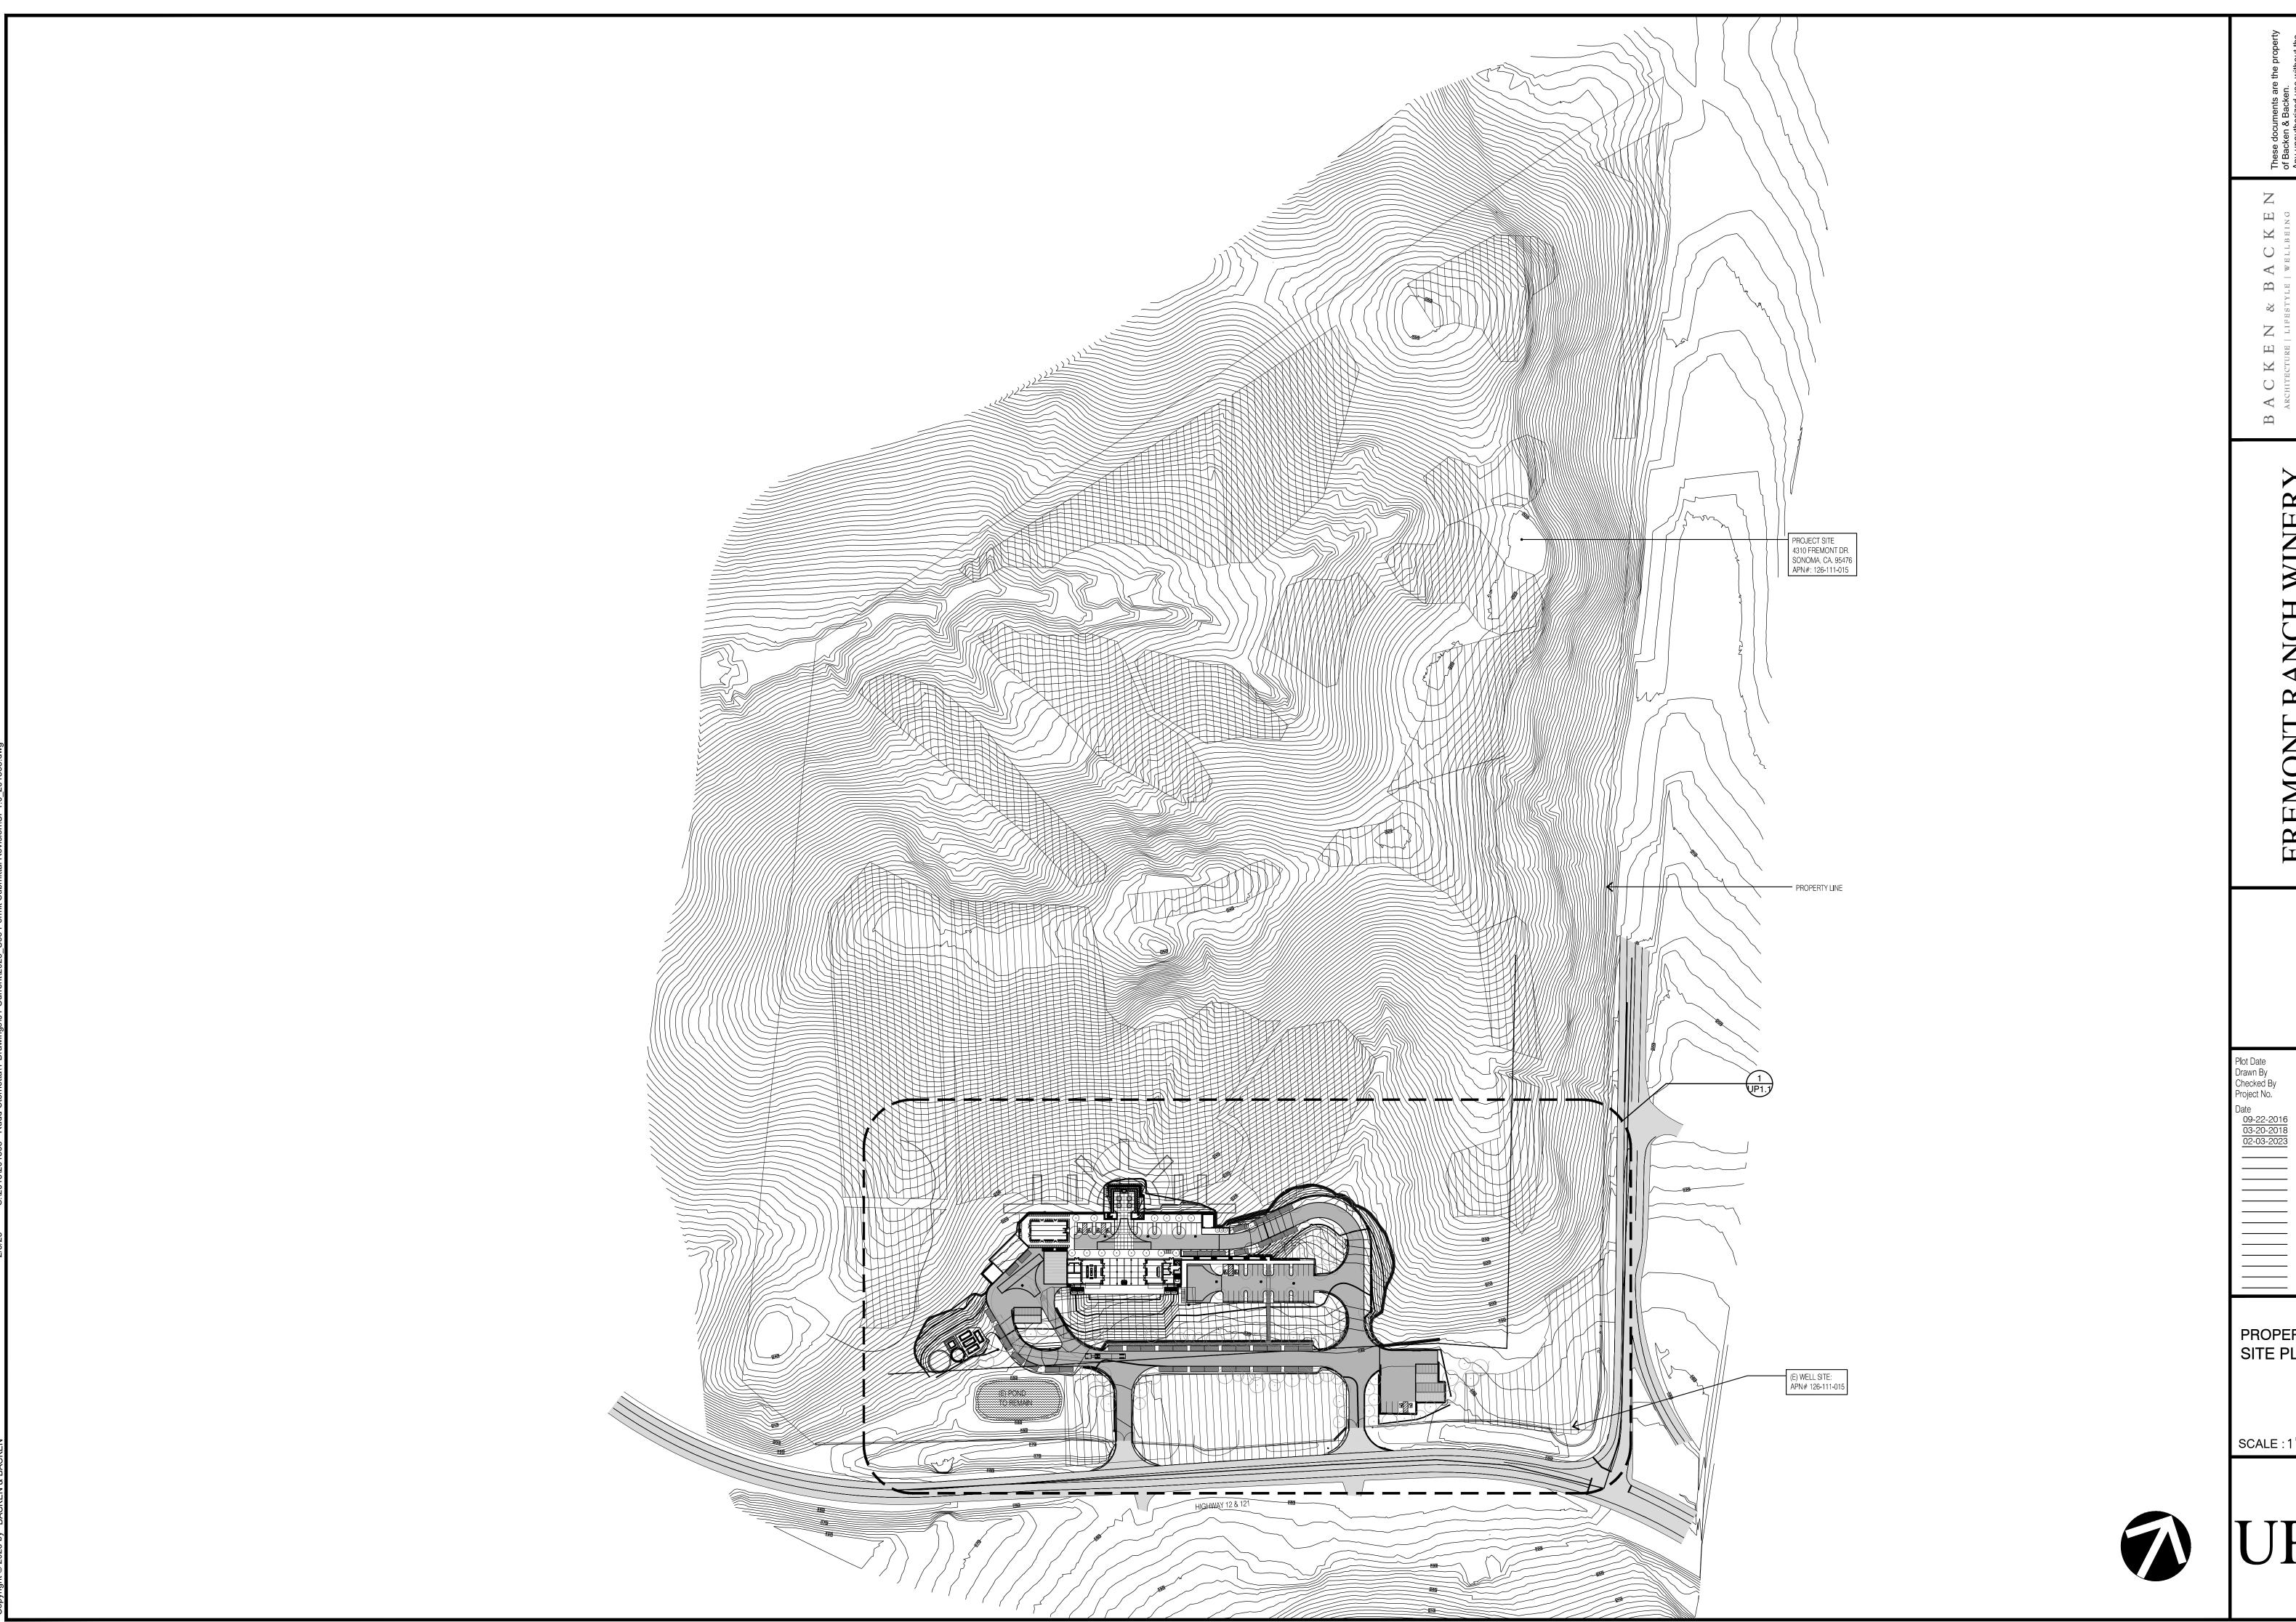



PROPERTY OVERALL SITE PLAN


SCALE:1"=120'




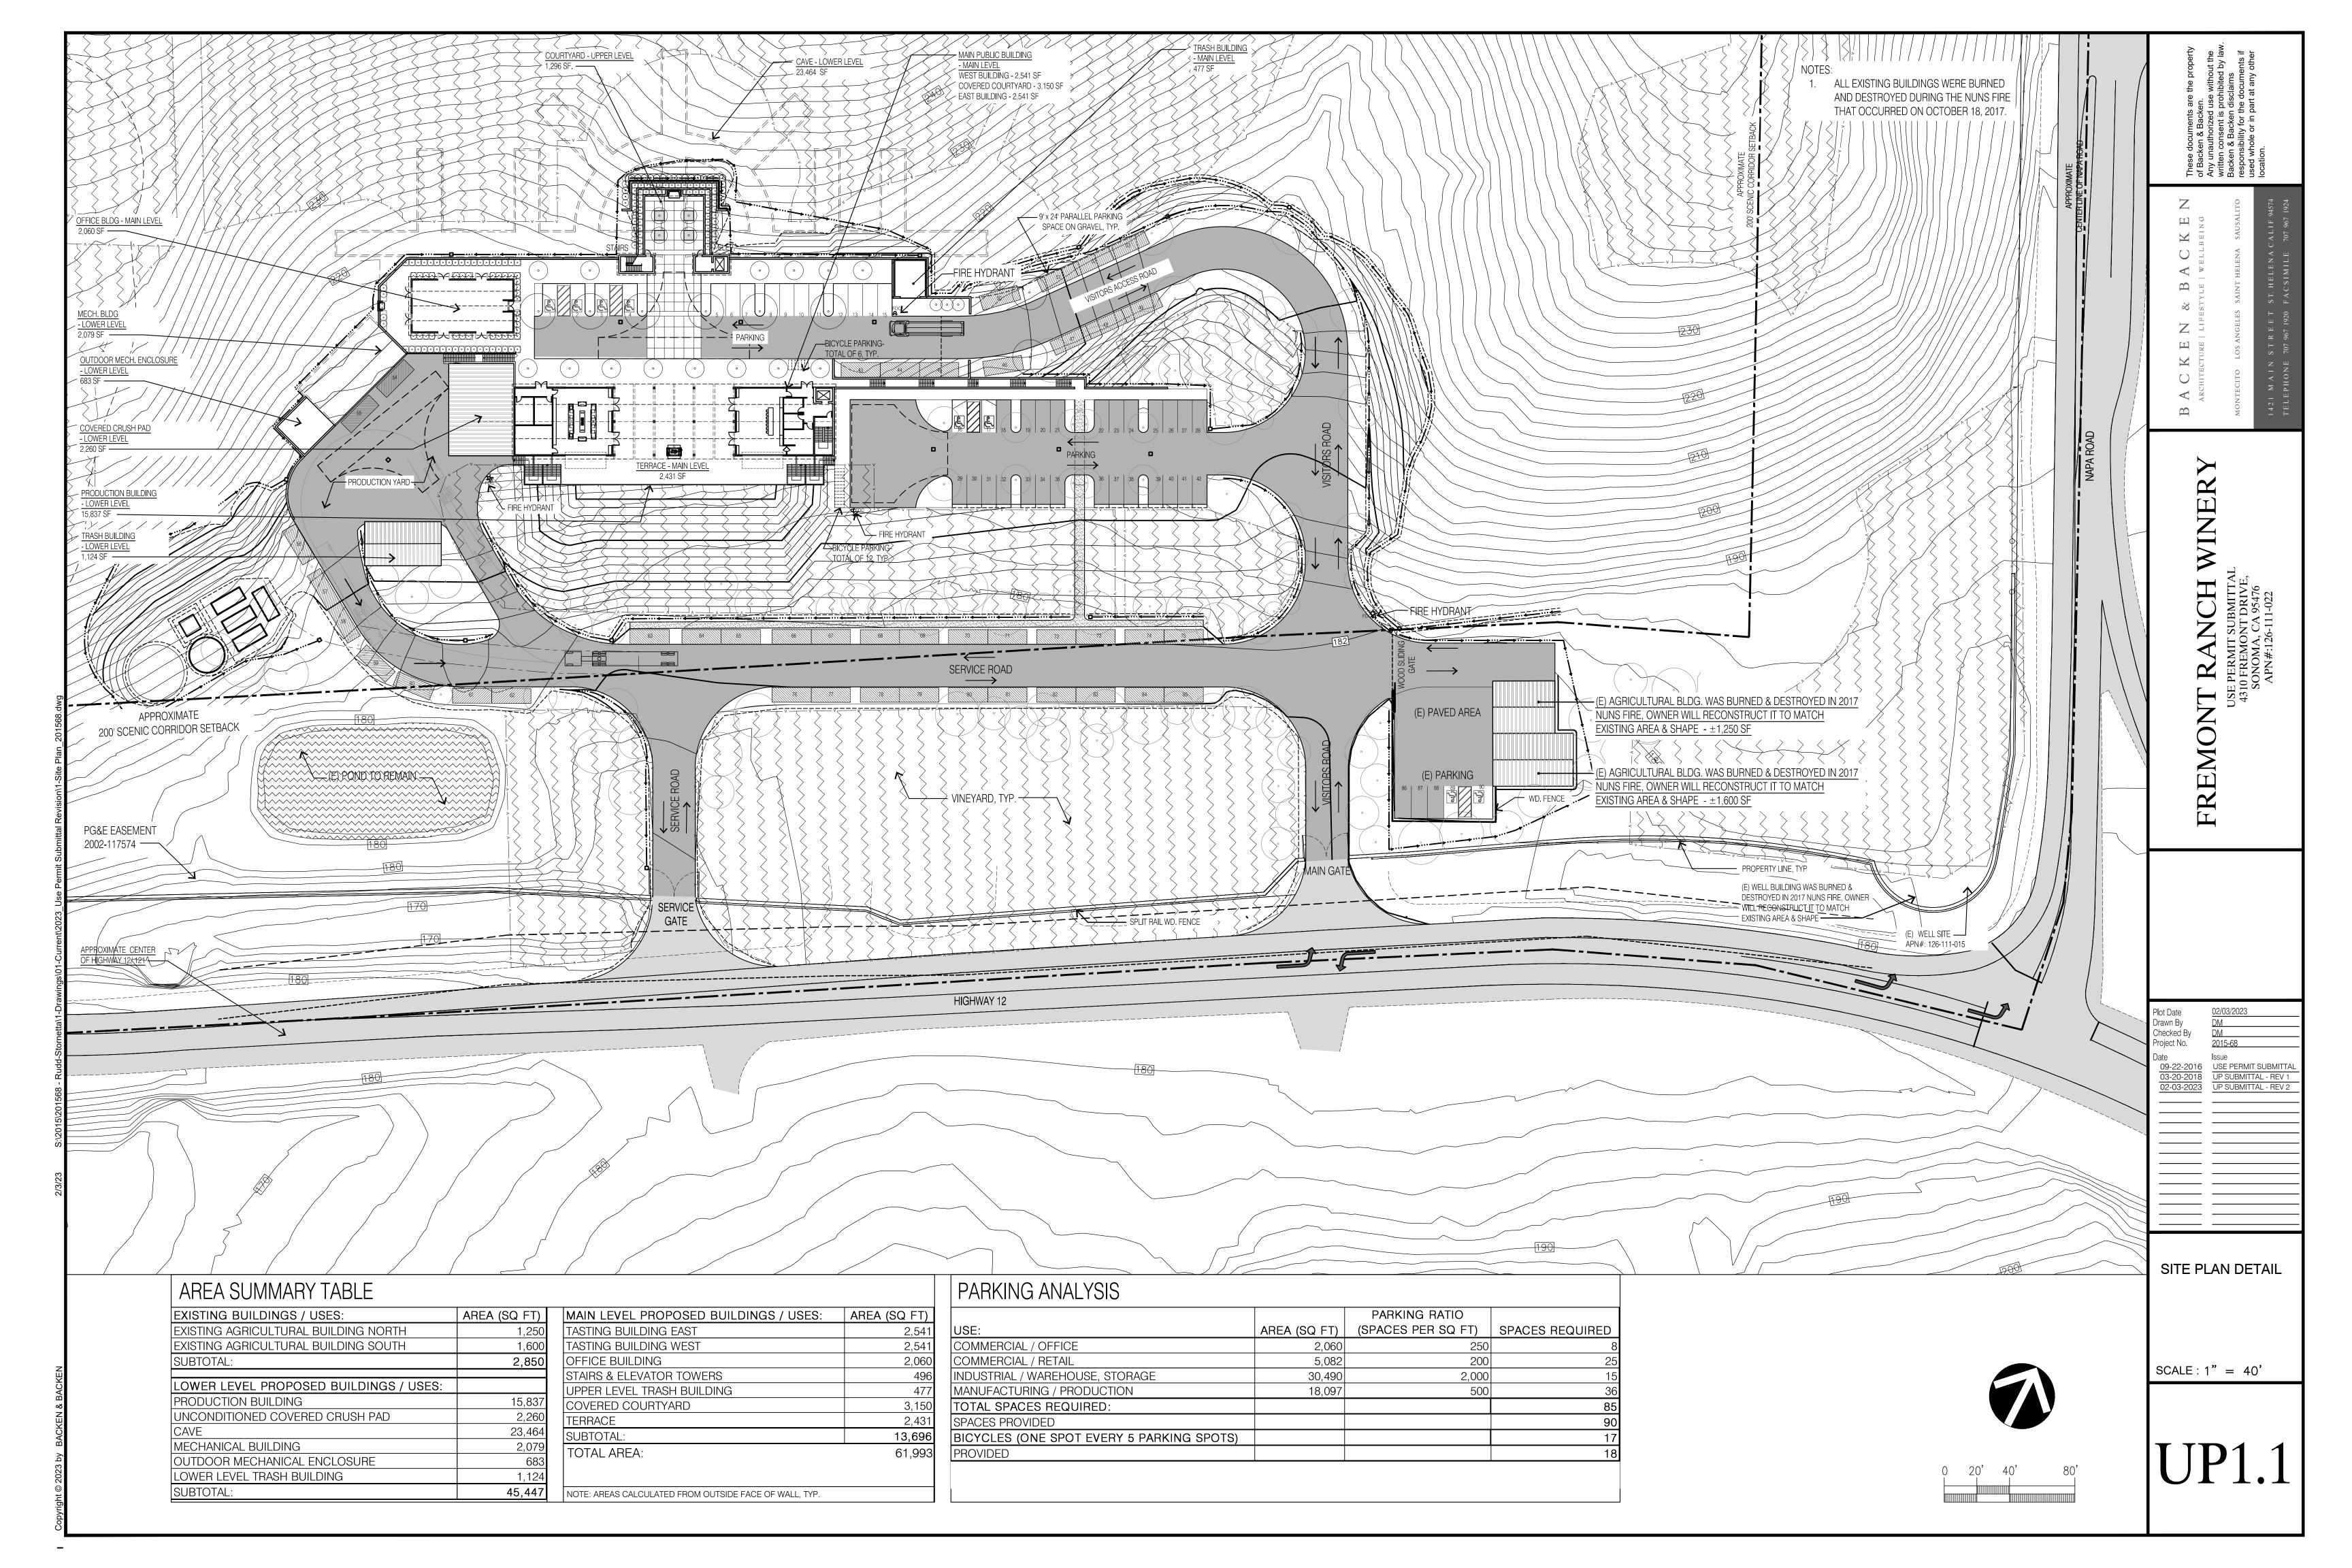


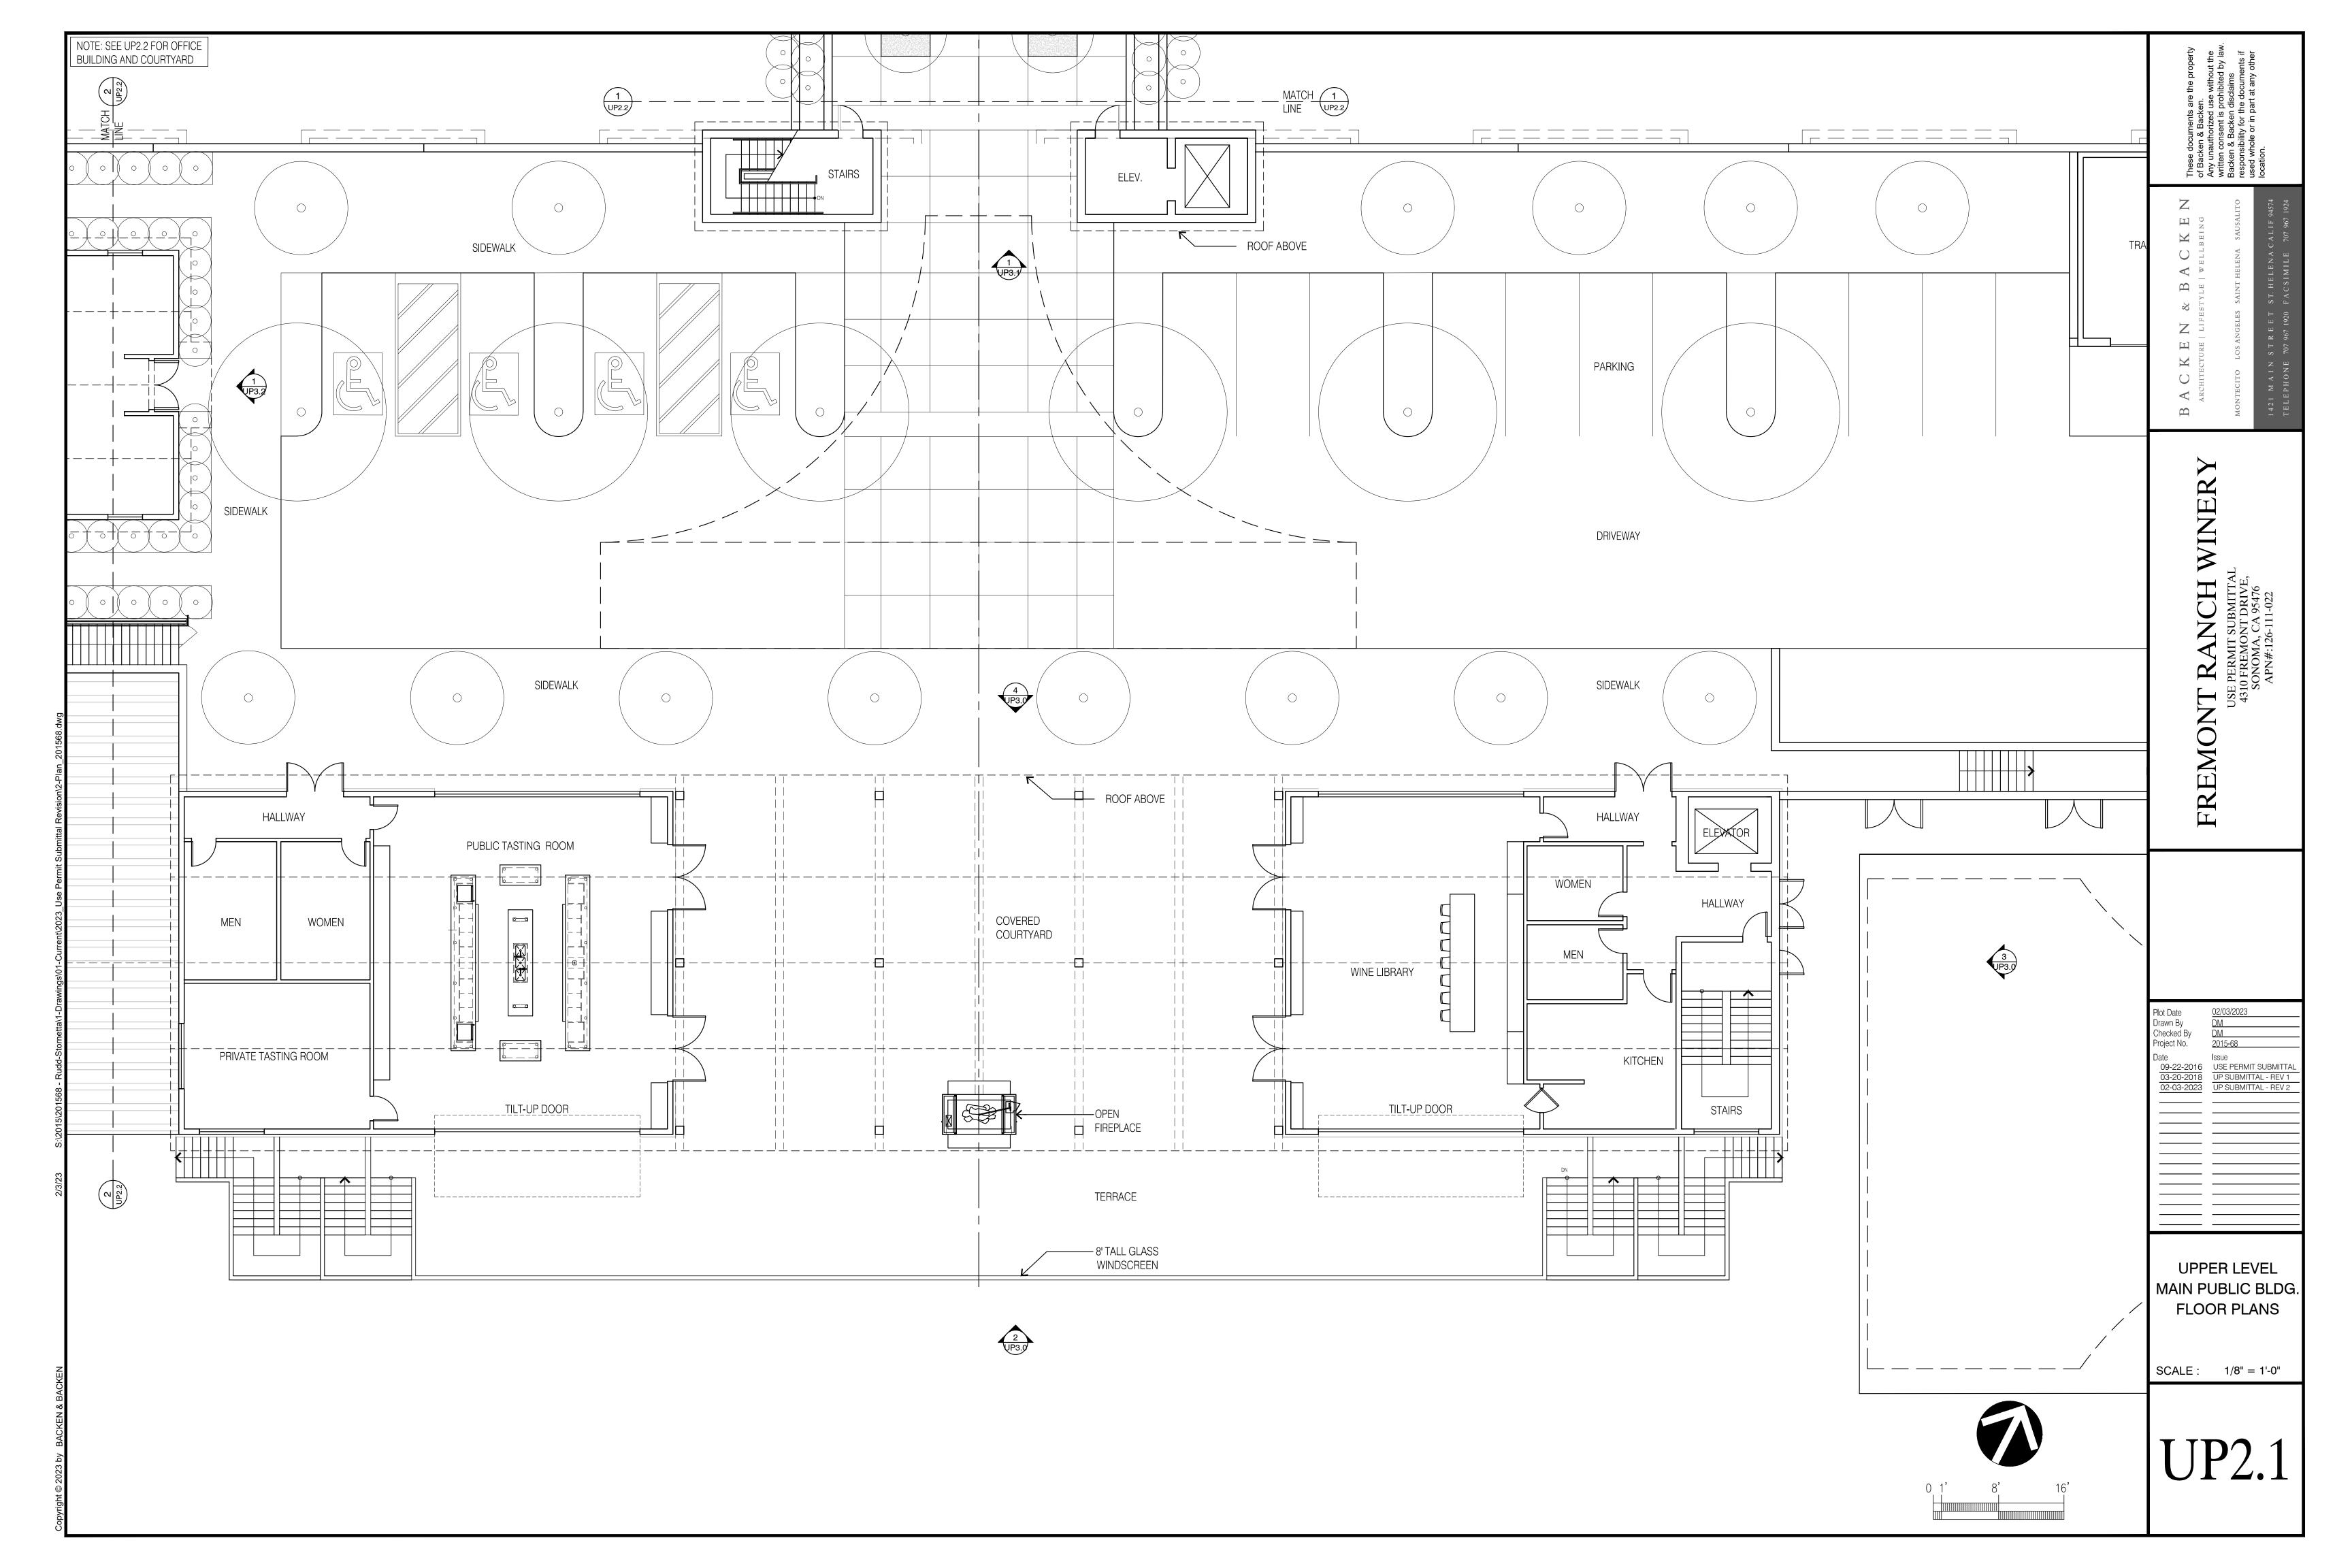

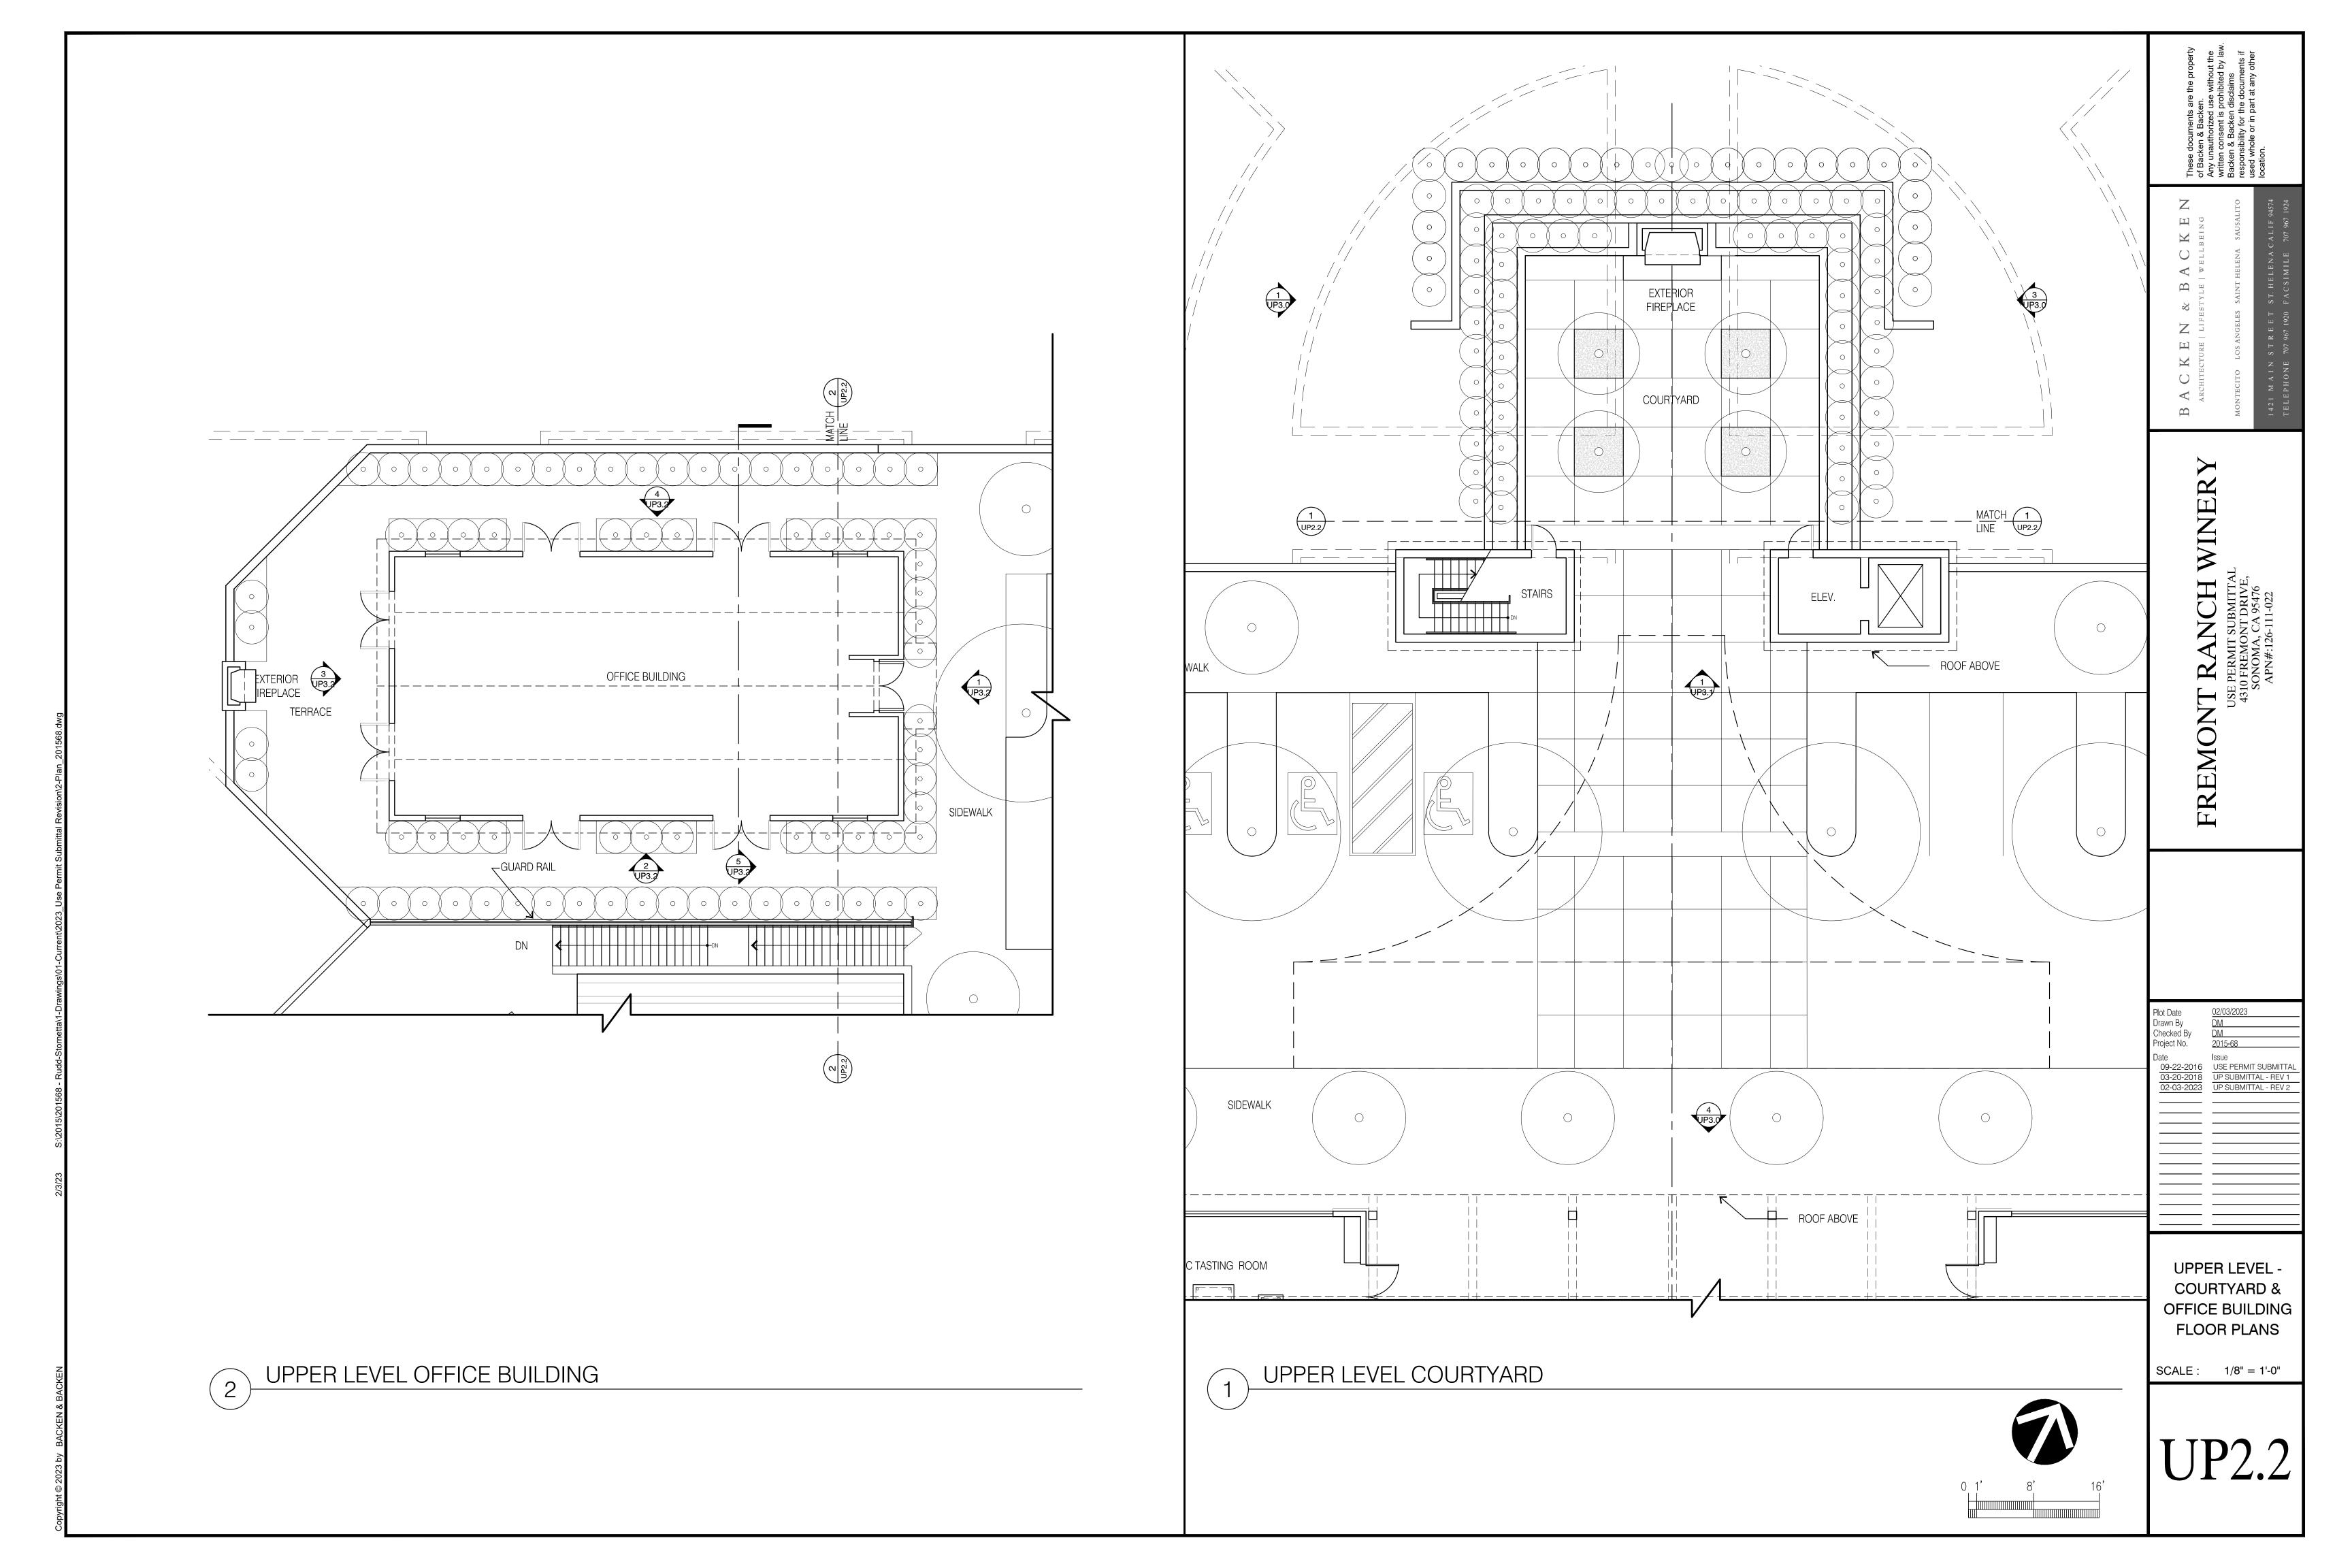

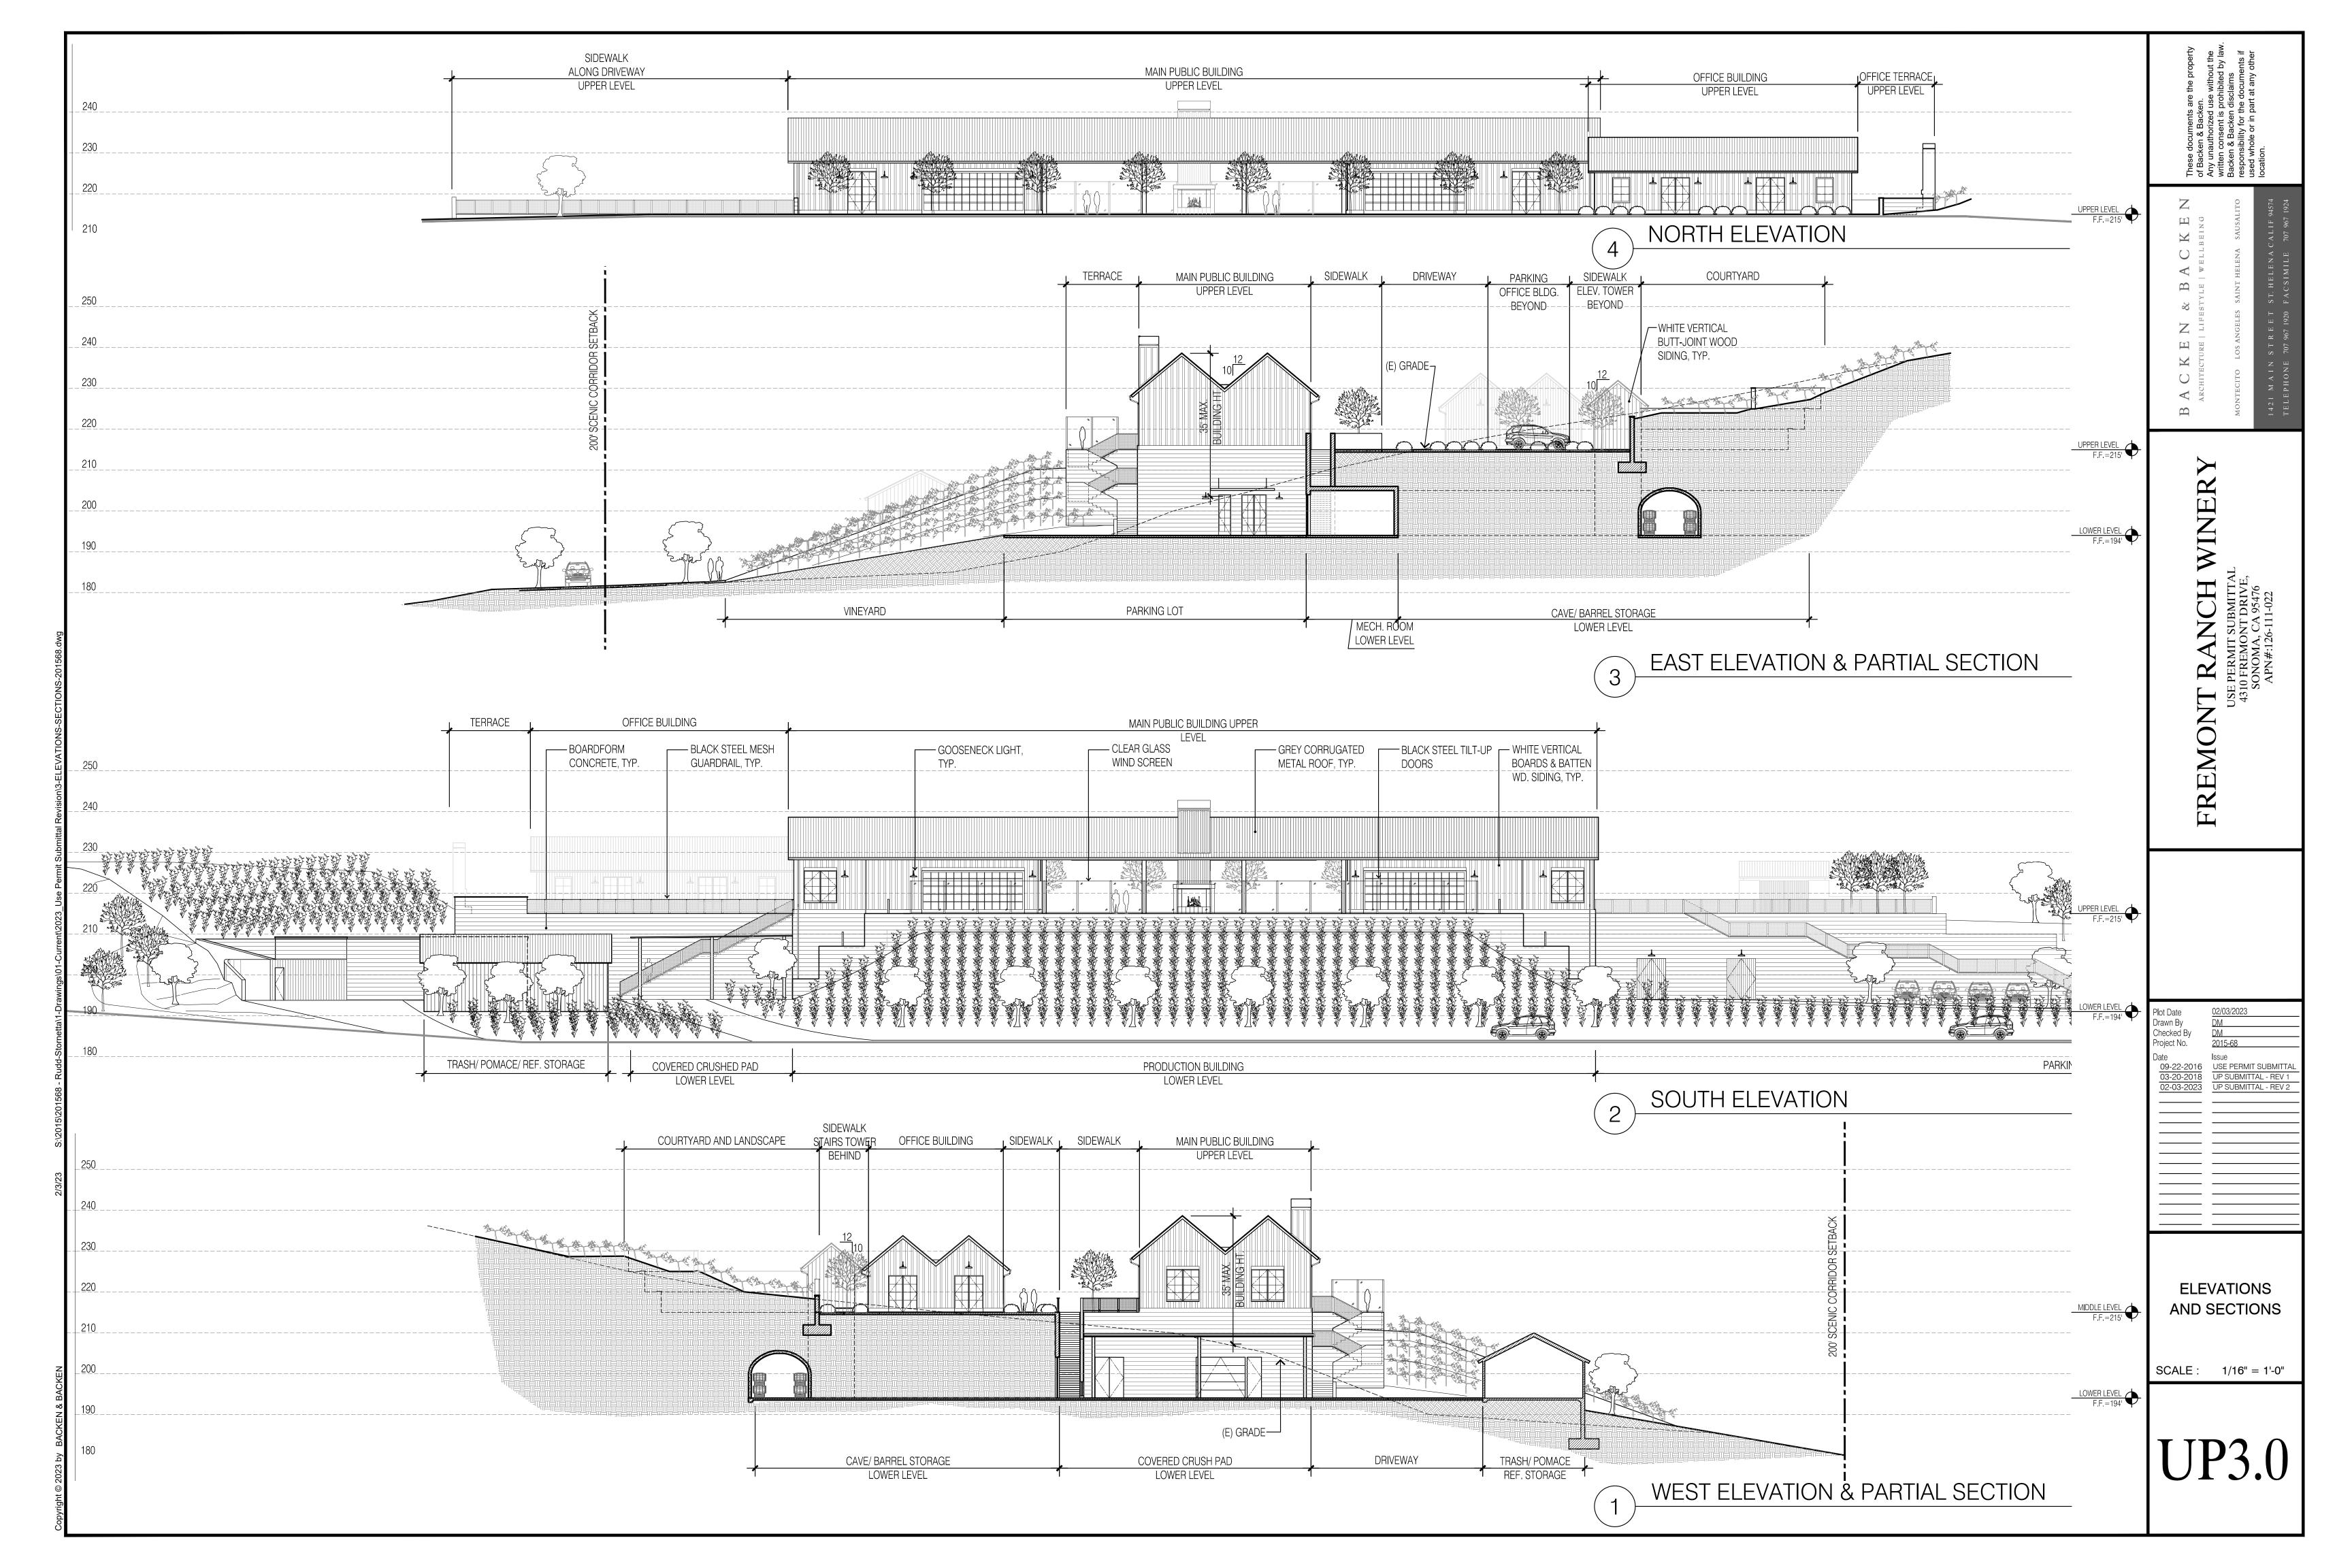

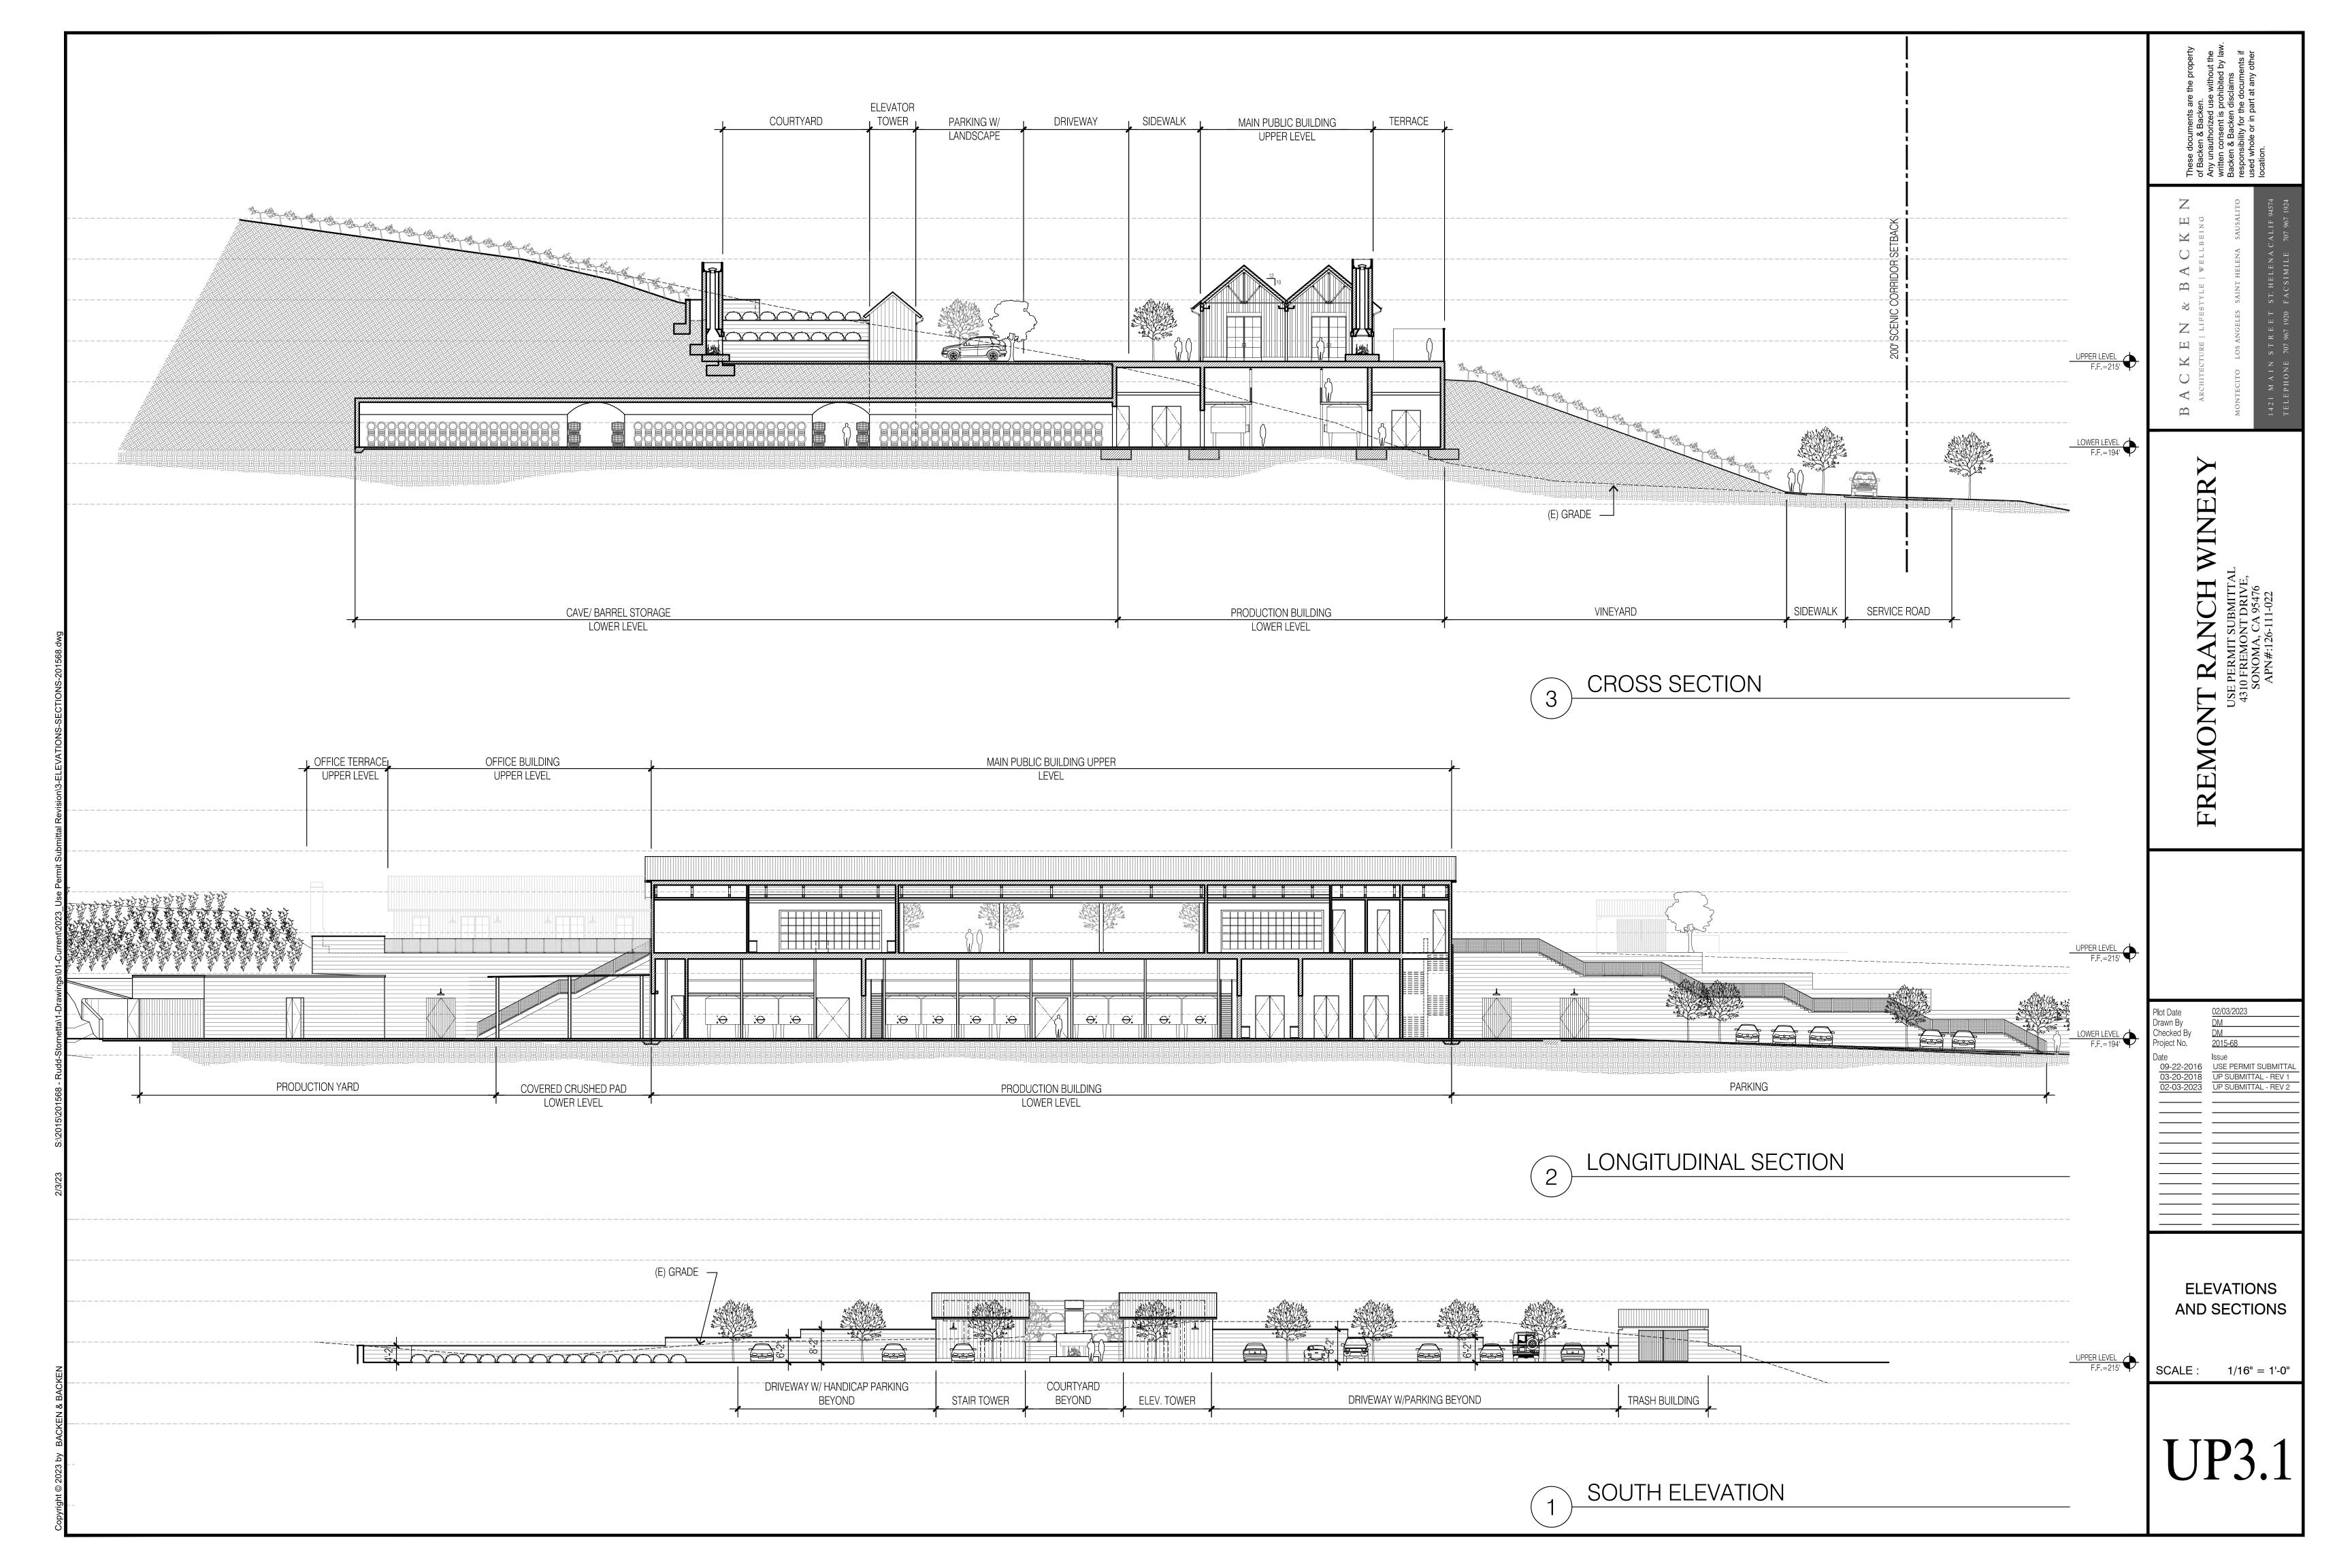

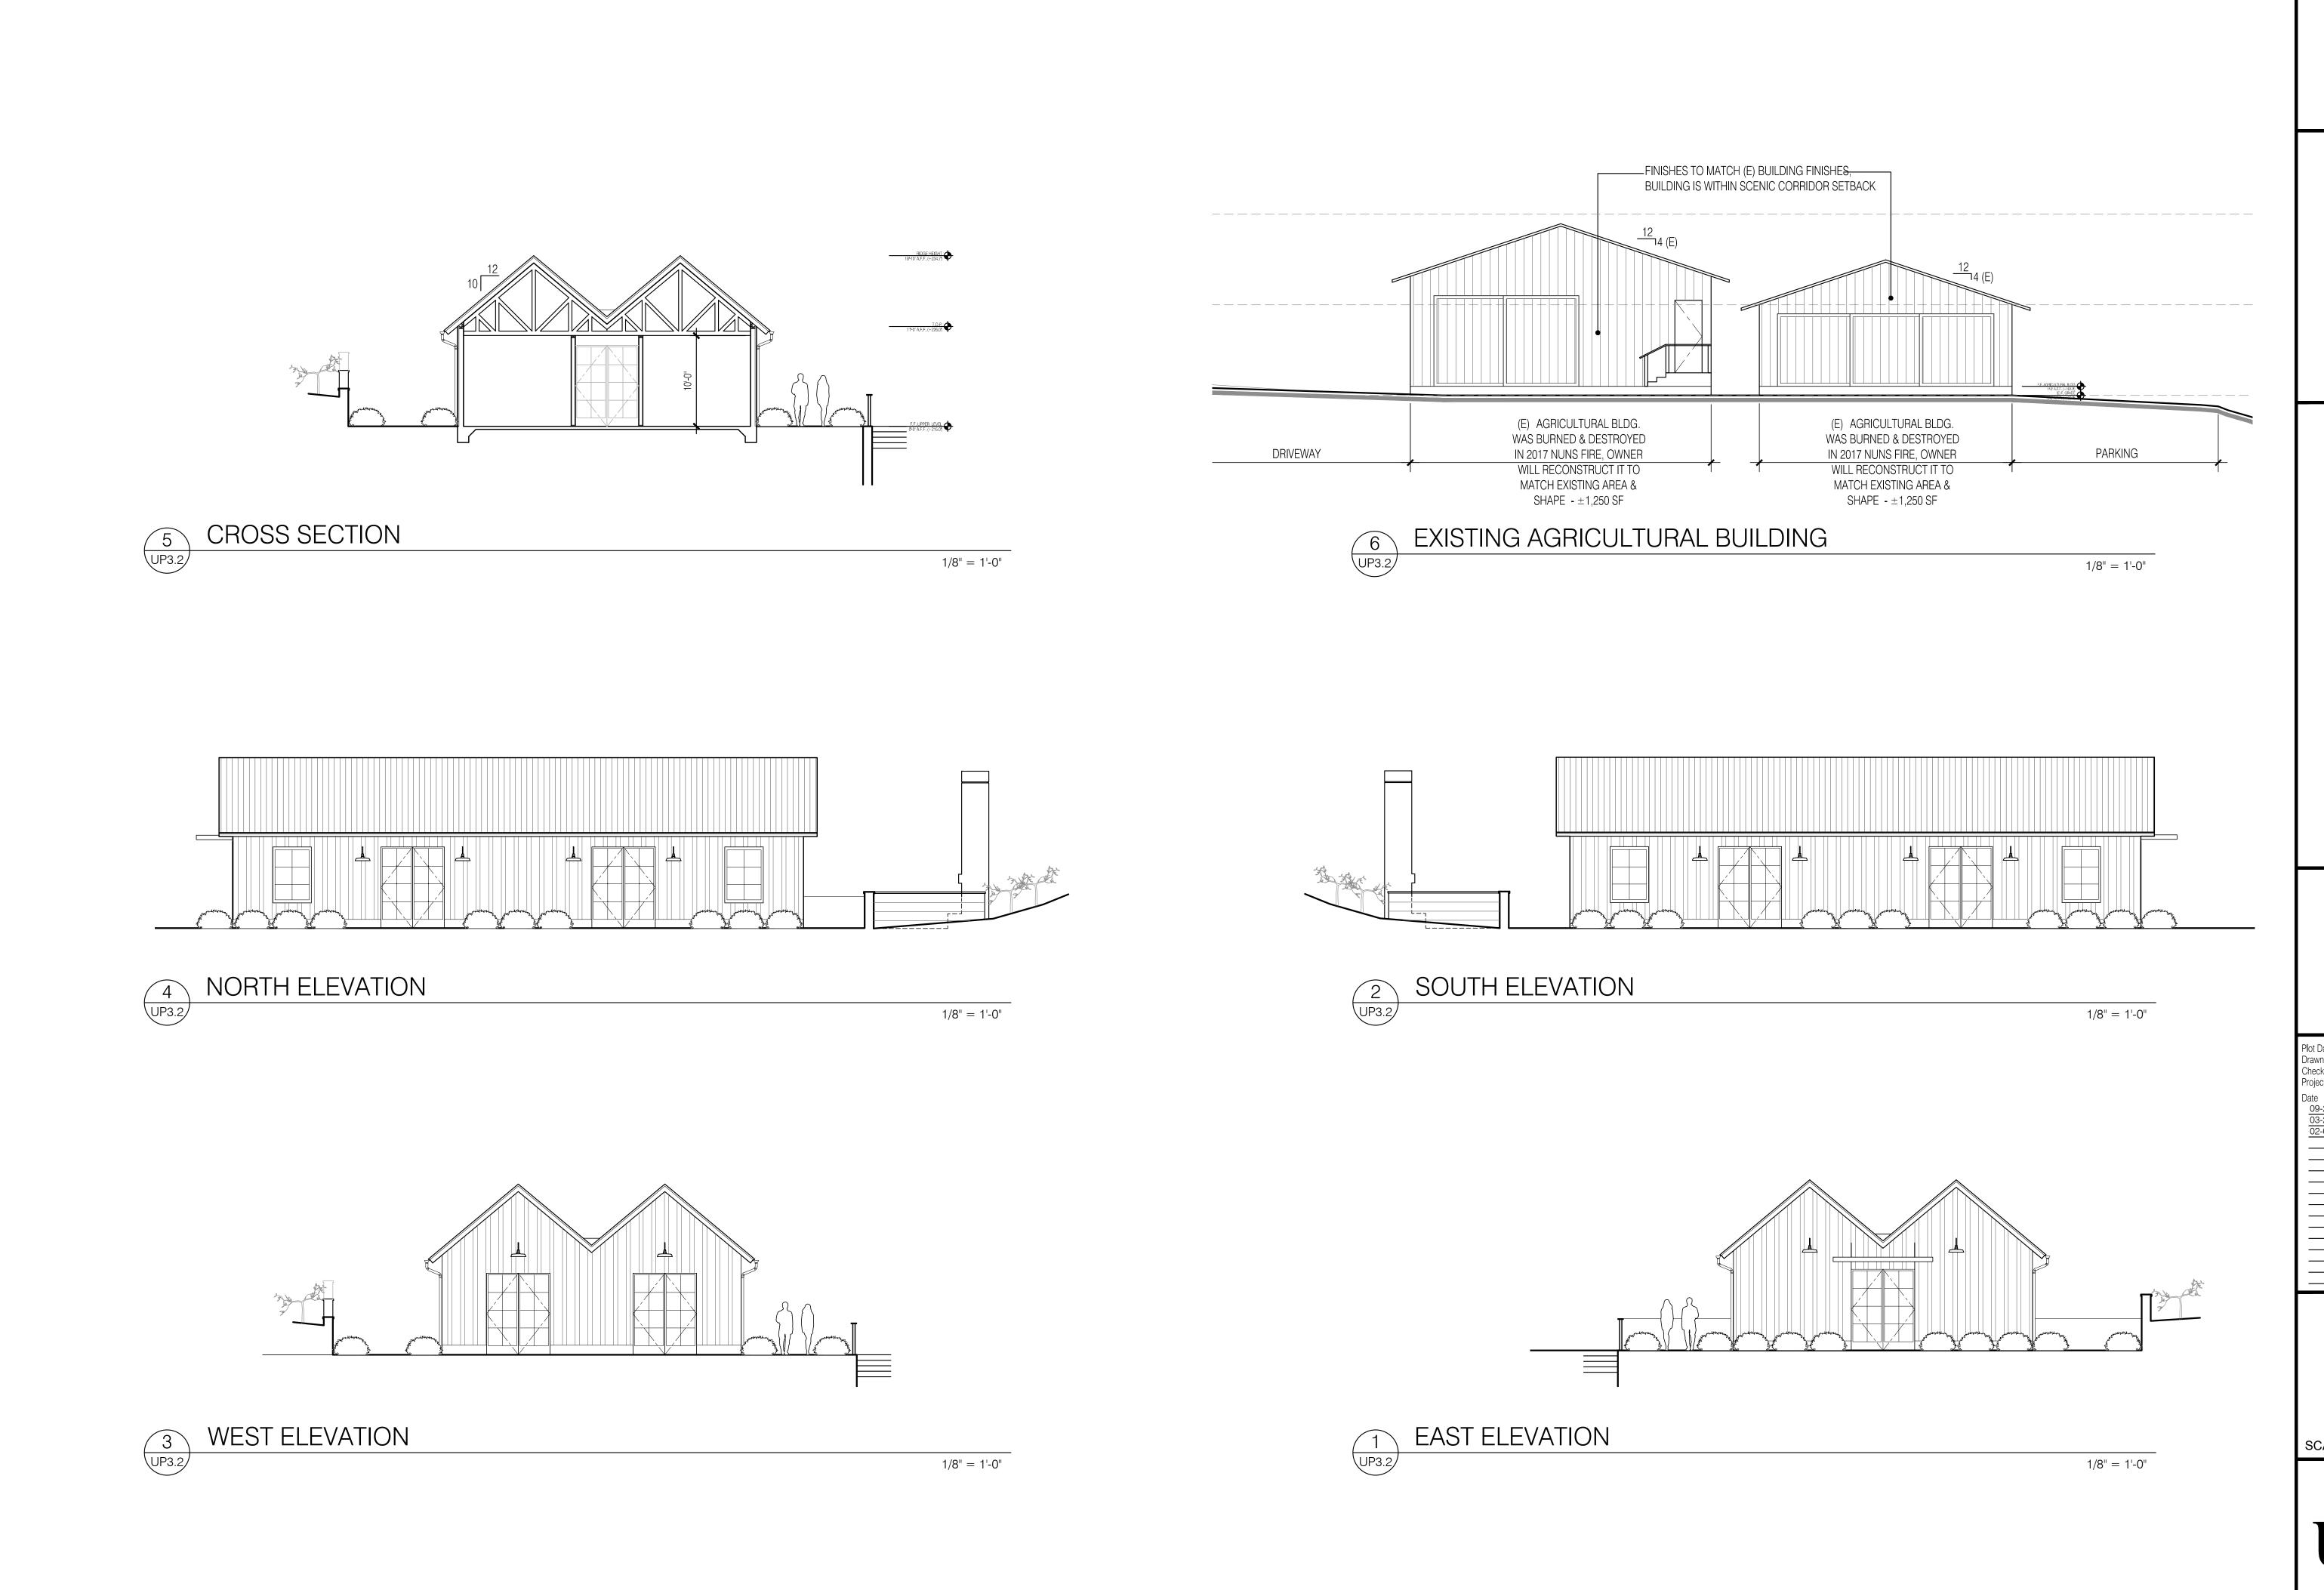

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ARCHITECTURE | LIFESTYLE | WELLBBING
MONTECITO LOS ANGELES SAINT HELENA SAUSALITO

NCH WINERY

FSUBMITTAL
ONT DRIVE,
A, CA 95476
26-111-022

FREMONT R
USE PEI

> UPPER LEVEL -OFFICE & AGRICULTURAL BUILDINGS

SCALE: 1/8" = 1'-0"

UP3.2

SCALE: 1/16" = 1'-0"



SOUTH ELEVATION









WHITE BOARDS AND BATTENS


VERTICAL BUTT JOINTED SIDING




TILT-UP DOORS





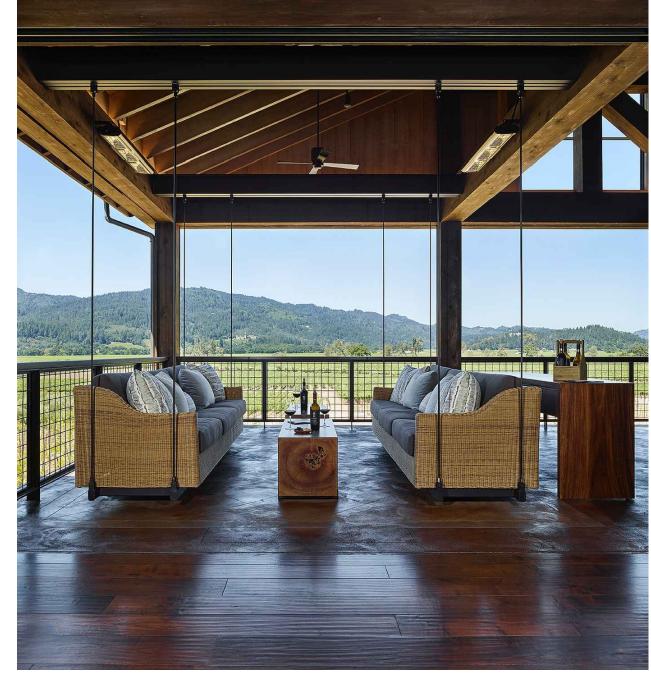

METAL MESH GUARD RAIL

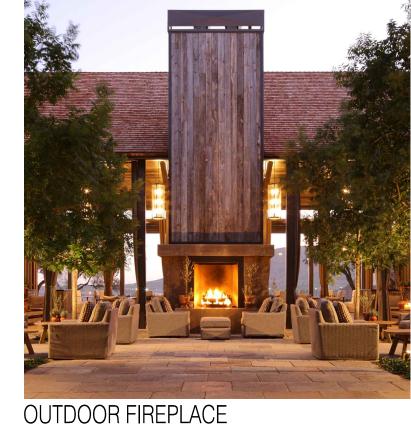




GOOSENECK LIGHT FIXTURE



DECOMPOSED GRANITE PATHWAY

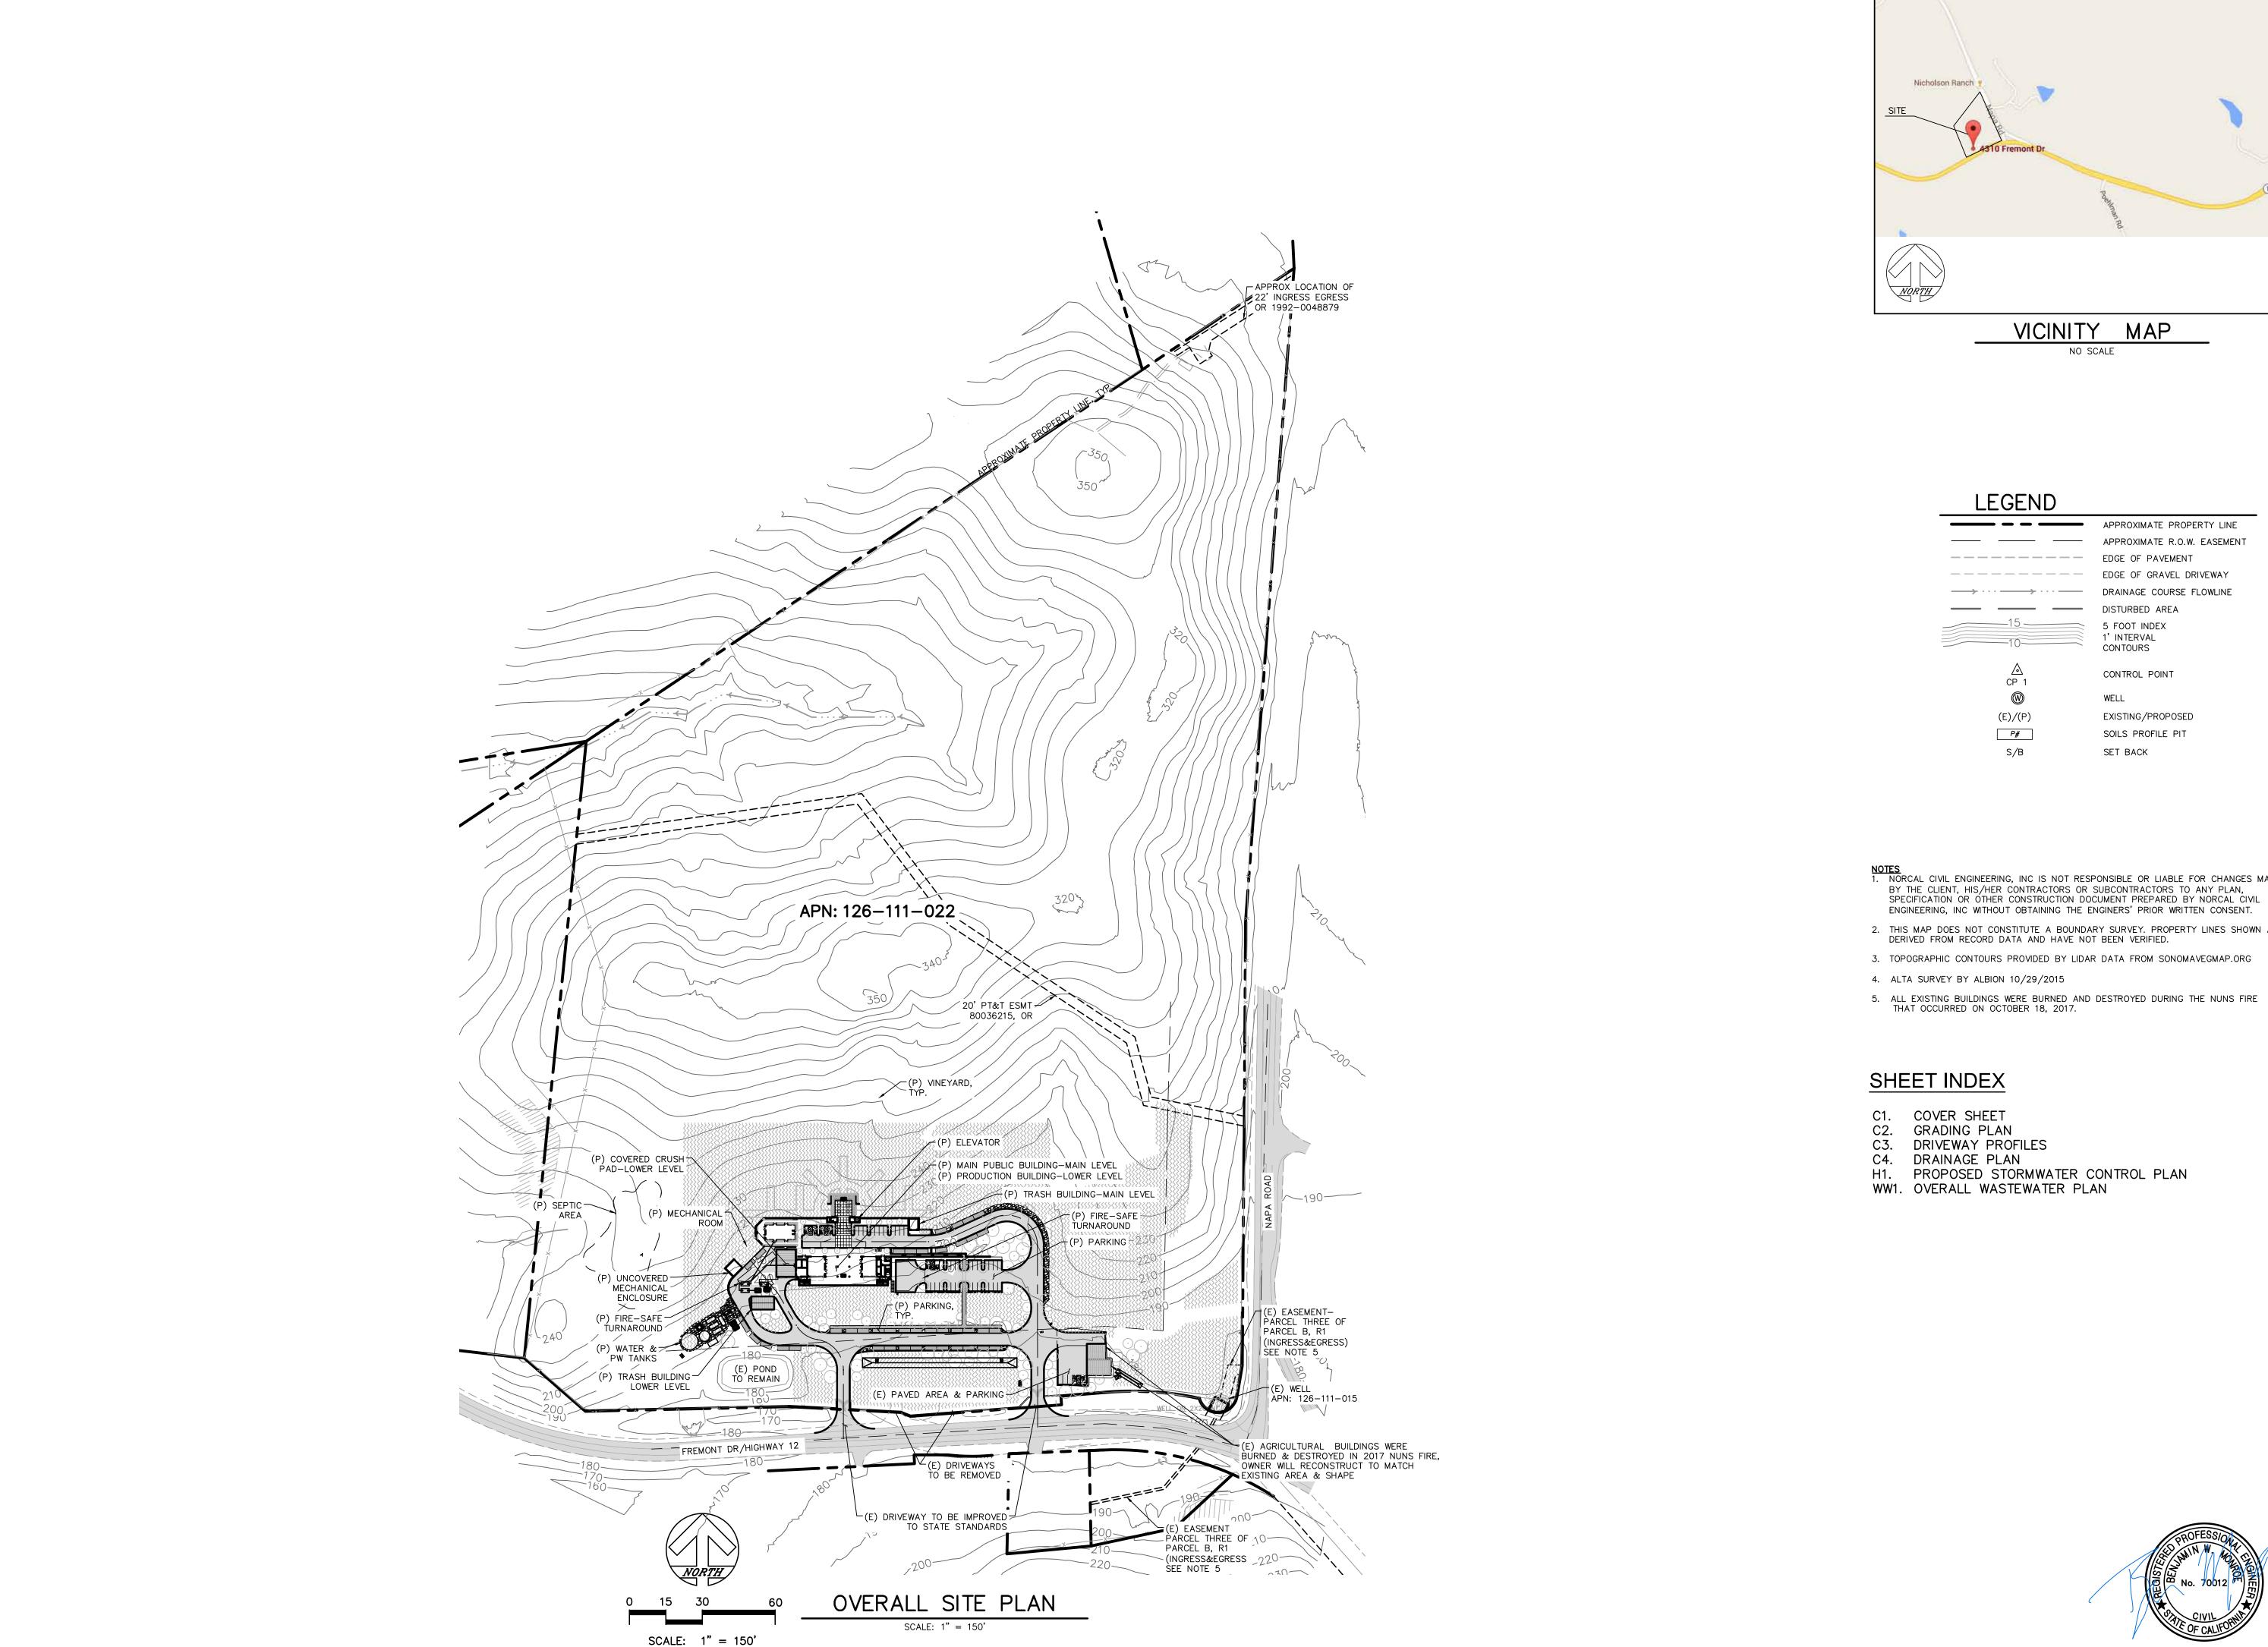



CONTROL POINT

EXISTING/PROPOSED SOILS PROFILE PIT

NOTES

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SPECIFICATION OR OTHER CONSTRUCTION DOCUMENT PREPARED BY NORCAL CIVIL

- 2. THIS MAP DOES NOT CONSTITUTE A BOUNDARY SURVEY. PROPERTY LINES SHOWN ARE
- 3. TOPOGRAPHIC CONTOURS PROVIDED BY LIDAR DATA FROM SONOMAVEGMAP.ORG



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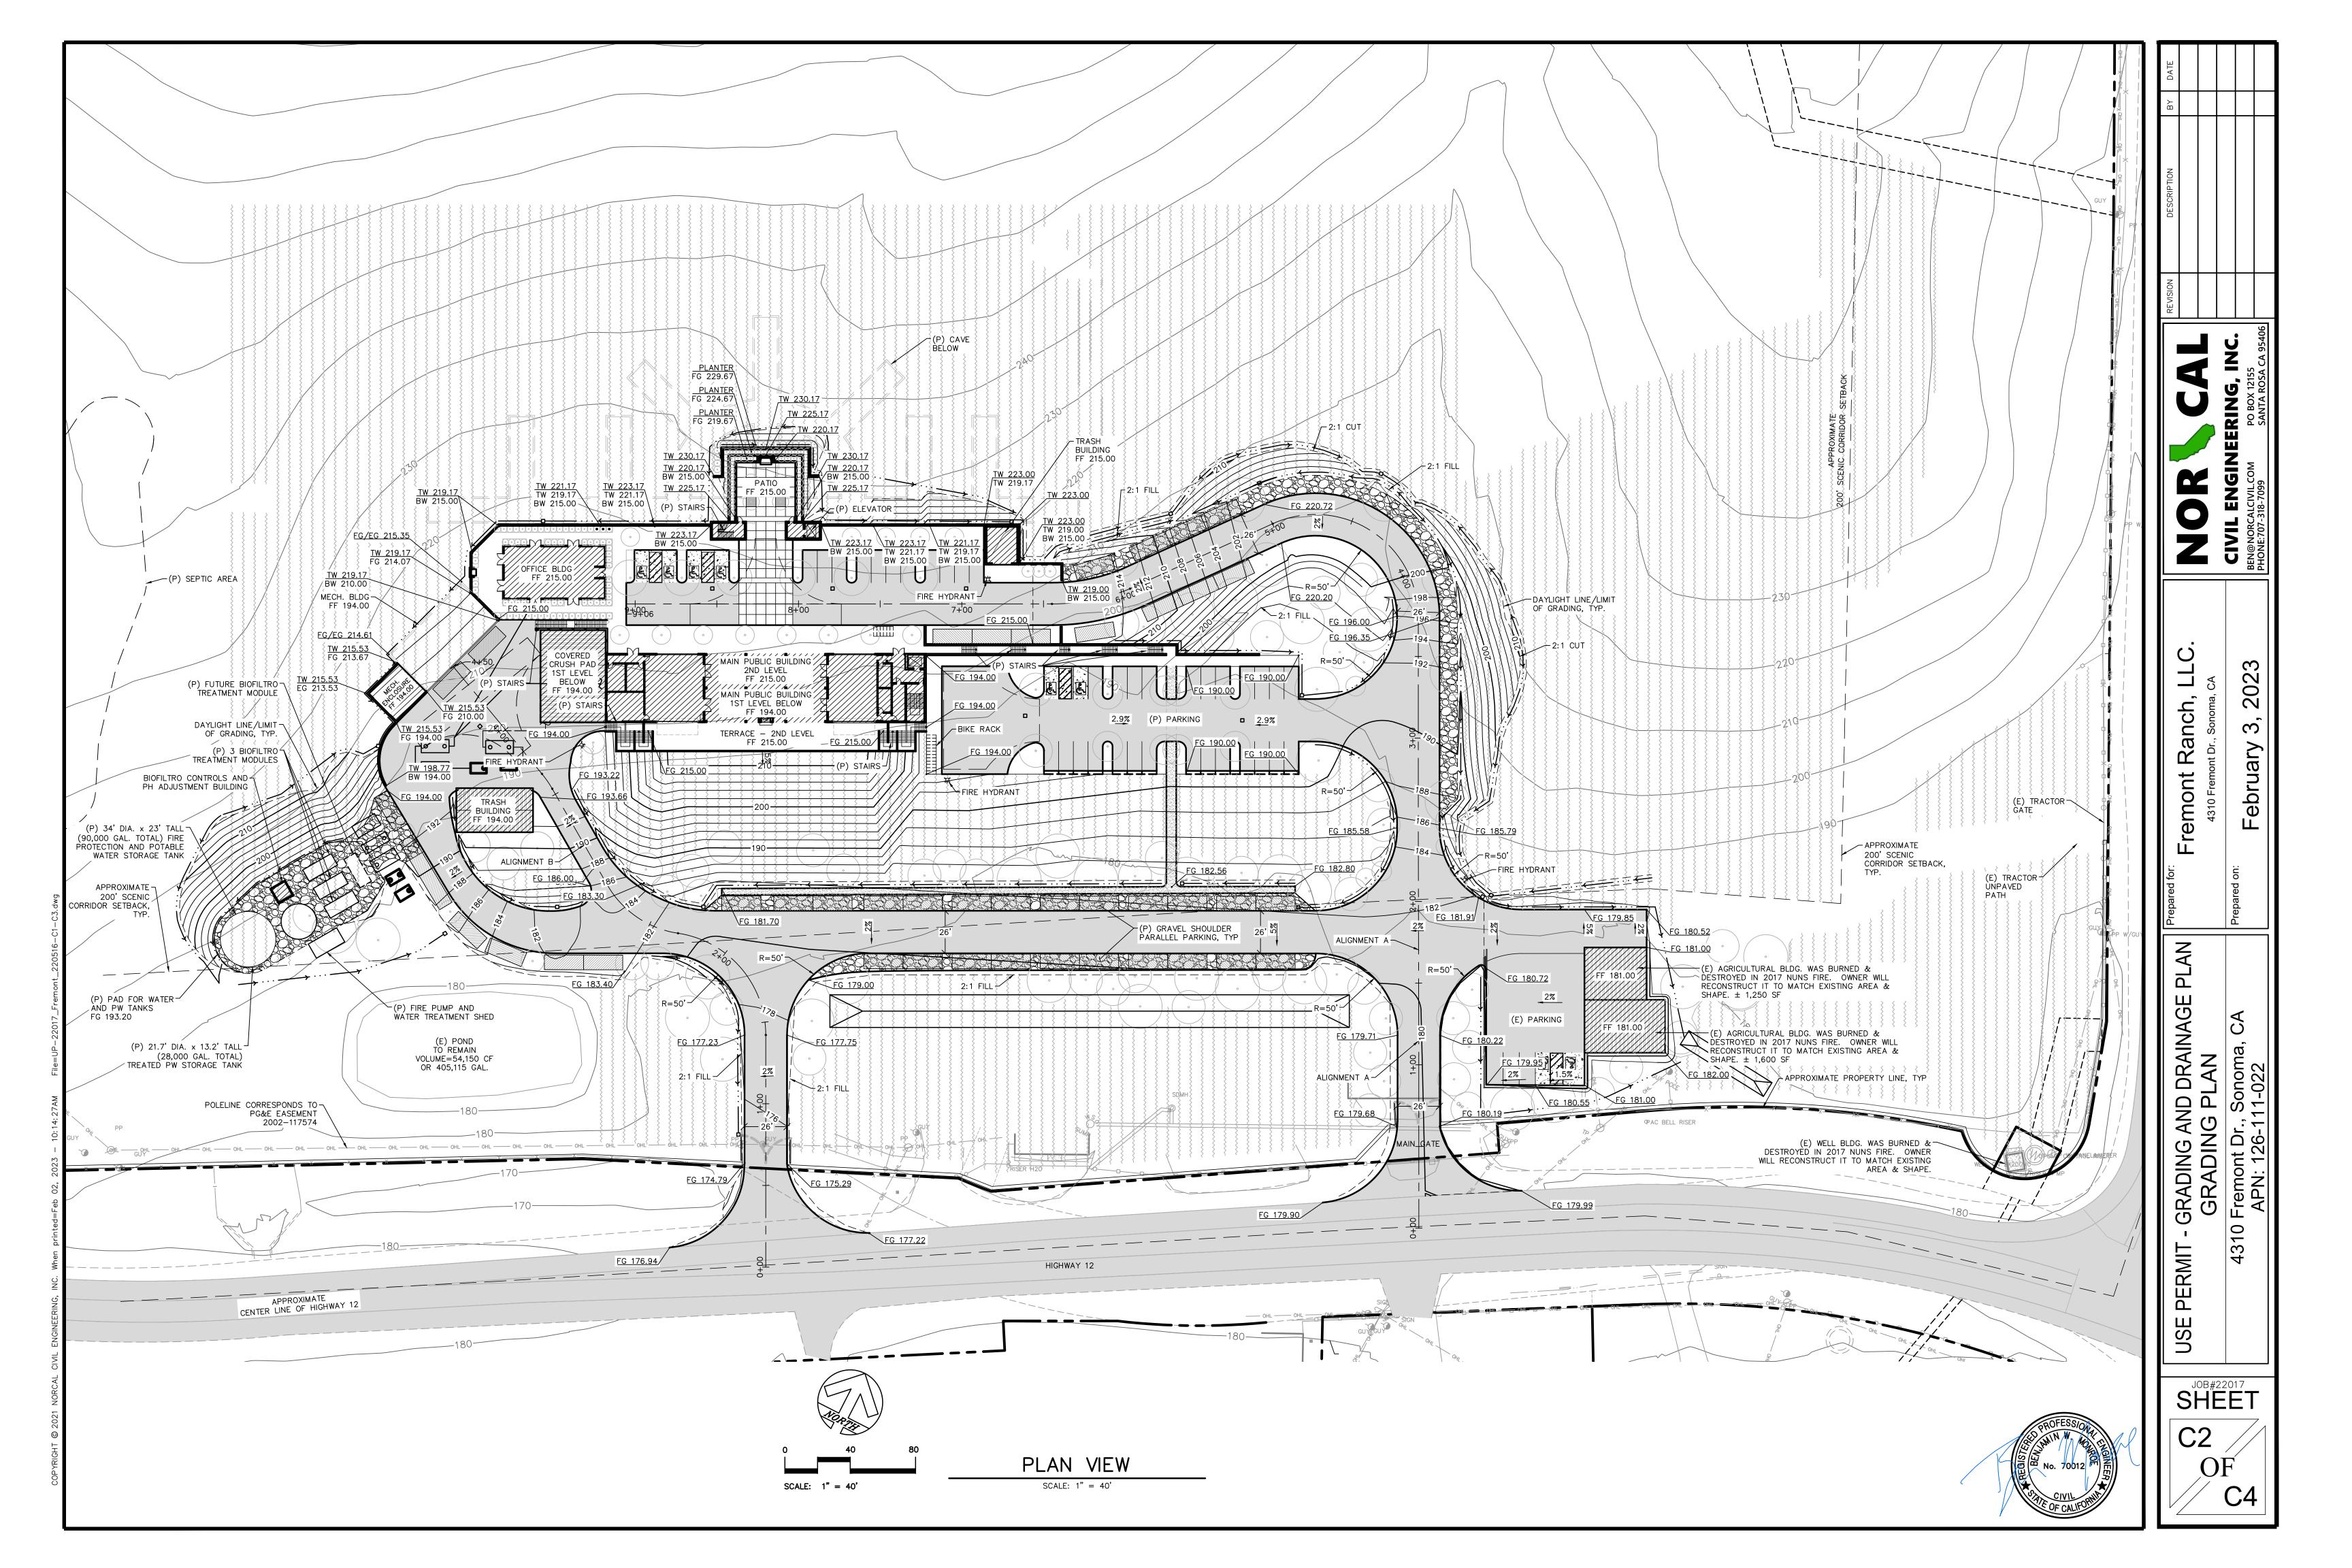
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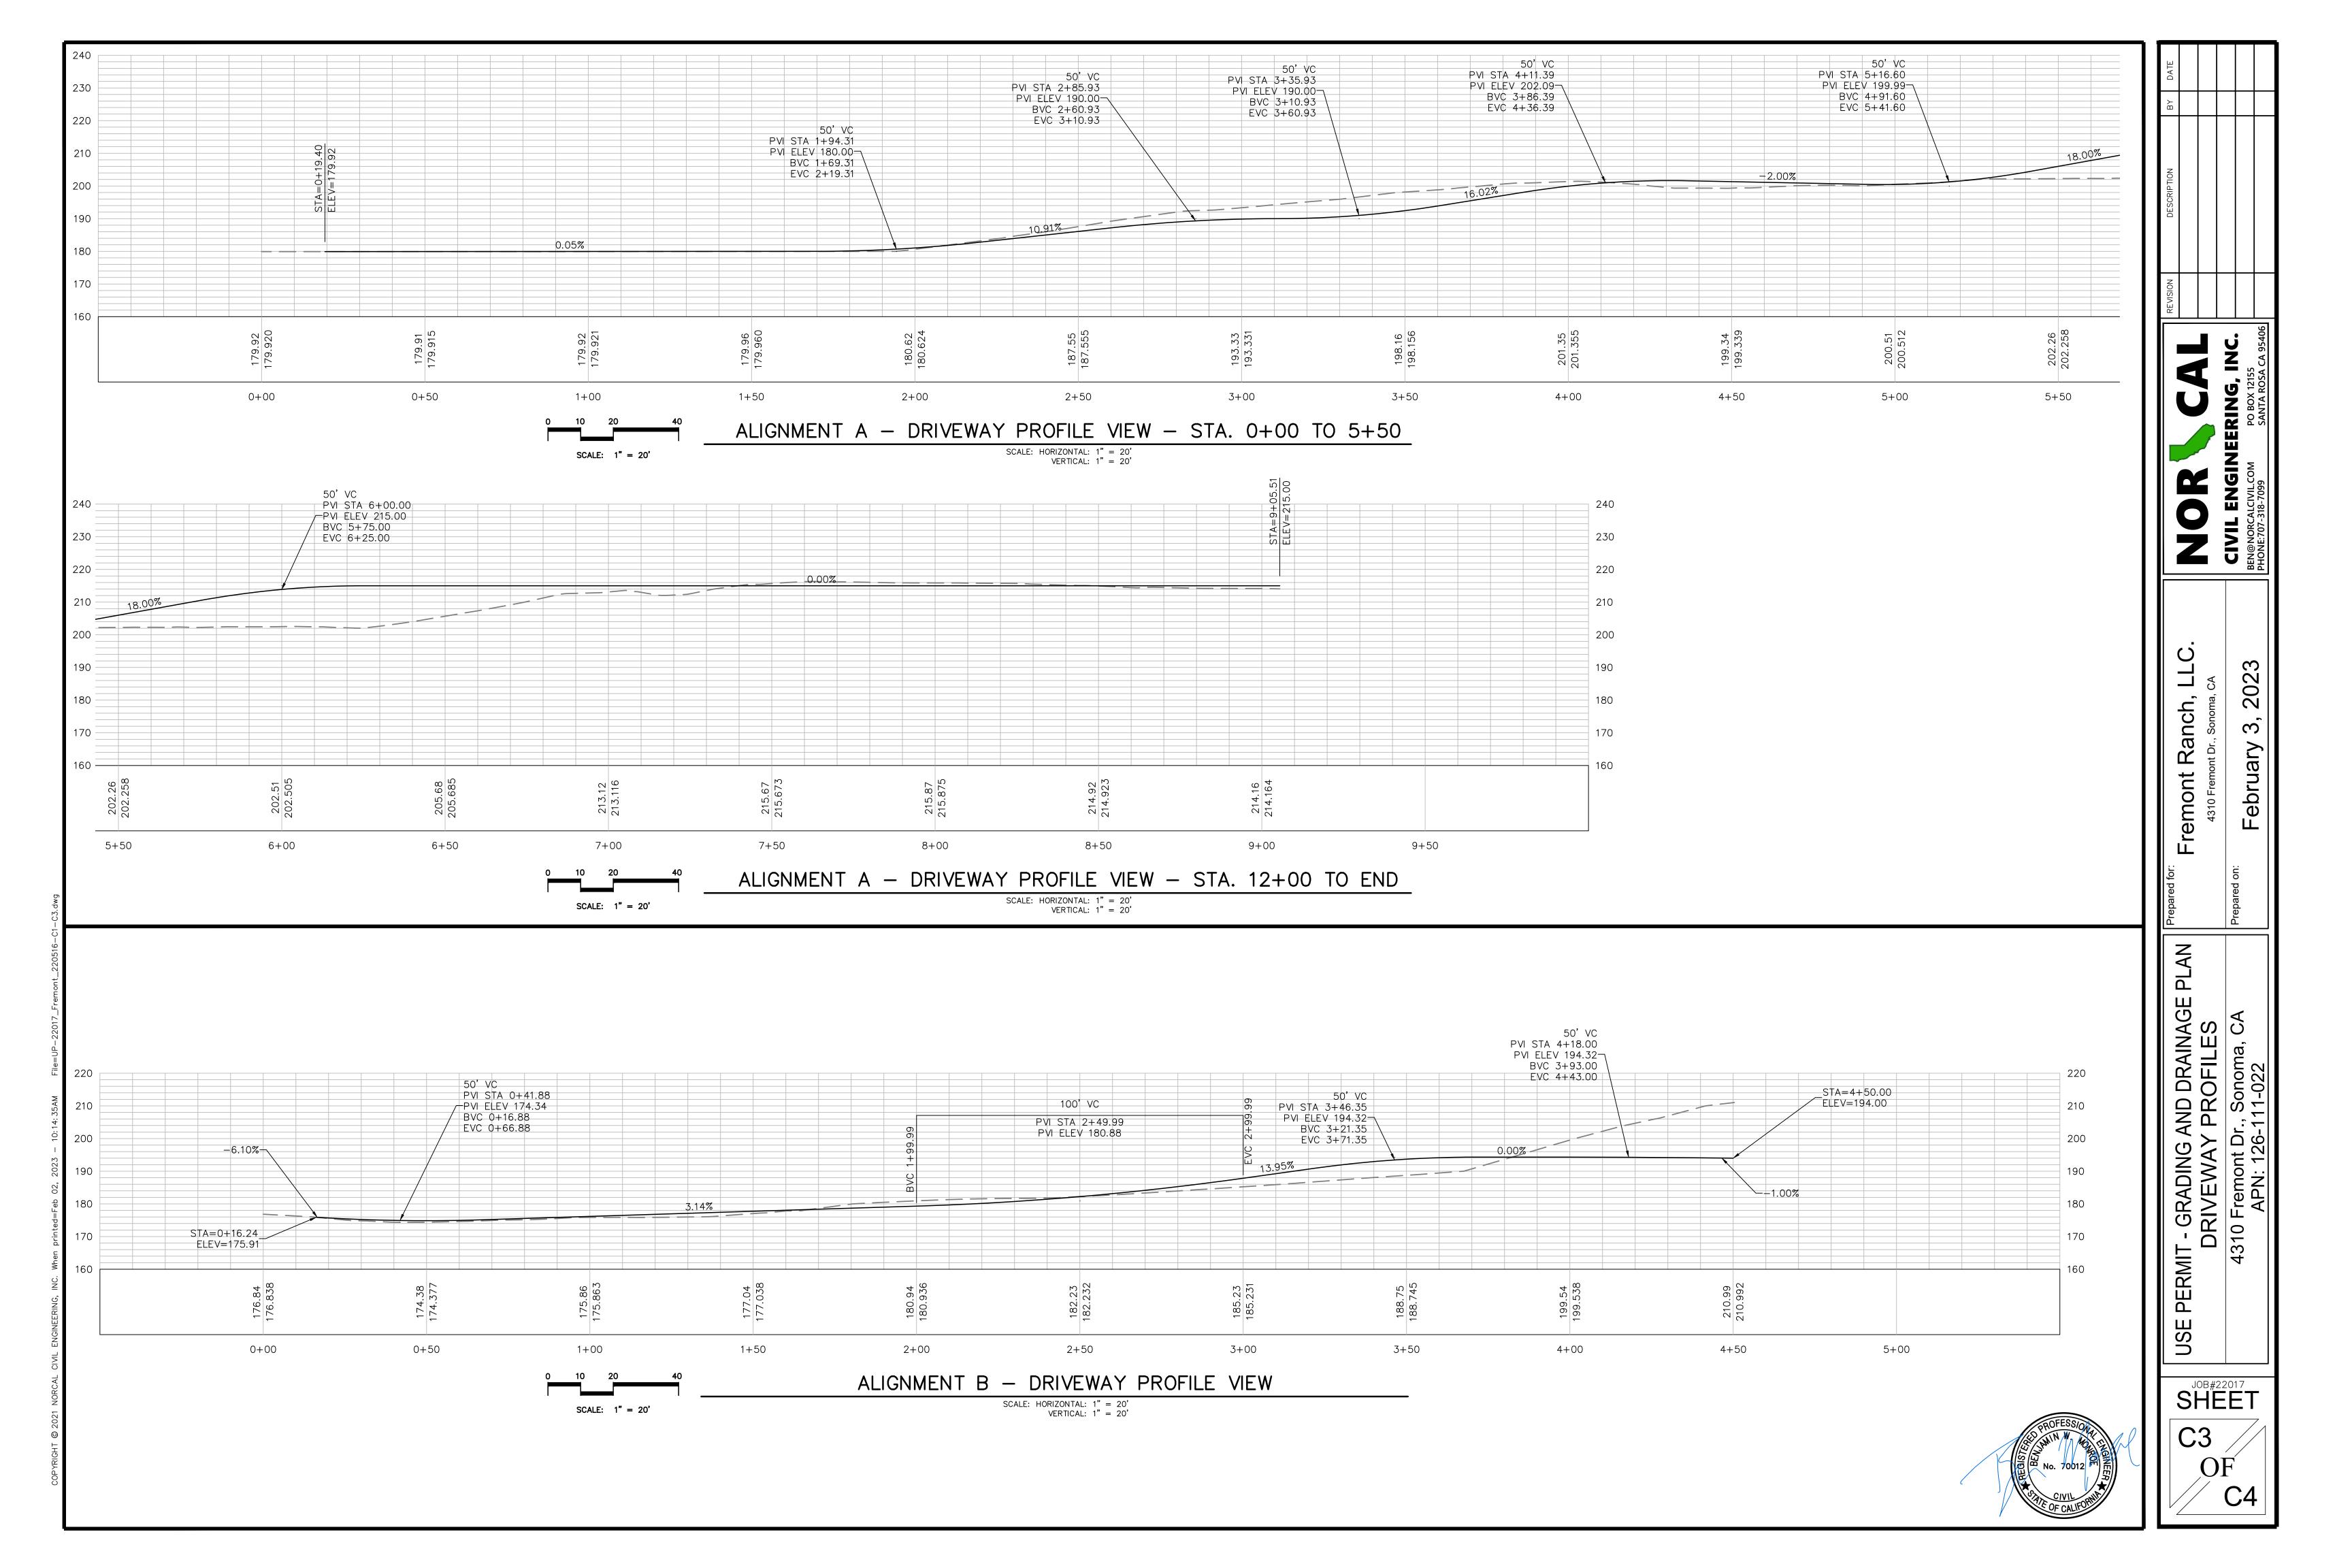
ebruary


Ranch,

rer

JOB#22017 SHEET






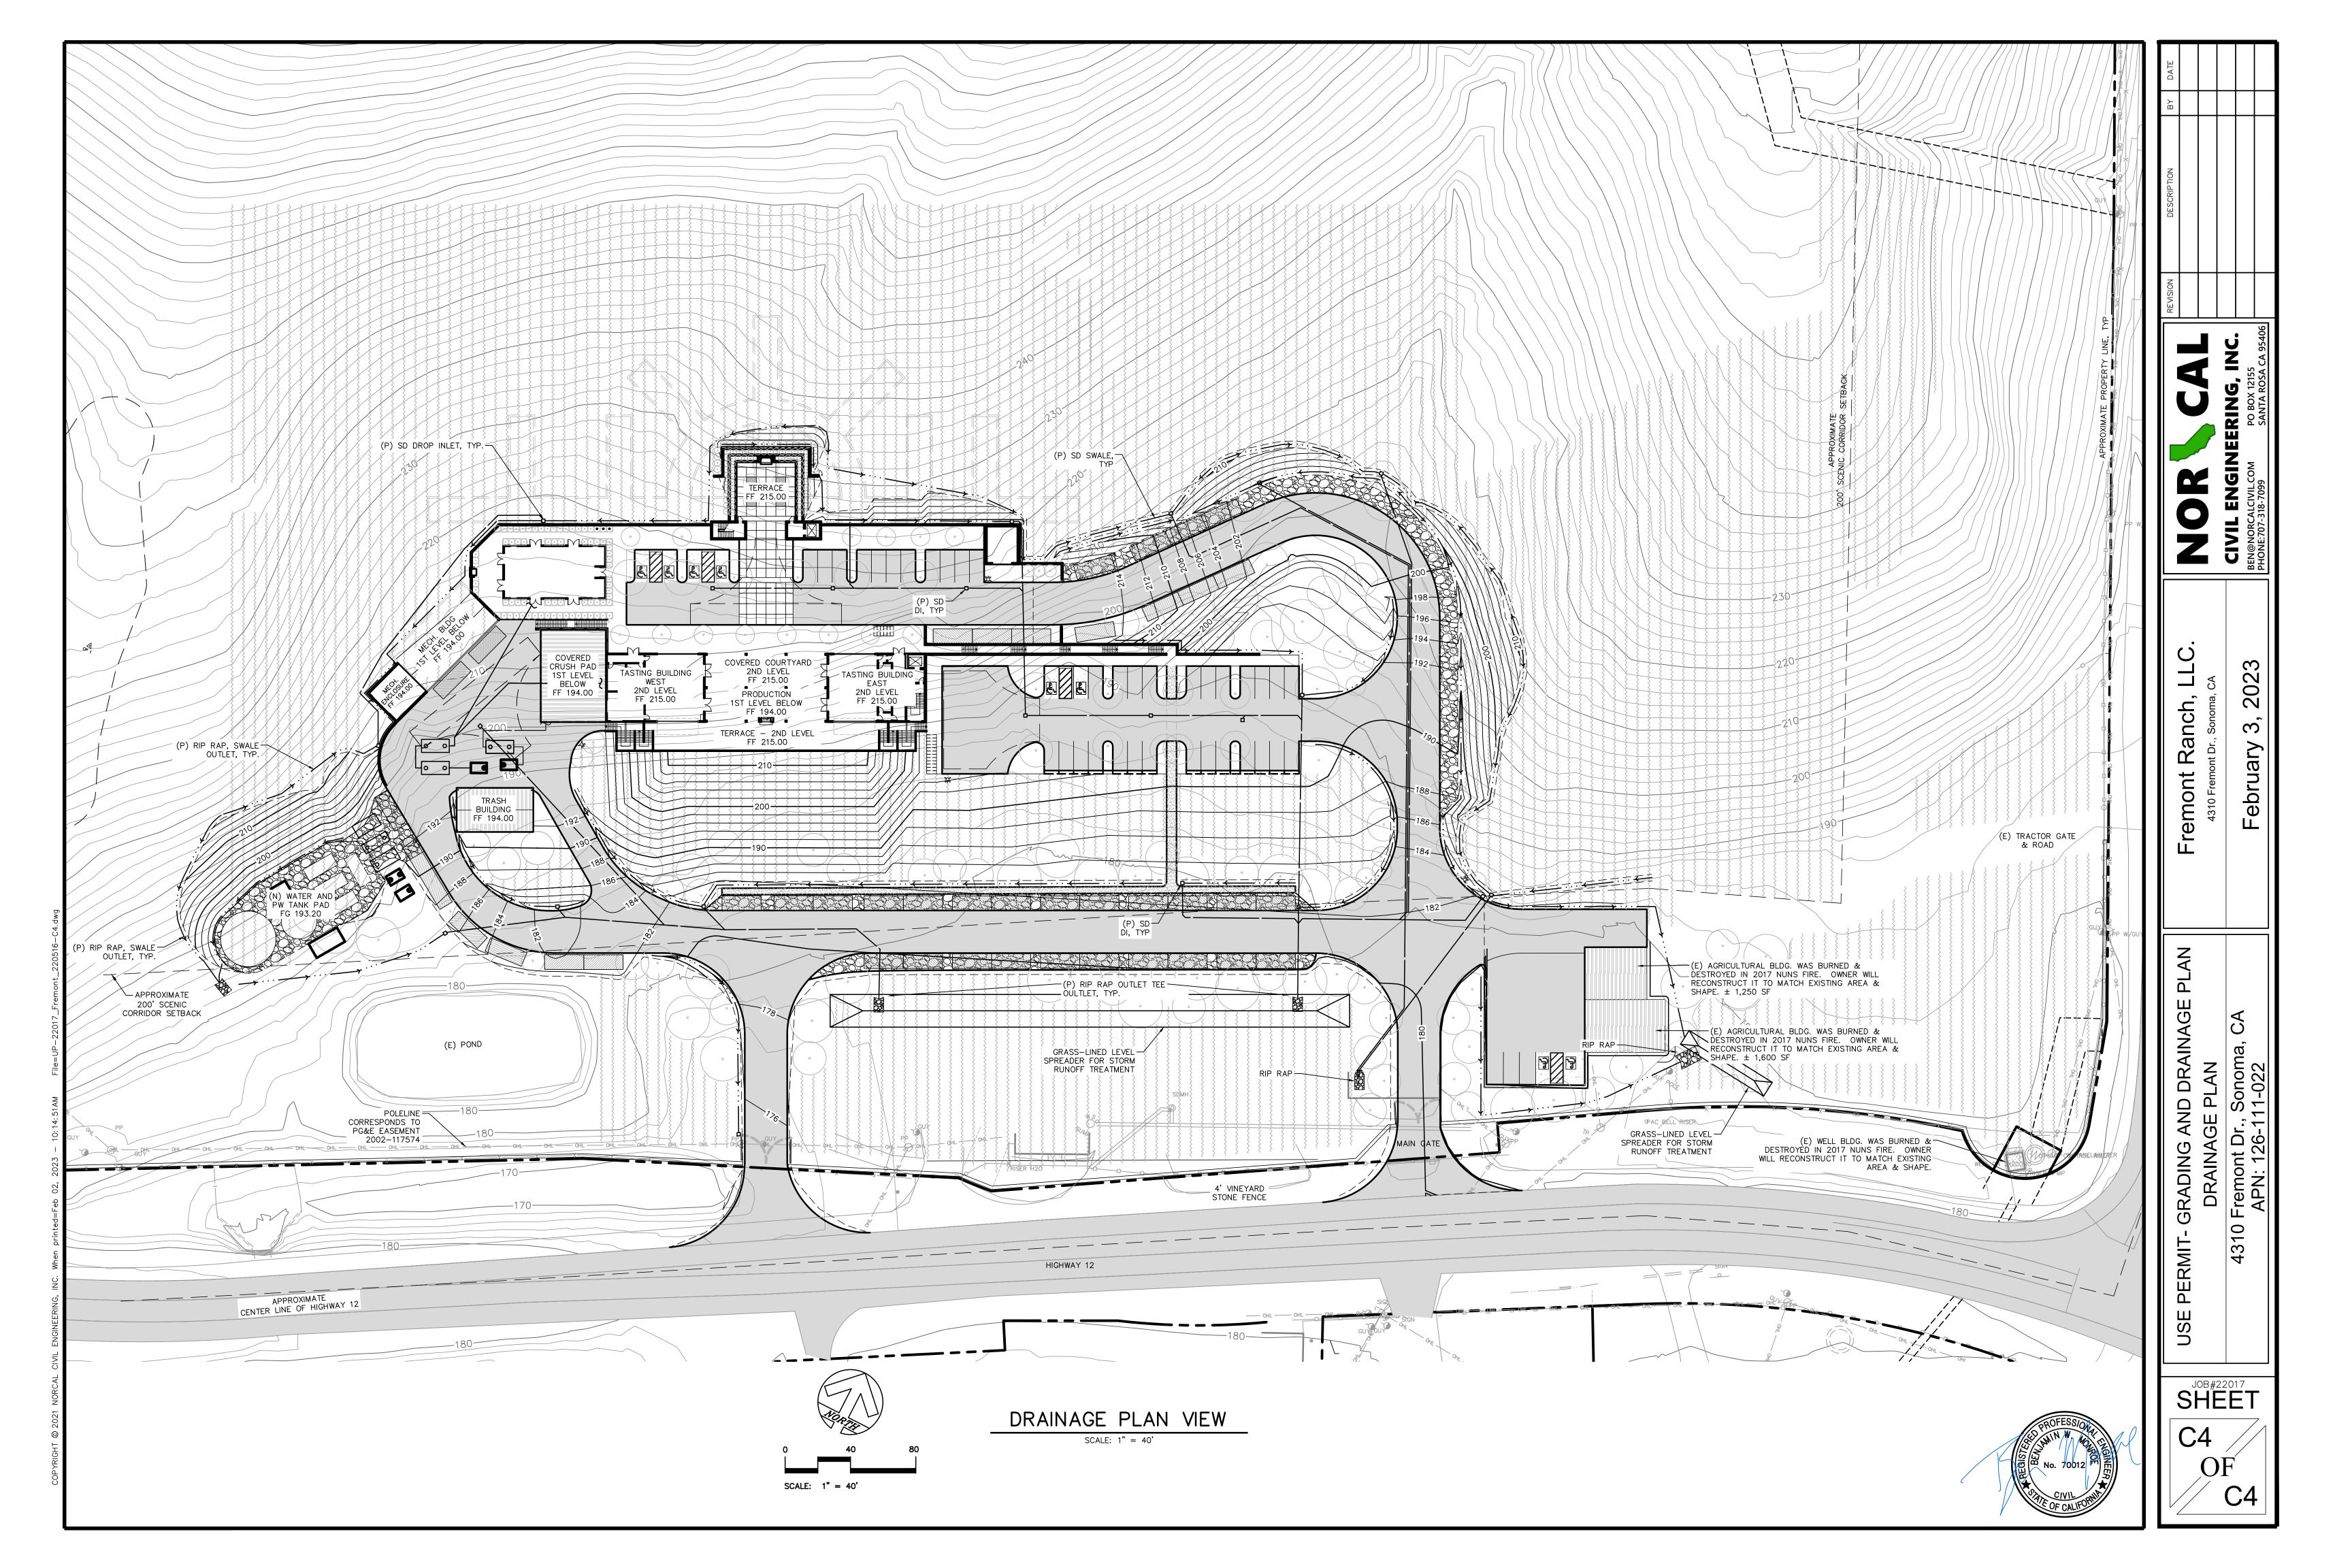


FREMONT RANCH WINERY LEGEND USE PERMIT - WASTE WATER PLAN 4310 Fremont Dr., Sonoma, CA 95476 VICINITY MAP APN: 126-111-022 PROCESS WASTE 50' S/B FL TO SEPTIC AREA 3,000 GAL SS RECIRC TANK ADJUSTMENT BUILDING AGRICULTURAL BUILDINGS BURNED DESTROYED IN 2017 NUNS FIRE. BE RECONSTRUCTED TO MATC EXISTING AREA & SHAP (P) 34' DIA. x 23' TALL (90,000 -GAL. TOTAL) FIRE PROTECTION AND POTABLE WATER STORAGE SUBSURFACE DRIP IRRIGATION / AREA=25,078 SF SS PUMP (P) FIRE PUMP AND WATER TRÉATMENT SHED 100' S/B \Rightarrow POND TO SEPTIC AREA PERMIT (P) 21.7' DIA. x 13.2' TALL (28,000 -GAL. TOTAL) TREATED PW STORAGE FREMONT/HIGHWAY 12 JOB#22017 SHEET OWNER/APPLICANT Fremont Ranch, LLC 68 Combs St., Suite D-10 NOTES 1. NORCAL CIVIL ENGINEERING, INC IS NOT RESPONSIBLE OR LIABLE FOR CHANGES MADE BY THE CLIENT, OR LIABLE FOR CHANGES OF SURCONTRACTORS TO AN WASTEWATER PLAN Napa, CA 94559 HIS/HER CONTRACTORS OR SUBCONTRACTORS TO ANY PLÁN, SPECIFICATION OR OTHER CONSTRUCTION DOCUMENT PREPARED BY NORCAL CIVIL ENGINEERING, CIVIL ENGINEER NORCAL CIVIL ENGINEERING INC. PO BOX 12155 SANTA OF SANTA O INC WITHOUT OBTAINING THE ENGINERS' PRIOR WRITTEN 2. THIS MAP DOES NOT CONSTITUTE A BOUNDARY SURVEY. SCALE: 1" = 40'CONTACT: BÉN MONROE PROPERTY LINES SHOWN ARE DERIVED FROM RECORD

PH. (707) 542-8795

DATA AND HAVE NOT BEEN VERIFIED.

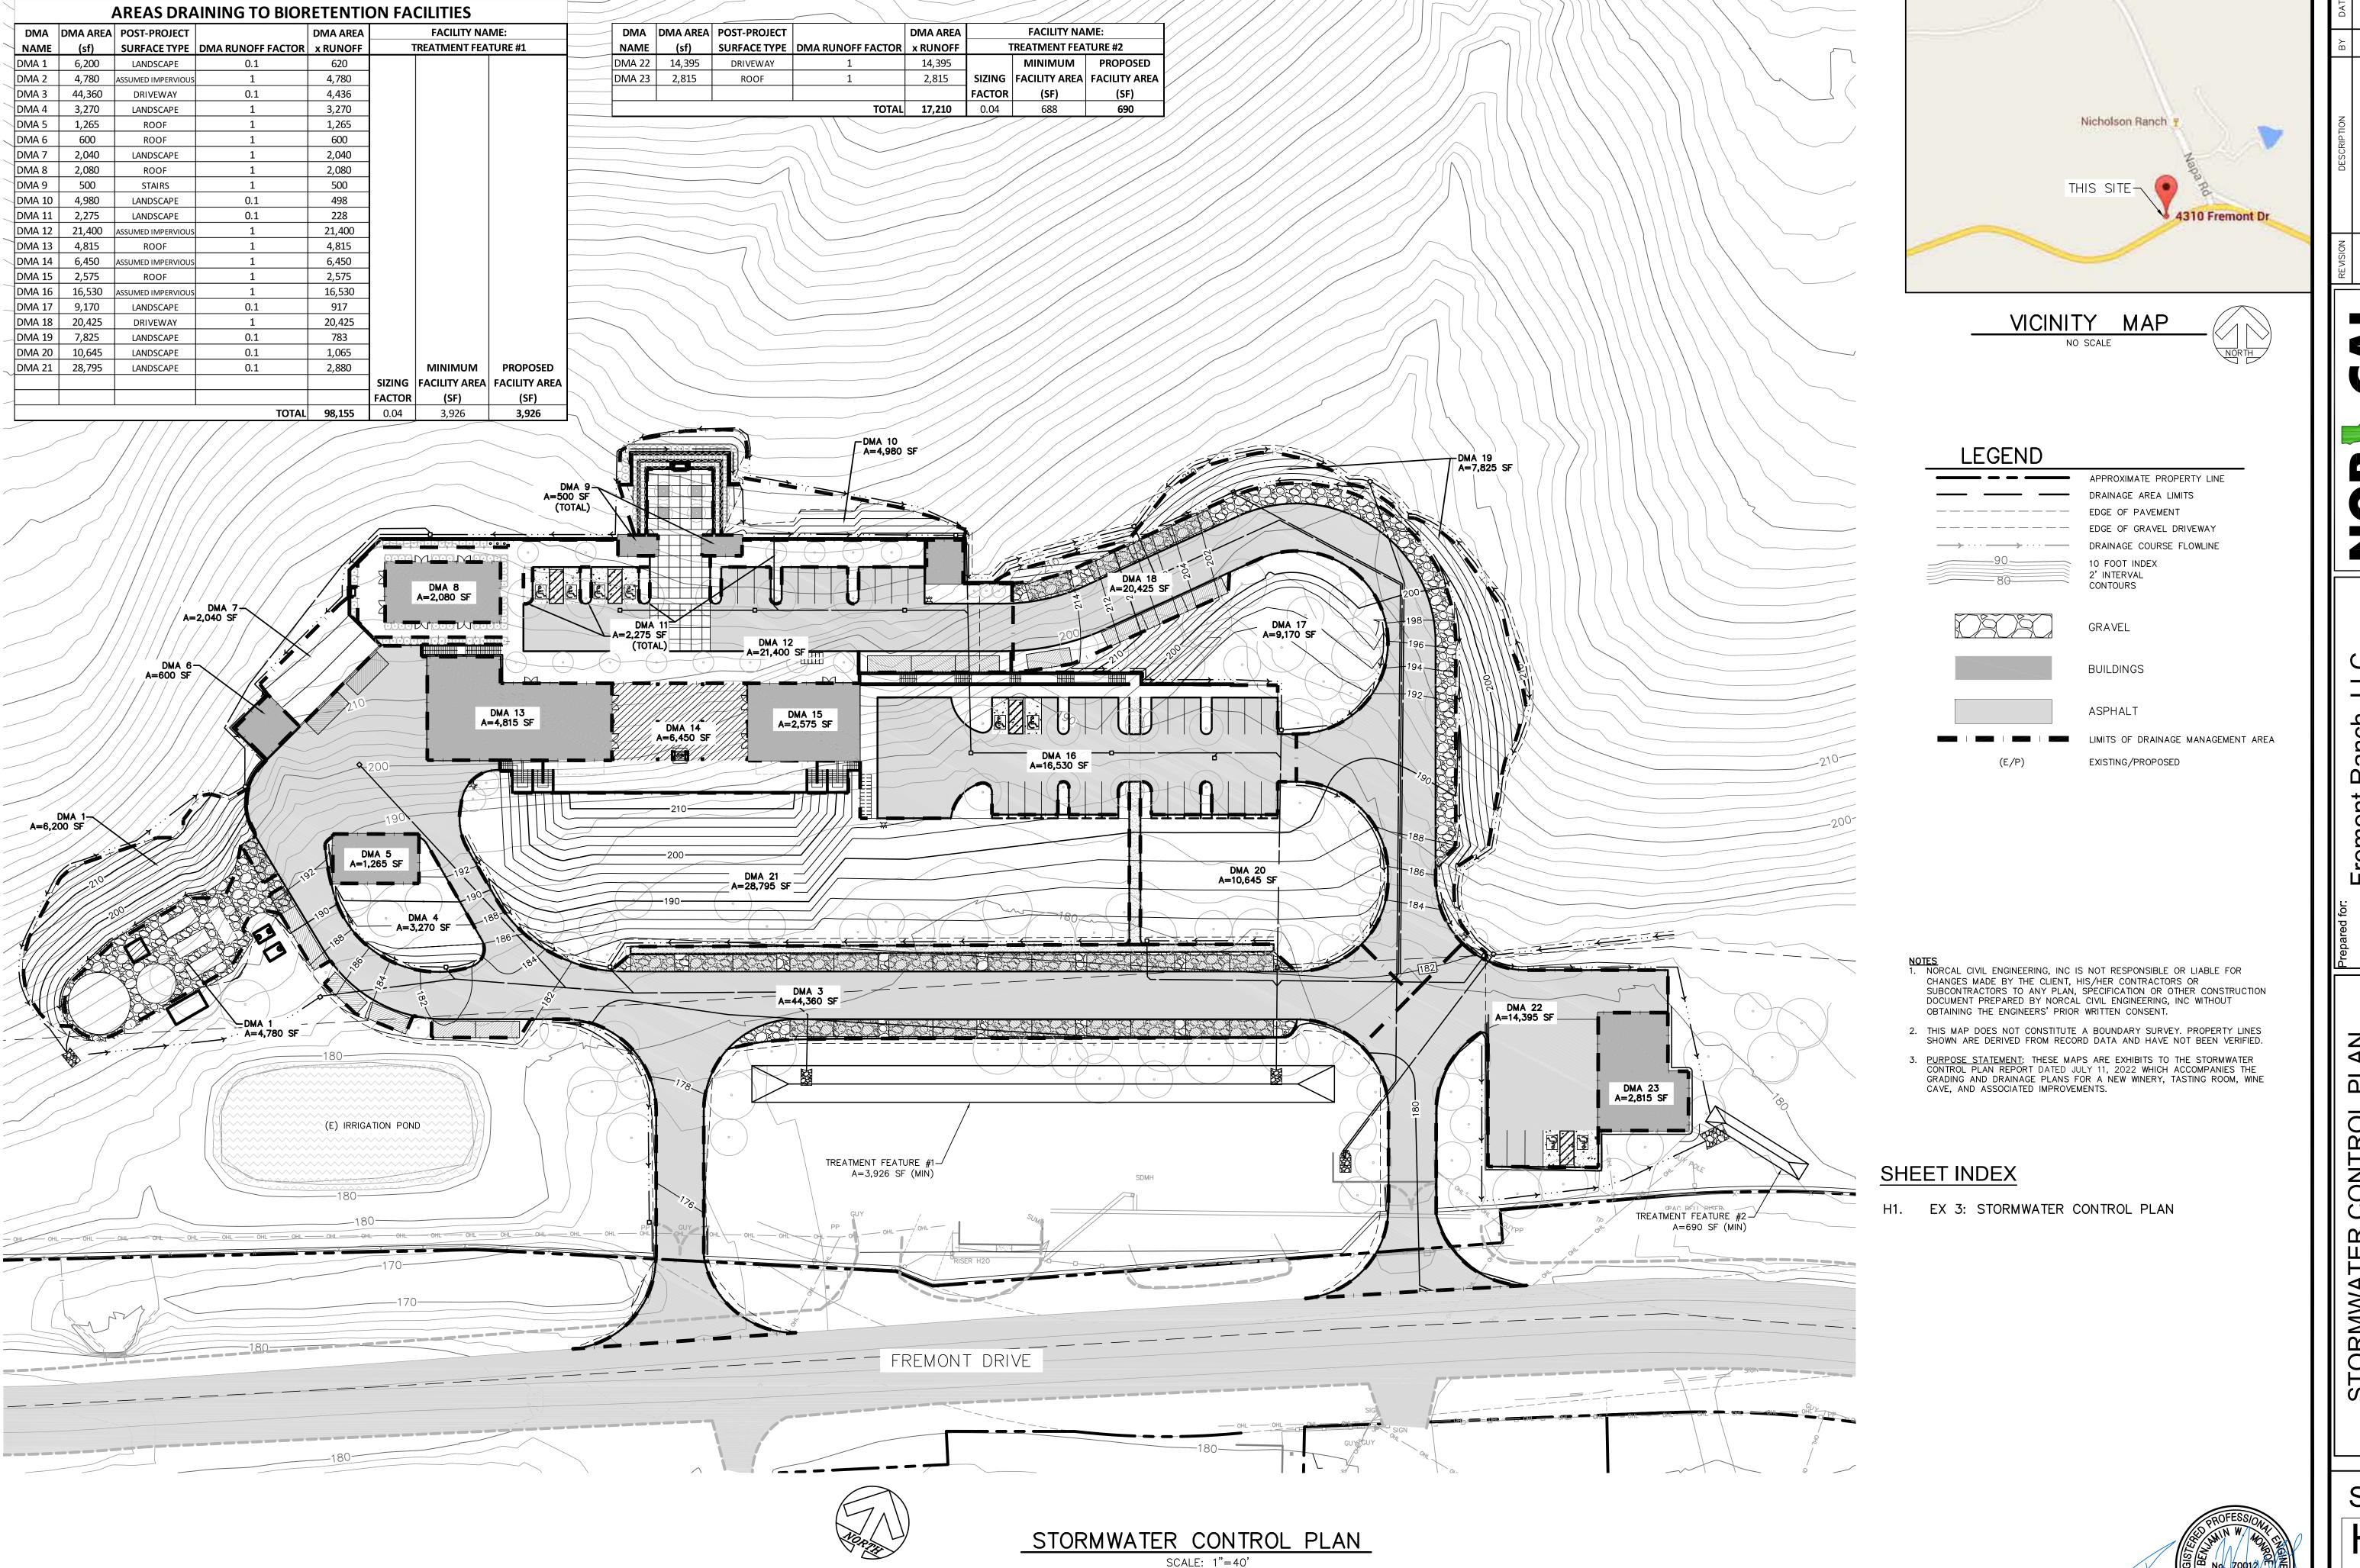

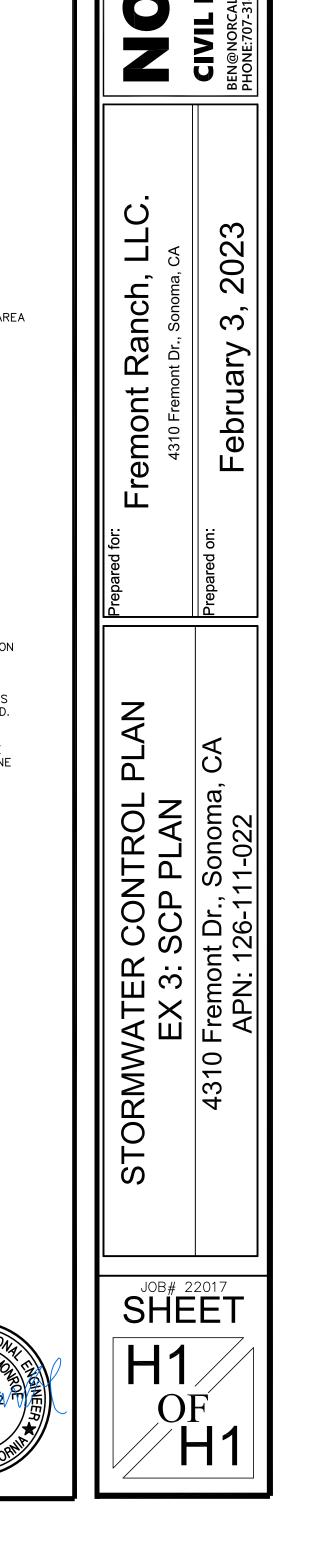

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RLA #2800 don@macnairlandscapes.com

MBOL	SIZE	BOTANICAL NAME	COMMON NAME	WATER USE PER MUCOLS IV	QUANTITY	COMMENTS
es					ļ ļ	
ARA	#24	Acer rubrum 'Armstrong'	Armstrong Maple	.6	30	
AMA	#24	Arbutus x 'Marina'	Marina Strawberry Tree	.3	8	
CCO	#24	Cercis canadensis reniformis 'Oklahoma'	Oklahoma Redbud	.3	6	
LIN	#24	Lagerstroemia indica 'Natchez'	Natchez Crapemyrtle	.3	6	
OES	#24	Olea europaea ' Swan Hill'	Fruitless Olive	.1	14	
PCK	#24	Pistacia chinensis 'Keith Davey'	Chinese pistache	.3	14	
QAG	#24	Quercus agrifolia	Coast live oak	.1	25	
QLO	#24	Quercus lobata	Valley Oak	.3	6	
ато	#24	Quercus tomentella	Island Oak	.3	27	
ubs	•			'	•	
AHA	#5	Arctostaphylos densiflora 'Harmony'	Harmony Manzanita	.3	71	
CAC	#5	Carpenteria califonica 'Elizabeth'	Elizabeth Bush Anemone	.3	30	
CEC	#5	Ceanothus x 'Concha'	Concha California Lilac	.3	12	
DDA	#5	Daphne x "DapJur01"	Perfume Princess Daphne	.3	6	
LOC	#5	Loropetalum chinense 'PIILC-III'	Purple Daydrean Dwarf Loropetalum	.3	18	
NDC	#5	Nandina domestica 'Compacta'	Dwarf Heavenly Bamboo	.3	18	
RIC	#5	Rhaphiolepis indica 'Clara'	Clara Indian Hawthorn	.3	12	
SHH	#5	Sarcococca hookeriana var. humilis 'Fragrant Valley'	Fragrant Valley Sweet Box	.3	7	
ennials	•	•		1	'	
LIP	#5	Lavandula x intermedia 'Phenomenal'	Phenomenal French Lavender	.3	37	


PLANT LEGEND									
SYMBOL	SIZE	BOTANICAL NAME	COMMON NAME	WATER USE PER WUCOLS IV	QUANTITY	COMMENTS			
Groundcover									
	#1	Cotoneaster dammeri 'Coral Beauty'	Coral Beauty Coral Beauty	0.3	103	6' OC, Triangular Spacing			
	#1	Erosion Control Hydroseed Mix	Green to Gold Blend / Pacific Coast Seed	0.3	0	55 lbs per acre			
Ornamental G	rass								
ВбВ	#1	Bouteloua gracilis 'Blonde Ambition'	Blonde Ambition Ornamental Grass	.3	138				
FMA	#1	Festuca mairei	Atlas Fescue	.3	32				
MDU	#1	Muhlenbergia dubia	Pine Muhly	.3	161				
PAL	#1	Pennisetum alopecuroides 'Little Bunny'	Little Bunny Dwarf Fountain Grass	.3	16				
Bioretention	Areas								
,	Sod	Biofiltration Sod	"Biofiltration Sod"	0.3	6928 sf±	0			
Other									
		Mulch: Fir Bark 1-1/2" Minus	Medium Walk-On Bark			3" Depth, All Landscape Areas			
See Detail		Linear Root Barrier	Root Solutions, or Equal			24" Depth, Continuous			
		California Native Wildflower Mix	Optional Add to Green to Gold Blend			8 lbs per acre			

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ETO = Annual Net Reference Evapotranspiration (Inches) 0.45 = ET Adjustment Factor (Commercial) 0.55 = ET Adjustment Factor (Residential) LA = Landscaped Area (square feet) 0.62 = Conversion factor (to gallons per square foot) SLA = Portion of the landscape area identified as Special Landscape Area (square feet) 0.45 = the additional ET adjustment factor for Special Landscape Area (1.0 - 0.55 = 0.45) (Commercial, 0.55 = the additional ET adjustment factor for Special Landscape Area (1.0 - 0.45 = 0.55) (Residential) Commercial (C) or Residential (R) Net Evapotranspiration Calculation Local Reference ETo 43.90 (Annual Rainfall) Net Evapotranspiration Calculation = Annual ETo - Effective Rainfall 36.03 Adjusted Landscape Area Calculation 24,678 sf 11,105.23 sf Adjustment Factor (Landscape Area) 0.00 sf 0.00 sf Adjustment Factor (Special Landscape Area) 11,105.23 sf Sum of Adjusted Landscape Area 248,058 gal/yr 2) Estimated Total Water Use (ETWU) Net Evapotranspiration Calculation 36.03 sf Net Evapotranspiration Calculation = Annual ETo - Effective Rainfall Adjusted Landscape Area Calculation 1,017.87 sf 101.79 sf Very Low Mater Use 22,812 sf 6,843.64 sf Low Mater Use 508.93 sf Moderate Water Use 0.00 sf 0.00 sf High Mater Use Sum of Adjusted Landscape Area 208,136 gal/yr Irrigation Efficiency Factor **Square Footage of Landscape on Drip** 24,678.29 sf Square Footage of Landscape on Spray 0.00 sf Total Square Footage of Landscape 24,678.29 sf Adjusted Irrigation Efficiency Factor 0.81

1) Maximum Applie "

HYDROSEEDED GRASSES

MANA = (ETO) (0.62) [(0.55 X LA) + (0.45 X SLA)]

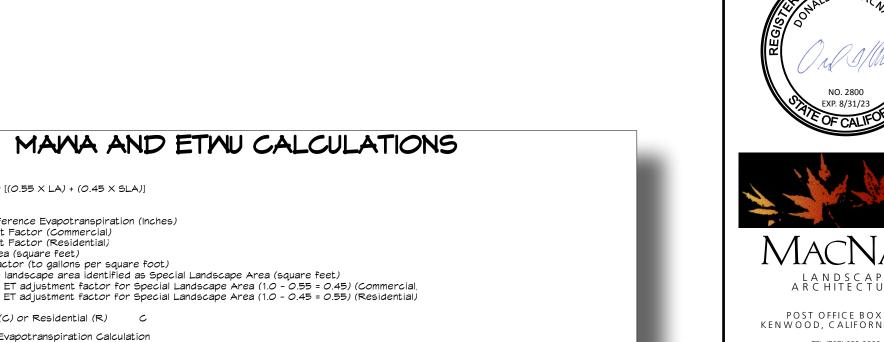

LOWER LEVEL PLANTING EAST Scale: 1" = 30'-0"

TRASH BUILDING

EXISTING POND

LOWER LEVEL PLANTING MEST Scale: 1" = 30'-0"

NON-IRRIGATED

HYDROSEEDED GRASSES -

HYDROZONE SUMMARY TABLE Water Use Value Hydrozone Area in % of Landscape Name Sub-Surface Dripline Eco-Mat Root Watering System 13,933.71 sf 6,927.52 sf 3,817.01 sf 56.5% 28.1% 15.5% oretention oretention BUBBLER 24,678 sf SUMMARY HYDROZONE TABLE 22,812.14

24,678.23